


LOCATION MAP

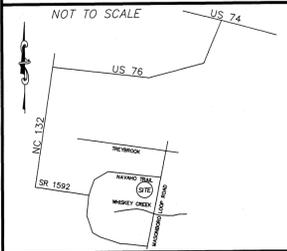

CONSTRUCTION DRAWINGS for

THE CREEK AT WILLOWICK

LOCATED IN MASONBORO TOWNSHIP
NEW HANOVER COUNTY, NORTH CAROLINA

LICENSE # C-2710
COASTAL SITE DESIGN, PC
ENGINEERING
LAND PLANNING
COMMERCIAL / RESIDENTIAL
P.O. Box 4041
Wilmington, NC 28406
(910) 791-4441

COVER SHEET for
THE CREEK AT WILLOWICK

CONSTRUCTION DRAWINGS for
THE CREEK AT WILLOWICK
LOCATED IN MASONBORO TOWNSHIP
NEW HANOVER COUNTY, NORTH CAROLINA
NHC PARCEL # 007200-007-031-000
OWNER: TSV DEVELOPERS, INC.
1904 EASTWOOD ROAD, SUITE 212
WILMINGTON, NC 28403




REV.	NO.	DATE	BY	REMARKS
6	1	10/10/13	JSL	REVISED NOTES PER TRAFFIC ENGINEERING
5	2	8/23/13	JSM	REVISED COVER SHEET PER CIVIL SUBMITTAL
4	3	7/22/13	JSM	CHANGED SHEET NUMBER, REVISED OVERALL MAP
3	4	8/28/09	RJW	REVISED PER REANNOTATION
2	5	11/12/08	JDH	REVISED PER ADDITION OF SHEETS
1	6	9/9/08	JSL	REVISED PER ADDITION OF SHEETS

DATE: 3-20-08
HORZ. SCALE: 1" = 200'
DRAWN BY: JSL
CHECKED BY: HSR
PROJECT NO: 04-001
DRAWING NO: 04-001COV-PH2

STANDARD NOTES:

- TOPOGRAPHIC AND BOUNDARY MAPPING PERFORMED BY ARNOLD CARSON, PLS, PC.
- THIS MAP IS NOT FOR CONVEYANCE, RECORDATION, OR SALES.
- THIS TRACT IS LOCATED IN ZONE "C" ACCORDING TO THE FEDERAL EMERGENCY MANAGEMENT AGENCY'S FLOOD INSURANCE RATE MAP; COMMUNITY PANEL NUMBER 372031 4500 J, DATED 4/3/06.
- THIS PROPERTY IS ZONED R-15.
- WATER SERVICE TO CONNECT TO CFWA PUBLIC SYSTEM.
- SEWER SERVICE TO CONNECT TO CFWA PUBLIC SEWER SYSTEM.
- ALL CONSTRUCTION TO CONFORM TO CITY OF WILMINGTON STANDARDS APPLICABLE STATE & LOCAL CODES.
- CONTRACTOR TO COORDINATE ANY REQUIRED TRAFFIC CONTROL WITH CITY OF WILMINGTON.
- CARE SHALL BE TAKEN DURING FINAL GRADING TO ENSURE POSITIVE DRAINAGE AWAY FROM BUILDINGS AND TO RECEIVING STRUCTURES. ROOF DRAIN DOWNSPOUTS TO BE CONNECTED TO STORM DRAINAGE STUBOUTS OR DIRECTED TO STREET.
- CONTRACTOR IS RESPONSIBLE FOR COORDINATION OF ANY RELOCATIONS, RE-ALIGNMENTS, DISCONNECTIONS OR CONNECTIONS OF EXISTING UTILITIES WITH APPLICABLE AUTHORITIES.
- CLEARING AND GRUBBING OF SITE TO INCLUDE REMOVAL OF EXISTING CURB, ASPHALT, INLETS, AND ANY OTHER STRUCTURES INCLUDING TREES, STUMPS AND DEBRIS EXISTING ON SITE. TREES NOT REQUIRED TO BE CLEARED FOR CONSTRUCTION SHALL REMAIN UNLESS OTHERWISE DIRECTED.
- INFORMATION CONCERNING UNDERGROUND UTILITIES WAS OBTAINED FROM AVAILABLE RECORDS. IT SHALL BE THE RESPONSIBILITY OF THE CONTRACTOR TO DETERMINE THE EXACT ELEVATIONS AND LOCATIONS OF ALL EXISTING UTILITIES AT ALL CROSSINGS PRIOR TO COMMENCING TRENCH EXCAVATION. IF ACTUAL CLEARANCES ARE LESS THAN INDICATED ON PLAN, THE CONTRACTOR SHALL CONTACT THE DESIGN ENGINEER BEFORE PROCEEDING WITH CONSTRUCTION. ANY CONDITION DISCOVERED OR EXISTING THAT WOULD NECESSITATE A MODIFICATION OF THESE PLANS SHALL BE BROUGHT TO THE ATTENTION OF THE DESIGN ENGINEER BEFORE PROCEEDING WITH CONSTRUCTION.
- NO CONSTRUCTION IS TO BEGIN BEFORE LOCATION OF EXISTING UTILITIES HAS BEEN DETERMINED. CALL "NO ONE-CALL" AT LEAST 48 HOURS BEFORE COMMENCING CONSTRUCTION.
- CONTRACTOR SHALL ADJUST ALL MANHOLES, VALVE & CURB BOXES TO FINAL GRADE UPON COMPLETION OF ALL CONSTRUCTION. ANY BOXES DAMAGED OR OTHERWISE DISTURBED BY THE CONTRACTOR SHALL BE REPAIRED AT THE EXPENSE OF THE CONTRACTOR.
- THE CONTRACTOR IS RESPONSIBLE FOR CONTROLLING DUST AND EROSION DURING CONSTRUCTION AT HIS EXPENSE. PARKING AREAS SHALL BE WATERED TO CONTROL DUST WHEN ORDERED BY THE ENGINEER.
- NO GEOTECHNICAL TESTING HAS BEEN PERFORMED ON SITE. NO WARRANTY IS MADE FOR SUITABILITY OF SUBGRADE, AND UNDERCUT AND ANY REQUIRED REPLACEMENT WITH SUITABLE MATERIAL SHALL BE THE RESPONSIBILITY OF THE CONTRACTOR.
- EXTREME CARE SHALL BE TAKEN TO ENSURE MINIMUM SEPARATIONS AT ALL UTILITY CROSSINGS.
- CONTRACTOR TO ENSURE THAT PAVEMENT IS PLACED SO AS TO DRAIN POSITIVELY TO THE STREET INLETS AND CATCH BASINS. ALL FUTURE ROOF DRAIN DOWNSPOUTS TO BE DIRECTED TO THE STORM SEWER STUBOUTS.
- CONTRACTOR IS RESPONSIBLE FOR OBTAINING ALL REQUIRED PERMITS.
- THIS PLAN IS FOR SITE GRADING AND DRAINAGE ONLY.
- CONTRACTOR AND BUILDER ARE RESPONSIBLE FOR COORDINATING FINISHED FLOOR ELEVATION OF ALL BUILDINGS WITH THE OWNER. ELEVATIONS GIVEN ARE MINIMUM GROUND ELEVATIONS AT THE BUILDING SITE AND DO NOT PURPORT TO BE FINISHED FLOOR.
- AFFECTED NON-MUNICIPAL UTILITIES SHALL BE CONTACTED AND PROVIDED WITH PLANS AND OTHER PERTINENT INFORMATION, WHEN FEASIBLE, TO COORDINATE APPROPRIATE SCHEDULING AND PLACEMENT.
- MINIMUM SEPARATION SHALL BE MAINTAINED AS FOLLOWS:
 - HORIZONTAL CLEARANCE OF 10 FEET BETWEEN SANITARY SEWER AND WATER MAINS.
 - WHERE VERTICAL CLEARANCE IS LESS THAN 24" BETWEEN SANITARY SEWER AND WATER OR WHERE SEWER LINE CROSSES ABOVE WATER MAIN, BOTH PIPES SHALL BE DUCTILE IRON PIPE FOR A MINIMUM OF 10' EITHER SIDE OF CROSSING.
 - WHERE VERTICAL CLEARANCE IS LESS THAN 24" BETWEEN SANITARY SEWER AND STORM DRAIN, SANITARY SEWER SHALL BE DUCTILE IRON PIPE FOR A MINIMUM OF 10' EITHER SIDE OF CROSSING.
 - WHERE VERTICAL CLEARANCE IS LESS THAN 24" BETWEEN WATER MAIN AND STORM DRAIN, WATER MAIN SHALL BE DUCTILE IRON PIPE FOR A MINIMUM OF 10' EITHER SIDE OF CROSSING.
- PRIOR TO ANY CLEARING, GRADING OR CONSTRUCTION ACTIVITY, TREE PROTECTION FENCING WILL BE INSTALLED AROUND PROTECTED TREES OR GROVES OF TREES AND NO CONSTRUCTION WORKERS, TOOLS, MATERIALS, OR VEHICLES ARE PERMITTED WITHIN THE TREE PROTECTION FENCING.
- ALL PAVEMENT MARKINGS IN PUBLIC RIGHTS-OF-WAY AND FOR DRIVEWAYS ARE TO BE THERMOPLASTIC AND MEET CITY AND/OR NCDOT STANDARDS.
- ONCE STREETS ARE OPEN TO TRAFFIC CONTACT TRAFFIC ENGINEERING TO REQUEST INSTALLATION OF TRAFFIC AND STREET NAME SIGNS. PROPOSED STREET NAMES MUST BE APPROVED PRIOR TO INSTALLATION OF STREET NAME SIGNS.
- ALL SIGNS AND PAVEMENT MARKINGS IN AREAS OPEN TO PUBLIC TRAFFIC ARE TO MEET MUTCD (MANUAL ON UNIFORM TRAFFIC CONTROL DEVICES) STANDARDS.
- CALL TRAFFIC ENGINEERING AT 341-7888 FORTY-EIGHT HOURS PRIOR TO ANY EXCAVATION IN THE RIGHT OF WAY.
- ANY BROKEN OR MISSING SIDEWALK PANELS AND CURBING WILL BE REPLACED.
- ALL SLOPES SHALL BE NO STEEPER THAN 3:1.
- NO EQUIPMENT IS ALLOWED ON THE SITE UNTIL ALL TREE PROTECTION FENCING AND SILT FENCING HAS BEEN INSTALLED AND APPROVED.

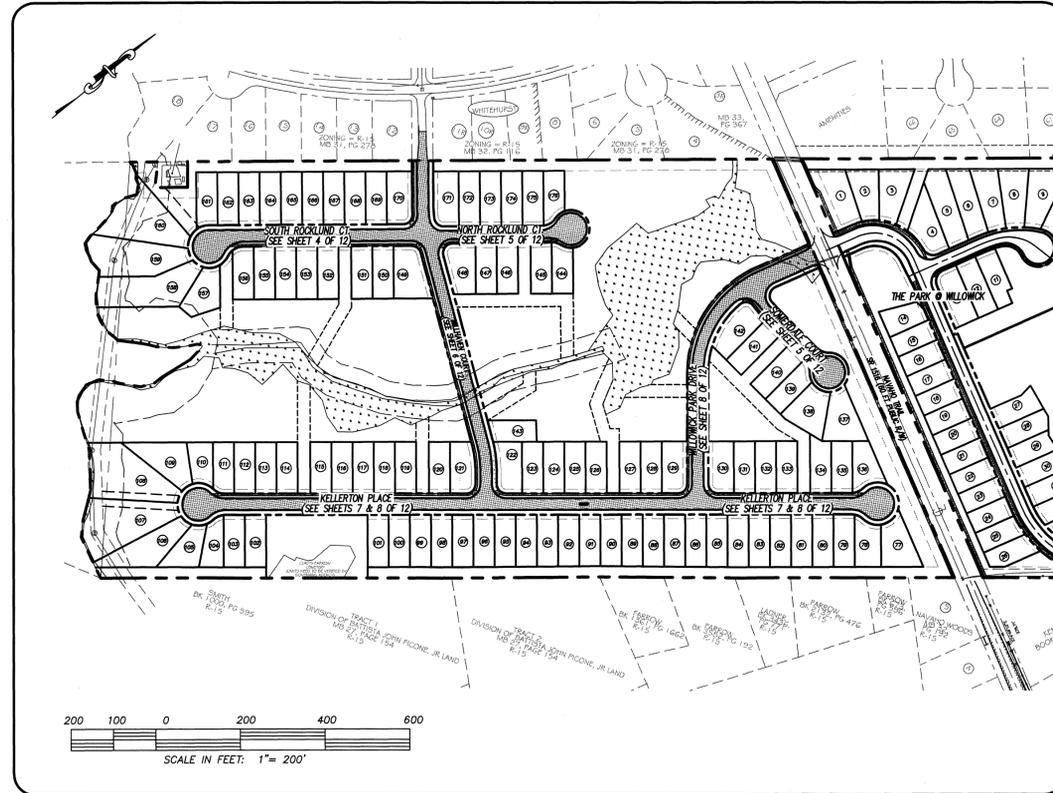

Approved Construction Plan

Name _____ Date _____

Planning _____

Public Utilities _____

Traffic _____

Fire _____

For each open utility cut of City streets, a \$325 permit shall be required from the City prior to occupancy and/or project acceptance.

STORMWATER MANAGEMENT PLAN APPROVED

CITY OF WILMINGTON
ENGINEERING DEPARTMENT
DATE _____ PERMIT # _____
SIGNED _____

LEGEND


- EXISTING BOUNDARY
- CENTERLINE OF RIGHT OF WAY
- CONTOUR LINE & ELEVATION
- DRAINAGE FLOW
- EXISTING SANITARY SEWER & MANHOLE
- EXISTING WATERLINE
- EXISTING / PROPOSED STORM SEWER & CATCH BASIN
- E.I.P. EXIST. IRON PIPE
- WATER METER SERVICE CONNECTION
- E.C.M. EXIST. CONCRETE MONUMENT
- HANDICAP RAMP
- 40.9 EX. ELEV. & DESCRIPTION

OWNER/ DEVELOPER: TSV DEVELOPERS, INC
1904 EASTWOOD ROAD
SUITE 212
WILMINGTON, NC 28403

INDEX TO DRAWINGS


SHEET No.	DESCRIPTION	DRAWING No.
1 OF 12	COVER SHEET	04-001COV
2 OF 12	EXISTING BOUNDARY AND TOPOGRAPHY	04-001TOP
3 OF 12	SITE PLAN	04-001SP1
4 OF 12	SOUTH ROCKLUND CT. & SEWER EXTENSION	04-001PP1
5 OF 12	NORTH ROCKLUND COURT & SOMERDALE COURT	04-001PP2
6 OF 12	WILHAVEN COURT	04-001PP3
7 OF 12	KELLERTON PLACE	04-001PP4
8 OF 12	KELLERTON PLACE & WILLOWICK PARK DRIVE	04-001PP5
9 OF 12	SEWER EXTENSION	04-001PP6
10 OF 12	UTILITY PLAN	04-001UTIL
11 OF 12	SIGNAGE PLAN	04-001SIGN
12 OF 12	TREE REMOVAL & CLEARING PLAN	04-001SP3
1 OF 2	CFWA WATER DETAIL SHEET 1	WATER_DET1
2 OF 2	CFWA WATER DETAIL SHEET 2	WATER_DET2
1 OF 4	CFWA SEWER DETAIL SHEET 1	SEWER_DET1
2 OF 4	CFWA SEWER DETAIL SHEET 2	SEWER_DET2
3 OF 4	CFWA SEWER DETAIL SHEET 3	SEWER_DET3
4 OF 4	CFWA SEWER DETAIL SHEET 4	SEWER_DET4
1 OF 3	STORMWATER MANAGEMENT, EROSION CONTROL AND OVERALL DRAINAGE PLAN	04-001ECP1
2 OF 3	STORMWATER MANAGEMENT, EROSION CONTROL AND OVERALL DRAINAGE PLAN	04-001ECP2
3 OF 3	EROSION CONTROL DETAILS	04-001ECP3
1 OF 3	OVERALL DRAINAGE AREA MAP	04-001DA1
2 OF 3	OVERALL DRAINAGE AREA MAP	04-001DA2
3 OF 3	OVERALL DRAINAGE AREA MAP	04-001DA3

LOCATION MAP

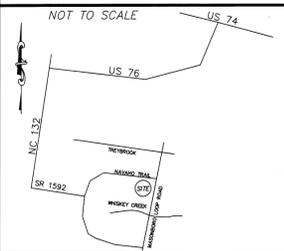

LINE	BEARING	LENGTH
L267	N77°39'08"W	41.74'
L268	N78°24'14"W	63.44'
L269	N47°19'51"W	32.68'
L270	N36°57'50"W	81.86'
L271	N53°28'57"W	40.83'
L272	N54°20'08"W	26.97'
L273	N46°23'37"W	18.79'
L274	N68°42'52"W	23.78'
L275	N69°44'44"W	25.76'
L276	N68°00'01"W	22.93'
L277	N67°38'59"W	26.30'
L278	N53°46'41"W	25.23'
L279	N34°08'47"W	15.08'
L280	N16°30'16"W	29.29'
L281	N15°36'56"E	31.50'
L282	N4°25'03"E	30.84'
L283	N56°16'27"E	17.92'
L284	N50°18'10"E	18.95'
L285	N47°38'44"E	33.89'
L286	N24°03'04"E	32.49'
L287	N01°12'12"E	26.02'
L288	N07°48'16"E	27.48'
L289	N07°06'22"E	48.09'
L290	N08°43'56"W	39.85'
L291	N46°43'31"W	4.03'
L292	S75°16'35"W	3.56'
L293	S48°22'05"W	8.06'
L294	S29°26'04"W	31.03'
L295	S33°04'31"W	25.88'
L296	S40°05'59"W	22.48'
L297	S43°43'42"W	17.04'
L298	S51°48'28"W	21.00'
L299	S48°37'20"W	30.23'
L300	S44°47'07"W	41.92'
L301	S83°14'30"W	10.40'

LINE	BEARING	LENGTH
L302	S77°00'23"W	20.84'
L303	N86°05'04"W	29.30'
L304	N73°50'13"W	19.19'
L305	N59°26'49"W	25.08'
L306	N51°26'42"W	21.76'
L307	N43°08'32"W	55.15'
L308	S86°45'42"W	27.75'
L309	N72°41'49"W	13.26'
L310	N77°51'46"W	17.40'
L311	N59°38'27"W	8.50'
L312	N59°22'28"W	6.73'
L313	N16°52'06"W	11.37'
L314	N13°49'58"W	14.98'
L315	N02°28'08"W	15.95'
L316	N09°48'15"W	16.19'
L317	N06°52'21"W	16.48'
L318	N15°01'23"W	15.04'
L319	N20°11'26"W	10.46'
L320	N52°34'23"W	10.44'
L321	N02°24'10"E	10.58'
L322	N08°56'33"E	17.59'
L323	N08°14'09"E	8.61'
L324	N23°42'38"E	27.03'
L325	N40°47'06"W	24.26'
L326	N75°38'23"W	13.29'
L327	N50°27'53"W	14.02'
L328	N75°33'01"W	21.09'
L329	S86°17'54"W	9.06'

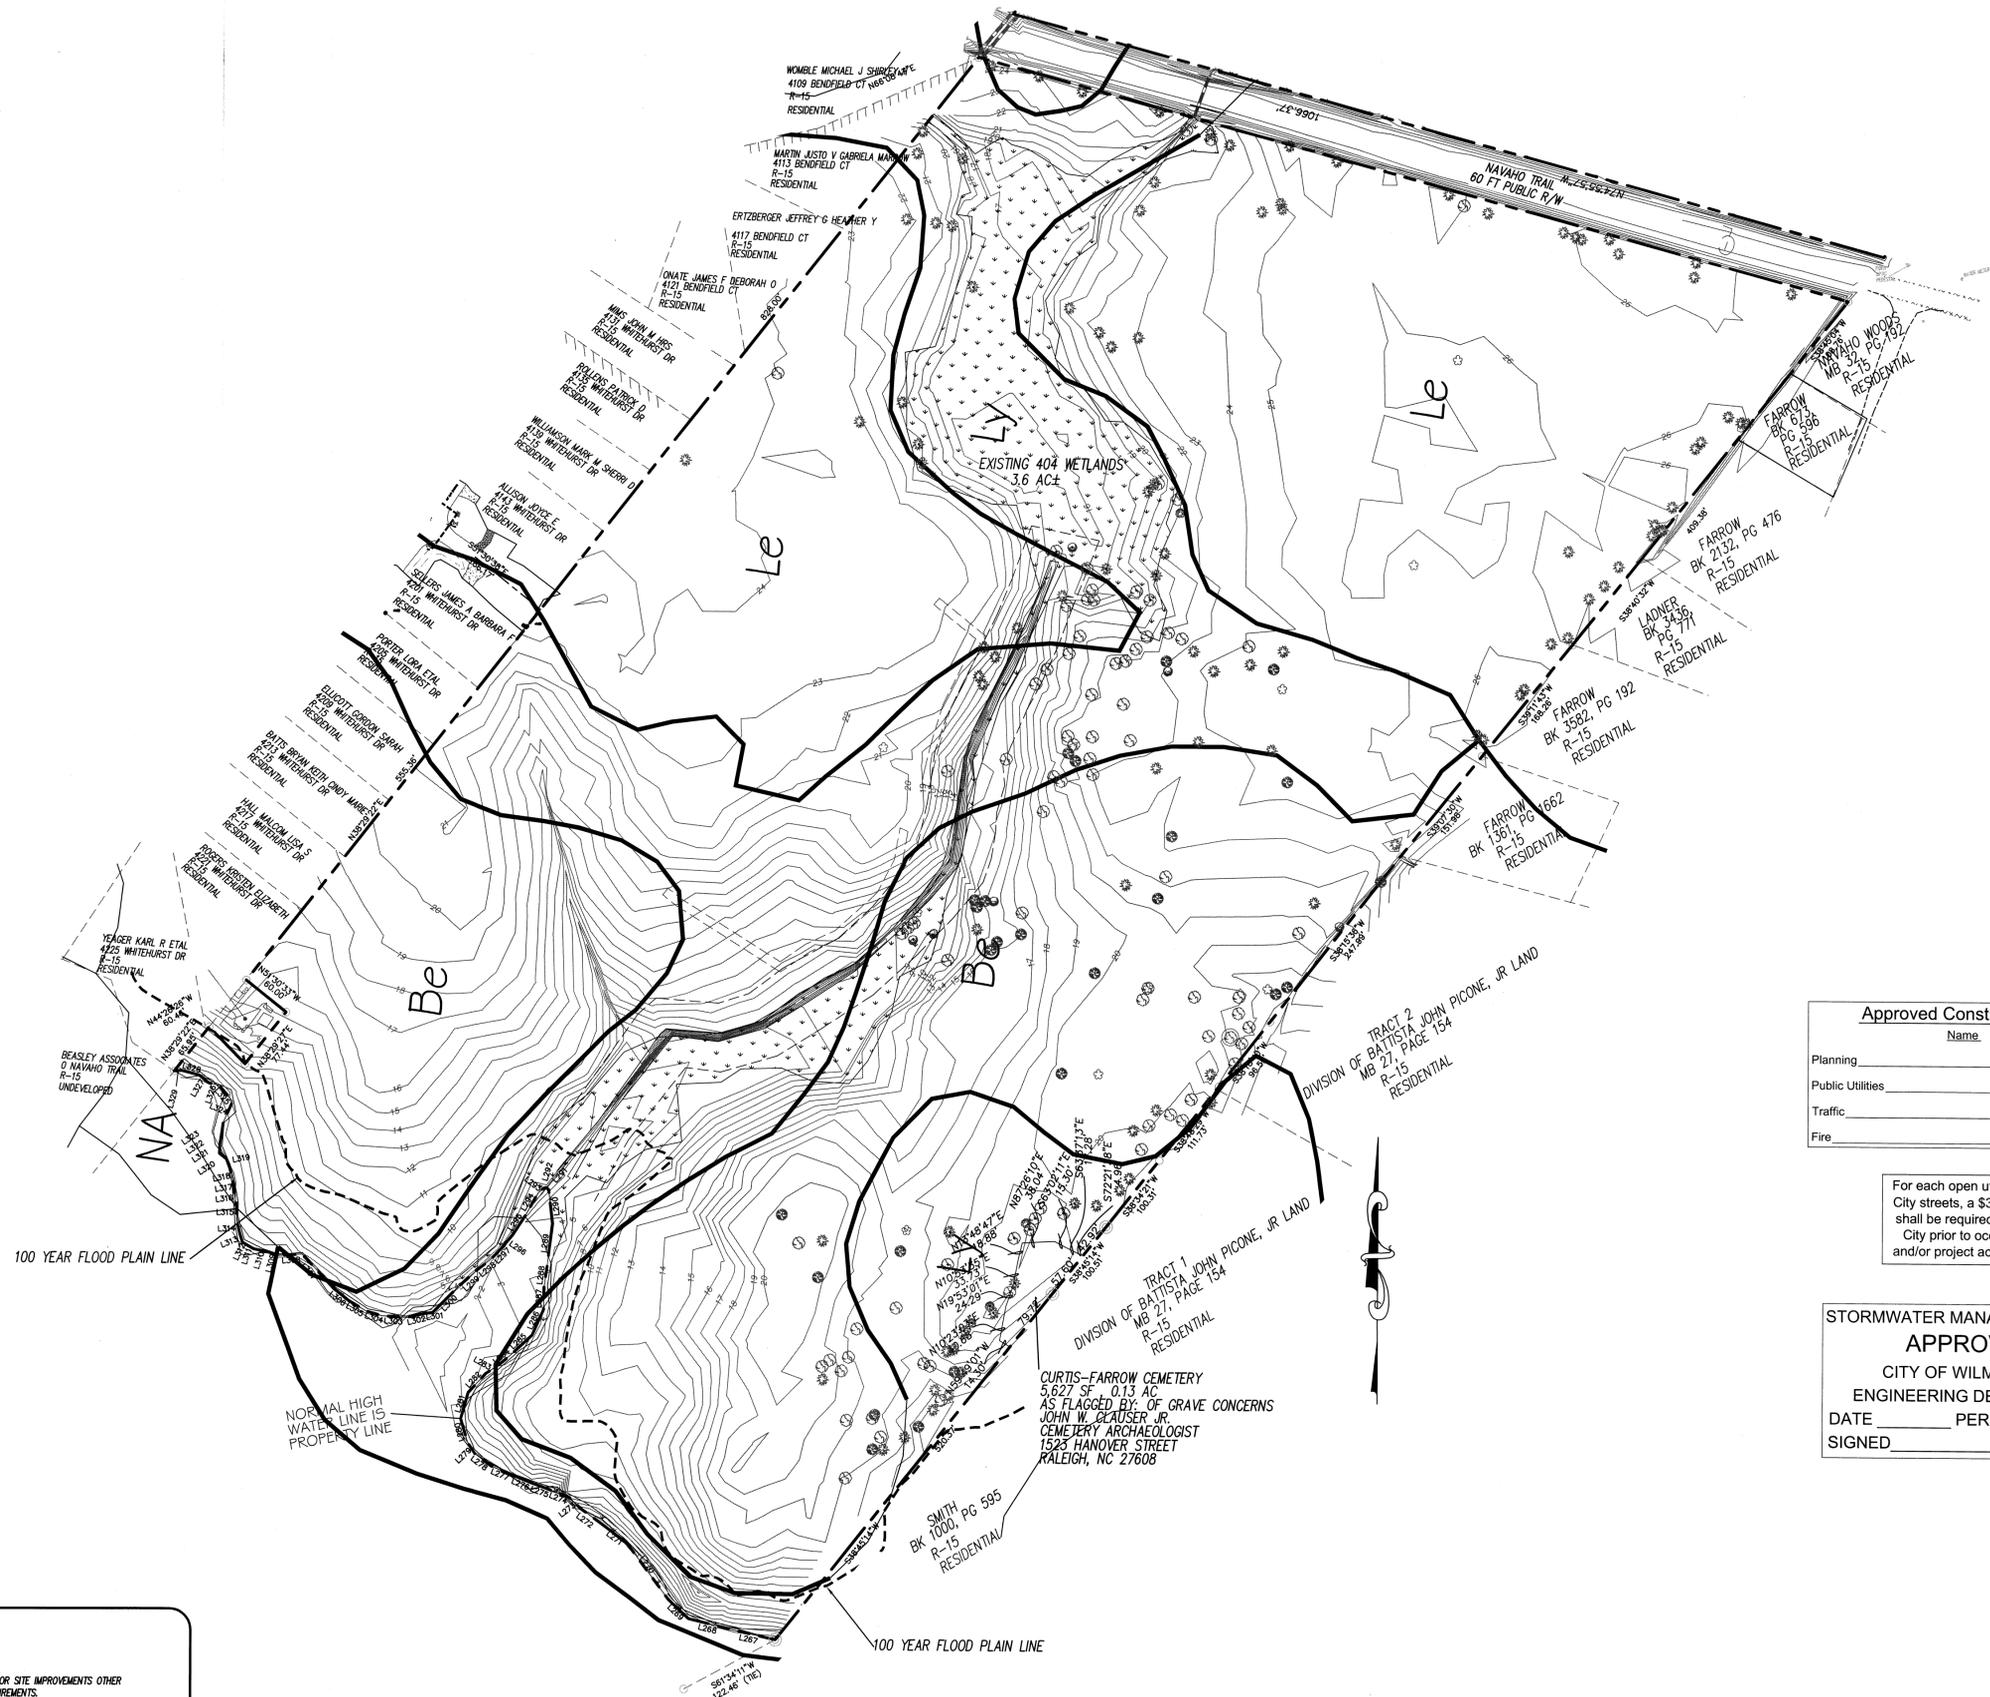

- NOTES**
- BOUNDARY, TREE AND TOPOGRAPHY INFORMATION PREPARED AND PROVIDED BY ARNOLD CARSON, PLS, PC.
 - THIS PLAN SHEET DOES NOT PURPORT TO SHOW ANY DESIGN INFORMATION, BUT RATHER ONLY DISPLAYS THE EXISTING SITE BOUNDARY, METLANDS AND TOPOGRAPHY AS PROVIDED BY THE SURVEYOR.

- ENVIRONMENTAL NOTES:**
- ALL SIGNIFICANT TREES ON SITE ARE TO BE RETAINED OR MITIGATED.
 - NO LAND DISTURBANCE IS PERMITTED OUTSIDE THE DESIGNATED LIMITS OF DISTURBANCE FOR SITE IMPROVEMENTS OTHER THAN WHAT IS NECESSARY TO THE INTO EXISTING CONTOURS OR MEET LANDSCAPING REQUIREMENTS.
 - ALL TREES OUTSIDE THE LIMITS OF DISTURBANCE ON SITE ARE TO BE PRESERVED.
 - TREE WELLS TO BE PROVIDED AND INSTALLED AS NECESSARY TO MAINTAIN EXISTING GRADE AT ROOT ZONE (TREE CANOPY) OF TREES TO BE PRESERVED.
 - 3.60 AC OF METLANDS ON SITE.
 - WATER BODY SERVING THIS SITE IS WHISKEY CREEK SA;HOW.

Approved Construction Plan

Name _____ Date _____

Planning _____

Public Utilities _____

Traffic _____

Fire _____


For each open utility cut of City streets, a \$325 permit shall be required from the City prior to occupancy and/or project acceptance.

STORMWATER MANAGEMENT PLAN
APPROVED

CITY OF WILMINGTON
ENGINEERING DEPARTMENT

DATE _____ PERMIT # _____

SIGNED _____

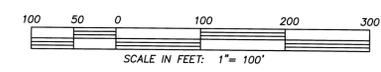

LICENSE # C-2710
COASTAL SITE DESIGN, PC
ENGINEERING
LAND PLANNING
COMMERCIAL / RESIDENTIAL
P.O. Box 4041
Wilmington, NC 28406
(910) 791-4441

EXISTING BOUNDARY AND TOPOGRAPHY for
THE CREEK AT WILLOWICK

EXISTING BOUNDARY AND TOPOGRAPHY for
THE CREEK AT WILLOWICK
LOCATED IN MASONBORO TOWNSHIP
NEW HANOVER COUNTY, NORTH CAROLINA

OWNER: TSV DEVELOPERS, INC.
1904 EASTWOOD ROAD, SUITE 212
WILMINGTON, NC 28403



REV. NO.	DATE	BY	REMARKS
8	7/22/13	JSL	REVISED PER CITY SUBMITTAL
7	7/10/12	RLW	ADDED LICENSE NUMBER
6	8/28/09	RLW	REVISED SHEET NUMBER
5	11/12/08	JSL	REVISED PER REANNOTATION
4	9/9/08	JSL	REVISED PER ADDITION OF SHEET
3	3/20/08	JSL	REVISED PER CONSTRUCTION SET
2	8/01/07	JSL	REVISED PER PRELIMINARY METERS
1	10/10/13	RLW	REVISED DRAINAGE PLAN STAMP

DATE: 02-28-07
HORZ. SCALE: 1" = 100'
DRAWN BY: JSL
CHECKED BY: HSR
PROJECT NO: 04-0011
DRAWING NO: 04-0011TOP-PH2

LOCATION MAP



STANDARD NOTES:

1. TOPOGRAPHIC AND BOUNDARY MAPPING PERFORMED BY ARNOLD CARSON, PLS. PC. THIS MAP IS NOT FOR CONVEYANCE, RECORDATION, OR SALES.
2. THIS TRACT IS LOCATED IN ZONE "C" ACCORDING TO THE FEDERAL EMERGENCY MANAGEMENT AGENCY'S FLOOD INSURANCE RATE MAP, COMMUNITY PANEL NUMBER 37031 4500 4, DATED 4/3/06.
3. THIS PROPERTY IS ZONED R-15.
4. WATER SERVICE TO CONNECT TO CPPIA PUBLIC SYSTEM.
5. SEWER SERVICE TO CONNECT TO CPPIA PUBLIC SEWER SYSTEM.
6. ALL CONSTRUCTION TO CONFORM TO CITY OF WILMINGTON STANDARDS APPLICABLE STATE & LOCAL.
7. CONTRACTOR TO COORDINATE ANY REQUIRED TRAFFIC CONTROL WITH CITY OF WILMINGTON AND/OR NCDOT.
8. CARE SHALL BE TAKEN DURING FINAL GRADING TO ENSURE POSITIVE DRAINAGE AWAY FROM BUILDINGS AND TO RESERVE STRUCTURES. ROOF DRAIN DOWNSPUTS TO BE CONNECTED TO STORM DRAINAGE SUBROUTS OR DIRECTED TO STREET.
9. CONTRACTOR IS RESPONSIBLE FOR COORDINATION OF ANY RELOCATIONS, RE-ALIGNMENTS, DISCONNECTIONS OR CONNECTIONS OF EXISTING UTILITIES WITH APPLICABLE AUTHORITIES.
10. NO AREA DESIGNATED AS OPEN SPACE SHALL BE CLEAR-CUT, CLEARING AND GRADING SHALL BE LIMITED TO THAT NECESSARY FOR ESSENTIAL SITE IMPROVEMENTS. TREES SHALL NOT BE REMOVED FROM INDIVIDUAL HOME SITES UNTIL BUILDING PERMITS ARE ISSUED.
11. INFORMATION CONCERNING UNDERGROUND UTILITIES WAS OBTAINED FROM AVAILABLE RECORDS. IT SHALL BE THE RESPONSIBILITY OF THE CONTRACTOR TO DETERMINE THE EXACT ELEVATIONS AND LOCATIONS OF ALL EXISTING UTILITIES AT ALL CROSSINGS PRIOR TO COMMENCING TRENCH EXCAVATION. IF ACTUAL CLEARANCES ARE LESS THAN INDICATED ON PLAN, THE CONTRACTOR SHALL CONTACT THE DESIGN ENGINEER BEFORE PROCEEDING WITH CONSTRUCTION. ANY CONDITION DISCOVERED OR EXISTING THAT WOULD NECESSITATE A MODIFICATION OF THESE PLANS SHALL BE BROUGHT TO THE ATTENTION OF THE DESIGN ENGINEER BEFORE PROCEEDING WITH CONSTRUCTION.
12. NO CONSTRUCTION IS TO BEGIN BEFORE LOCATION OF EXISTING UTILITIES HAS BEEN DETERMINED. CALL "NO ONE-CALL" AT LEAST 48 HOURS BEFORE COMMENCING CONSTRUCTION.
13. CONTRACTOR SHALL ADJUST ALL MANHOLES, VALVE & CURB BOXES TO FINAL GRADE UPON COMPLETION OF ALL CONSTRUCTION. ANY BOXES DAMAGED OR OTHERWISE DISTURBED BY THE CONTRACTOR MUST BE REPAIRED AT THE EXPENSE OF THE CONTRACTOR.
14. THE CONTRACTOR IS RESPONSIBLE FOR CONTROLLING DUST AND EROSION DURING CONSTRUCTION AT HIS EXPENSE. PARKING AREAS SHALL BE WATERED TO CONTROL DUST WHEN ORDERED BY THE ENGINEER.
15. NO GEOTECHNICAL TESTING HAS BEEN PERFORMED ON SITE. NO WARRANTY IS MADE FOR SUITABILITY OF SUBGRADE, AND UNDERCUT AND ANY REQUIRED REPLACEMENT WITH SUITABLE MATERIAL SHALL BE THE RESPONSIBILITY OF THE CONTRACTOR.
16. EXTREME CARE SHALL BE TAKEN TO ENSURE MINIMUM SEPARATIONS AT ALL UTILITY CROSSINGS.
17. CONTRACTOR TO ENSURE THAT PAVEMENT IS PLACED SO AS TO DRAIN POSITIVELY TO THE STREET INLETS AND CATCH BASINS. ALL FUTURE ROOF DRAIN DOWNSPUTS TO BE DIRECTED TO THE STORM SEWER SUBROUTS.
18. CONTRACTOR IS RESPONSIBLE FOR OBTAINING ALL REQUIRED PERMITS.
19. CONTRACTOR AND BUILDER ARE RESPONSIBLE FOR COORDINATING FINISHED FLOOR ELEVATION OF ALL BUILDINGS WITH THE OWNER. ELEVATIONS GIVEN ARE MINIMUM GROUND ELEVATIONS AT THE BUILDING SITE AND DO NOT PURPORT TO BE FINISHED FLOOR.
20. AFFECTED NON-MUNICIPAL UTILITIES SHALL BE CONTACTED AND PROVIDED WITH PLANS AND OTHER PERTINENT INFORMATION, WHEN FEASIBLE, TO COORDINATE APPROPRIATE SCHEDULING AND PLACEMENT.
21. PRIOR TO ANY CLEARING, GRADING OR CONSTRUCTION ACTIVITY, TREE PROTECTION FENCING WILL BE INSTALLED AROUND PROTECTED TREES OR GROVES OF TREES AND NO CONSTRUCTION WORKERS, TOOLS, MATERIALS, OR VEHICLES ARE PERMITTED WITHIN THE TREE PROTECTION FENCING.
22. ALL PAVEMENT MARKINGS IN PUBLIC RIGHTS-OF-WAY AND/OR NCDOT STANDARDS.
23. ONCE STREETS ARE OPEN TO TRAFFIC, CONTACT TRAFFIC ENGINEERING TO REQUEST INSTALLATION OF TRAFFIC AND STREET NAME SIGNS. PROPOSED STREET NAMES MUST BE APPROVED PRIOR TO INSTALLATION OF STREET NAME SIGNS.
24. ALL SIGNS AND PAVEMENT MARKINGS IN AREAS OPEN TO PUBLIC TRAFFIC ARE TO MEET MUTCD (MANUAL ON UNIFORM TRAFFIC CONTROL DEVICES) STANDARDS.
25. CALL TRAFFIC ENGINEERING AT 341-7888 FORTY-EIGHT HOURS PRIOR TO ANY EXCAVATION IN THE RIGHT OF WAY.
26. ANY BROKEN OR MISSING SIDEWALK PANELS AND CURBING WILL BE REPLACED.
27. ALL SIDELOSSES SHALL BE NO STEEPER THAN 3:1.
28. NO EQUIPMENT IS ALLOWED ON THE SITE UNTIL ALL TREE PROTECTION FENCING AND SILT FENCING HAS BEEN INSTALLED AND APPROVED.
29. IT SHALL BE THE RESPONSIBILITY OF THE SUBMITTER TO ERECT OFFICIAL STREET NAME SIGNS AT ALL INTERSECTIONS ASSOCIATED WITH THE SUBDIVISION IN ACCORDANCE WITH THE TECHNICAL STANDARDS AND SPECIFICATIONS MANUAL. THE SUBMITTER MAY ACQUIRE AND ERECT OFFICIAL STREET NAME SIGNS OR MAY CHOOSE TO CONTRACT WITH THE CITY TO INSTALL THE STREET SIGNS AND THE SUBMITTER SHALL PAY THE COST OF SUCH INSTALLATION. CONTACT TRAFFIC ENGINEERING AT 341-7888 TO DISCUSS INSTALLATION OF TRAFFIC AND STREET NAME SIGNS. PROPOSED STREET NAMES MUST BE APPROVED PRIOR TO INSTALLATION OF STREET NAME SIGNS.

WAIVERS GRANTED

1. WAIVERS OF THE TECHNICAL STANDARDS REQUIREMENTS FOR MAXIMUM CUL-DE-SAC LENGTH AND DISTANCE OF INTERSECTIONS FROM A PUBLIC STREET ARE SOUGHT BY THE APPLICANT. THERE ARE TWO CUL-DE-SACS THAT ARE PROPOSED TO EXCEED THE CITY 500-FOOT MAXIMUM LENGTH REQUIREMENT. GRANTED.
2. ALSO A WAIVER IS SOUGHT FROM THE 400 FOOT MINIMUM DISTANCE OF A NEW INTERSECTION FROM THE NEAREST ADJACENT STREET. GRANTED.

GENERAL NOTES:

1. NEW HANOVER COUNTY PARCEL NOS: 007020-001-001-000
2. TOTAL TRACT AREA 1,742,213.93 SF (39.99 AC)
3. EXISTING ZONING DISTRICT: R-15
4. LAND CLASSIFICATION: WATERSHED RESOURCE PROTECTION
5. TREE REMOVAL PERMIT TO BE OBTAINED
6. LANDSCAPE PLANS TO BE PROVIDED BY OTHERS
7. THIS TRACT IS LOCATED IN ZONE "C" ACCORDING TO THE FEDERAL EMERGENCY MANAGEMENT AGENCY'S FLOOD INSURANCE RATE MAP, COMMUNITY PANEL NUMBER 37031 4500 4, DATED 4/3/06.
8. SITE ADDRESS IS 1300 NAVAHO TRAIL
9. NCDENR/DNO STORMWATER MANAGEMENT PERMIT REQUIRED AND TO BE OBTAINED.
10. NEW HANOVER COUNTY/NCDENR/LOS SEDIMENTATION & EROSION CONTROL PERMIT REQUIRED AND TO BE OBTAINED.
11. BUILDING USE IS FOR SINGLE-FAMILY HOUSING
12. THIS SITE IS PROPOSED TO BE A CLUSTER DEVELOPMENT.
13. UNPAVED STREETS TO BE MAINTAINED PENDING APPROVAL FROM RES ANALYST/CITY ADDRESS COORDINATOR
14. WATER AND SEWER IS PROPOSED TO BE PUBLIC
15. TRASH IS PROPOSED TO BE PICKED UP BY CITY OF WILMINGTON LANDSCAPING OR PARKING MARKINGS TO BE PROVIDED BY OTHERS
16. HYDRANTS A 3 FOOT CLEAR SPACE SHALL BE MAINTAINED AROUND THE CIRCUMFERENCE OF THE HYDRANT AND 10' FROM THE HYDRANT
17. HYDRANTS MUST BE LOCATED WITHIN 8' OF CURB
18. NEW HYDRANTS MUST BE AVAILABLE FOR USE PRIOR TO CONSTRUCTION
19. CONTRACTOR SHALL MAINTAIN AN ALL WEATHER ACCESS FOR EMERGENCY VEHICLES AT ALL TIMES DURING CONSTRUCTION
20. TEMPORARY STREET SIGNS SHALL BE INSTALLED AT EACH STREET INTERSECTION WHEN CONSTRUCTION OF NEW ROADWAYS ALLOW PASSAGE BY VEHICLES.

DEVELOPMENT NOTES:

1. ALL SIGNS AND PAVEMENT MARKINGS IN AREAS OPEN TO PUBLIC TRAFFIC ARE TO MEET MUTCD STANDARDS.
2. THE CONTRACTOR IS RESPONSIBLE FOR THE LOCATION AND PROTECTION OF EXISTING UTILITIES DURING CONSTRUCTION. CALL U-LOCO AT 1-800-632-6948.
3. CONTRACTOR IS RESPONSIBLE FOR THE REPAIR AND REPLACEMENT OF ANY UTILITIES, CURB AND GUTTER, SIDEWALK PANELS, PAVEMENT, ETC., THAT MAY BE DAMAGED DURING CONSTRUCTION. DAMAGED ITEMS SHALL BE REPAIRED TO AT LEAST THE QUALITY OR WORKMANSHIP FOUND IN THE ORIGINAL ITEM.
4. STORMWATER MANAGEMENT TO MEET CITY OF WILMINGTON REQUIREMENTS FOR THE 10 YEAR STORM AND INTERMITTENT WATER QUALITY REQUIREMENTS FOR LOW DENSITY PROJECTS.
5. PRIOR TO ANY CLEARING, GRADING OR CONSTRUCTION ACTIVITY TREE PROTECTION FENCING WILL BE INSTALLED AROUND PROTECTED TREES OR GROVES OF TREES.
6. NO CONSTRUCTION WORKERS, TOOLS, MATERIALS, OR VEHICLES ARE PERMITTED WITHIN THE TREE PROTECTION FENCING.
7. NO LAND DISTURBANCE, INCLUDING TREE REMOVAL, IS TO OCCUR OUTSIDE THE LIMITS OF DISTURBANCE SHOWN ON THE PLAN.
8. ALL DEVELOPMENT SHALL BE IN ACCORDANCE WITH THE CITY OF WILMINGTON ZONING ORDINANCE & SUBDIVISION REGULATIONS.
9. APPROVAL OF SITE PLAN DOES NOT CONSTITUTE APPROVAL OF PROPOSED SIGNAGE FOR THIS SITE. A SEPARATE SIGN PERMIT MUST BE OBTAINED.
10. APPLICABLE STREET FRONTAGES SHALL HAVE NATURAL VEGETATIVE SCREENING MEETING CITY REQUIREMENTS.
11. THE DEVELOPMENT SHALL COMPLY WITH ALL CITY TECHNICAL STANDARDS AND DEVELOPMENT REGULATIONS.
12. LANDSCAPING PLAN INDICATING THE LOCATION OF REQUIRED STREET TREES SHALL BE SUBMITTED TO THE CITY OF WILMINGTON TRAFFIC ENGINEERING DIVISION AND PARKS AND RECREATION DEPARTMENT FOR REVIEW AND APPROVAL PRIOR TO CONSTRUCTION RELEASE PLAN SHALL ADHERE TO SD 15-17.
13. AFTER LANDSCAPING PLAN IS SUBMITTED, CONTACT 341-7888 TO DISCUSS STREET LIGHTING OPTIONS.
14. PROTECTIVE FENCING IS TO BE MAINTAINED THROUGHOUT THE DURATION OF THE PROJECT.
15. LAND CLEARING AND CONSTRUCTION CONTRACTORS SHALL RECEIVE ADEQUATE INSTRUCTIONS ON TREE PROTECTION REQUIREMENTS AND METHODS. 18-77(2)
16. ALL OPEN SPACE SHALL BE DEEDED TO ALL LAND OWNERS AS COMMON OWNERSHIP. THIS LAND IS NOT TO BE DEVELOPED OR IMPROVED AND OPEN SPACE WILL BE PERPETUALLY PROTECTED. [18-433(G)(5)]
17. TREE SAVE AREAS SHALL BE MARKED PRIOR TO COMMENCEMENT OF ANY SITE CLEARING. THROUGHOUT CONSTRUCTION, MARKINGS FOR TREE SAVE AREAS WILL REMAIN IN PLACE AND VISIBLE.

TRAFFIC ENGINEERING NOTES:

1. A LANDSCAPING PLAN INDICATING THE LOCATION OF REQUIRED STREET TREES SHALL BE SUBMITTED TO THE CITY OF WILMINGTON TRAFFIC ENGINEERING DIVISION AND PARKS AND RECREATION DEPARTMENT FOR REVIEW AND APPROVAL PRIOR TO RECORDING OF THE FINAL PLAT. PLAN SHALL ADHERE TO SD 15-17.
2. ALL SIGNS AND PAVEMENT MARKINGS IN AREAS OPEN TO PUBLIC TRAFFIC ARE TO MEET MUTCD (MANUAL ON UNIFORM TRAFFIC CONTROL DEVICES) STANDARDS.
3. ONCE STREETS ARE OPEN TO TRAFFIC, CONTACT TRAFFIC ENGINEERING TO REQUEST INSTALLATION OF TRAFFIC AND STREET NAME SIGNS. PROPOSED STREET NAMES MUST BE APPROVED PRIOR TO INSTALLATION OF STREET NAME SIGNS.
4. OPEN CUT NOTES:
 - A. CONTRACTOR TO COORDINATE WITH CITY OF WILMINGTON FOR ACCEPTABLE HOURS OF CONSTRUCTION AND TRAFFIC CONTROL DURING INSTALLATION OF UTILITIES IN CITY ROADS.
 - B. SUTURE COMPANION AND APPROVED STONE & BASE COURSES TO BE INSTALLED IN PLACE OF OPEN CUT.
 - C. OPEN CUT TO BE SAW CUT.
5. TRIP GENERATION NUMBERS:
 - 727 TOTAL 2-WAY VOLUME
 - 57 PM PEAK VOLUME
6. A VARIANCE IS REQUESTED FOR INTERSECTIONS BEING LONGER THAN 400' MAXIMUM DISTANCE PER CITY TECHNICAL STANDARDS.
7. A VARIANCE IS REQUESTED TO ALLOW CUL-DE-SAC ON SOUTH ROCKLAND COURT AND KELLERTON PLACE TO BE MORE THAN 500 FT MAXIMUM LENGTH.
8. ALL DRIVEWAYS WITHIN SUBDIVISION TO BE LOCATED ON STOP-CONTROLLED DRIVEWAYS.
9. ALL DRIVEWAYS TO BE CITY STANDARD RAMP-TYPE DRIVEWAYS.
10. A NCDOT DRIVEWAY PERMIT IS REQUIRED AND TO BE OBTAINED.
11. A BOND FOR 100% FOR ALL WORK WITHIN THE NCDOT RIGHT OF WAY SHALL BE SUBMITTED ALONG WITH THE DRIVEWAY PERMIT BEFORE IT CAN BE PROCESSED FOR APPROVAL.
12. ALL EXISTING DRIVEWAYS ON NAVAHO TRAIL WILL BE CLOSED.

ENVIRONMENTAL NOTES:

1. ALL SIGNIFICANT TREES ON SITE ARE TO BE RETAINED OR MITIGATED.
2. NO LAND DISTURBANCE IS PERMITTED OUTSIDE THE DESIGNATED LIMITS OF DISTURBANCE FOR SITE IMPROVEMENTS OTHER THAN THAT NECESSARY TO THE EXISTING CONTOURS OR MEET LANDSCAPING REQUIREMENTS.
3. AREAS OUTSIDE THE LIMITS OF DISTURBANCE ON SITE ARE TO BE PRESERVED.
4. TREE WELLS TO BE PROVIDED AND INSTALLED AS NECESSARY TO MAINTAIN EXISTING GRADE AT ROOT ZONE (TREE CANOPY) OF TREES TO BE PRESERVED.
5. JURISDICTIONAL DETERMINATION FROM USACE HAS BEEN PERFORMED.
6. WATER BODY SERVING THIS SITE IS WHISKEY CREEK SA/HOW.

SITE & BUILDING DATA:

SITE DATA:
 TOTAL SITE AREA = 1,742,213.93 SF (39.99 AC)
 IMPERVIOUS AREA BREAKDOWN:
 PROPOSED SITE:
 ASPHALT = 138,083 SF (3.17 AC)
 CONCRETE SIDEWALKS = 24,972 SF (0.57 AC)
 AMENITY AREAS = 0.00 SF (0.00 AC)
 LOT IMPERVIOUS AREA = 272,418 SF (6.25 AC)
 TOTAL PROPOSED IMPERVIOUS = 435,483 SF (10.00 AC)
 PROPOSED BUILDING SIZE = 2,724 SF

DENSITY CALCULATION:
 MAX. DENSITY R-15 (CLUSTER) = 2.5/AC
 2.5 X 39.99 AC = 99.98
 TOTAL PROPOSED LOTS = 100

BUILDING DATA:
 TOTAL LOTS = 100 SINGLE-FAMILY HOMES

PRIMARY CONSERVATION AREA ALONG WITH THE 40X OPEN SPACE THAT'S BROKEN DOWN IN SITE & BUILDING DATA.
 PRIMARY CONSERVATION AREA SHALL BE PROVIDED IN ACCORDANCE WITH LDC SECTION 18-433(G).
 THE PRIMARY CONSERVATION AREA SHALL NOT BE DISTURBED EXCEPT AS PERMITTED IN LDC SECTION 18-433.








OPEN SPACE BREAKDOWN:
 RECD OPEN SPACE = 39.99 AC (TOT. TRACT) X OPEN SPACE
 40% = 15,996 AC. RECD OPEN SPACE
 OPEN SPACE PROVIDED:
 ACTIVE OPEN SPACE = 432,127 SF (9.92 AC)
 PASSIVE OPEN SPACE = 264,833 SF (6.08 AC)
 TOTAL OPEN SPACE = 696,960 SF (16.00 AC)

TOTAL WETLANDS ON-SITE = 156,816 SF (3.60 AC)
TOTAL WETLANDS IMPACTS = 4,871 SF (0.11 AC)
 AREA INSIDE PROP. C.O.D. SETBACK = 2.30 AC
 AREA INSIDE PROP. C.O.D. SETBACK = 3.15 AC
 AREA IN LIMITS OF DISTURBANCE = 25,601 AC

PRE-DEVELOPMENT IMPERVIOUS COVERAGE = 0%
POST-DEVELOPMENT IMPERVIOUS COVERAGE = 25%

10 FT SEPARATION REQUIRED BETWEEN BLDGS.
 ZERO LOTLINES ARE PERMITTED IN CLUSTER SUBDIVISIONS

LEGEND

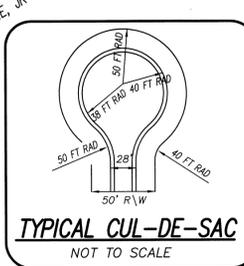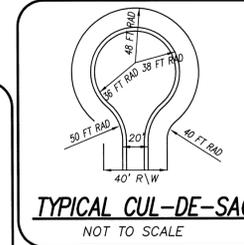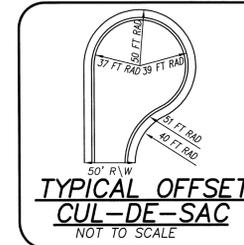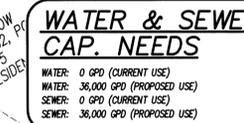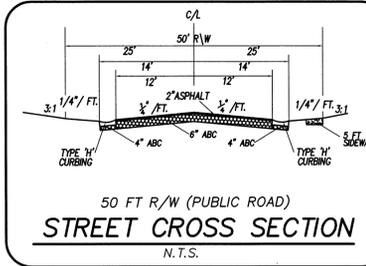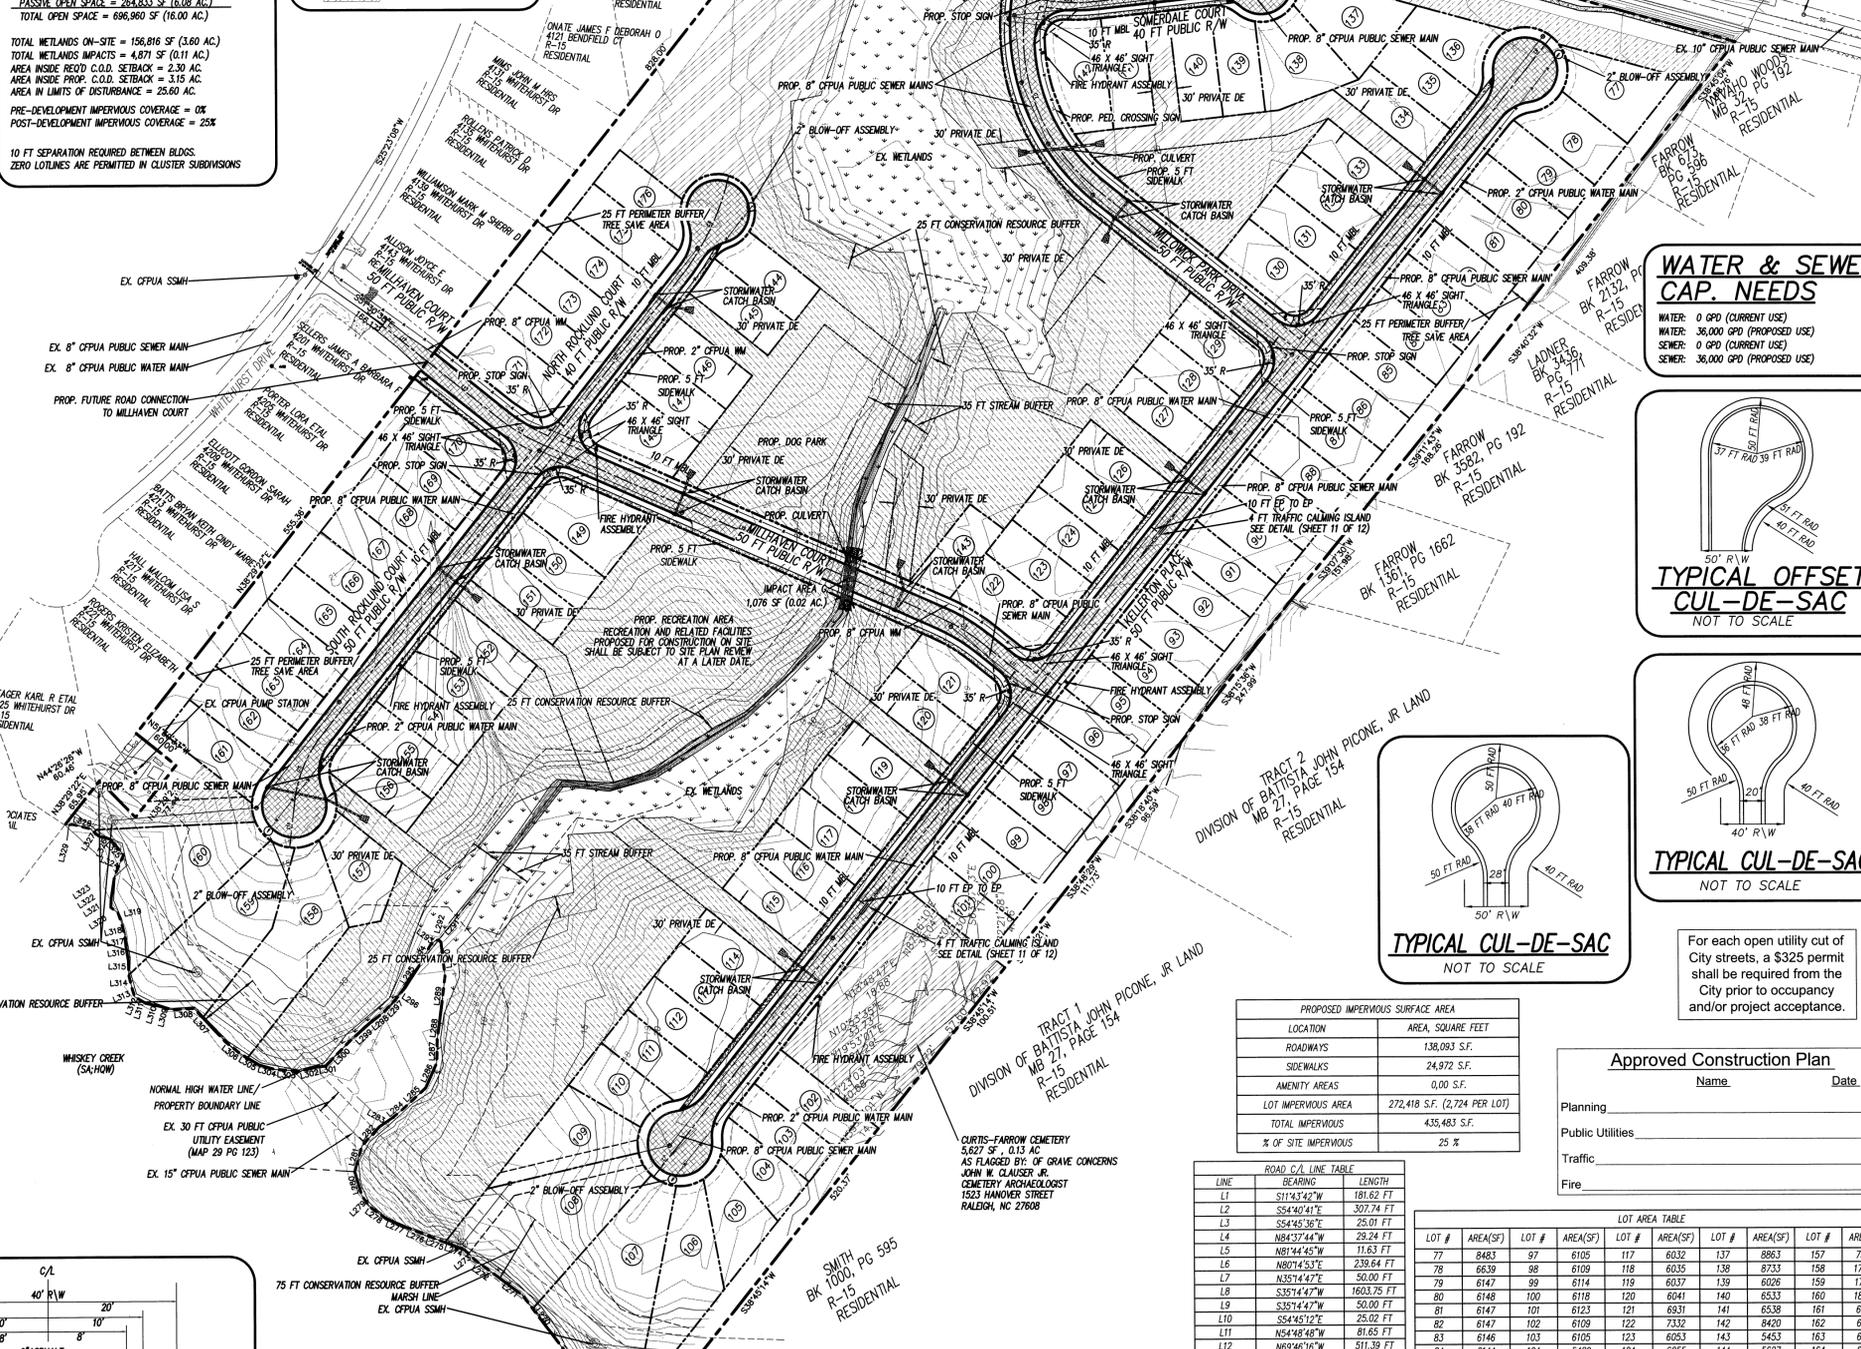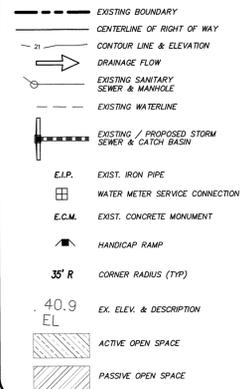


For each open utility cut of City streets, a \$325 permit shall be required from the City prior to occupancy and/or project acceptance.

LOCATION	AREA, SQUARE FEET
ROADWAYS	138,083 S.F.
SIDEWALKS	24,972 S.F.
AMENITY AREAS	0.00 S.F.
LOT IMPERVIOUS AREA	272,418 S.F. (2,724 PER LOT)
TOTAL IMPERVIOUS	435,483 S.F.
% OF SITE IMPERVIOUS	25 %

LINE	BEARING	LENGTH
L1	S11°43'42\"/>	

LOT #	AREA(SF)						
77	8483	97	8105	117	6032	137	8863
78	6639	98	8109	118	6035	138	8733
79	6147	99	8114	119	6037	139	6026
80	6148	100	8118	120	6041	140	6533
81	6147	101	8123	121	6043	141	6538
82	6147	102	8129	122	7332	142	8420
83	6146	103	8125	123	6053	143	5453
84	6144	104	8489	124	6055	144	5927
85	6127	105	8127	125	6058	145	5920
86	6106	106	12087	126	6061	146	5892
87	6085	107	21381	127	6065	147	5894
88	6064	108	21147	128	6067	148	7823
89	6042	109	10099	129	7160	149	9310
90	6021	110	9484	130	7194	150	6156
91	6017	111	5918	131	6073	151	6158
92	6035	112	6017	132	6072	152	6163
93	6053	113	6020	133	6072	153	6165
94	6071	114	6023	134	6070	154	6168
95	6090	115	6027	135	6070	155	6171
96	6100	116	6029	136	6455	156	6105

STORMWATER MANAGEMENT PLAN APPROVED
 CITY OF WILMINGTON
 ENGINEERING DEPARTMENT
 DATE _____ PERMIT # _____
 SIGNED _____

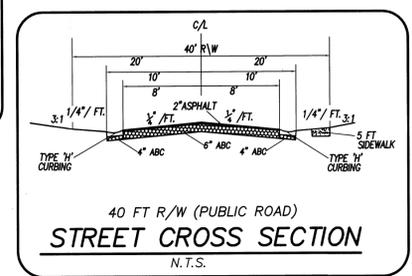

COASTAL SITE DESIGN, PC
 LICENSE # C-2710
 ENGINEERING LAND PLANNING COMMERCIAL / RESIDENTIAL
 P.O. Box 4041
 Wilmington, NC 28406
 (910) 791-4441

THE CREEK AT WILLOWICK
 PRELIMINARY PLAN for THE CREEK AT WILLOWICK
 LOCATED IN WASHINGTON TOWNSHIP, NEW HANOVER COUNTY, NORTH CAROLINA
 OWNER: TSV DEVELOPERS, INC.
 1904 EASTWOOD ROAD, SUITE 212
 WILMINGTON, NC 28403

THE CREEK AT WILLOWICK
 PRELIMINARY PLAN for THE CREEK AT WILLOWICK
 LOCATED IN WASHINGTON TOWNSHIP, NEW HANOVER COUNTY, NORTH CAROLINA
 OWNER: TSV DEVELOPERS, INC.
 1904 EASTWOOD ROAD, SUITE 212
 WILMINGTON, NC 28403



REVISED WATER MAIN LOCATION	DATE	BY	REMARKS
16	12/30/13	JSM	
15	10/29/13	JSM	
14	10/10/13	JSM	
13	8/23/13	JSM	
12	7/22/13	RLW	
11	7/10/12	RLW	
10	8/28/09	RLW	
9	1/23/14	RLW	

DATE: 02-28-07
 HORZ. SCALE: 1" = 100'
 DRAWN BY: JSL
 CHECKED BY: HSR
 PROJECT NO.: 04-0011
 DRAWING NO.: 04-0011PH2.ppt

Sheet No. **3** of **12**



STATION 1+00.00 THROUGH END
SOUTH ROCKLUND COURT
 &
 STATION 1+00.00 THROUGH END
SEWER EXTENSION

PLANS & PROFILES for
THE CREEK AT WILLOWICK
 LOCATED IN WASONBORO TOWNSHIP
 NEW HANOVER COUNTY, NORTH CAROLINA
 OWNER: TSV DEVELOPERS, INC.
 1904 EASTWOOD ROAD, SUITE 212
 WILMINGTON, NC 28403



REV.	NO.	REMARKS	DATE
6	7	REVISED PER CTPVA COMMENTS	7/10/12
7	6	REVISED PER CTPVA COMMENTS	10/28/09
8	13	REVISED WATER MAIN POSITION	JSM 12/20/13
9	12	REVISED DIP WATER MAINS	JSM 11/22/13
10	11	REVISED PUBLIC WATER AND SEWER MAIN LOCATIONS	JSM 10/10/13
11	10	REVISED PUBLIC UTILITY OWNERSHIP, ADDED TYP. DETAIL	JSM 8/23/13
12	9	REMOVED WATER/SEWER SERVICES, ADDED TYP. DETAIL	RLW 7/29/13

DATE: 3-20-08
 HORZ. SCALE: 1" = 50'
 VERT. SCALE: 1" = 5'
 DRAWN BY: JSL
 CHECKED BY: HSR
 PROJECT NO. 04-001
 DRAWING NO. 04-001P1
 Sheet No. **4** of **12**

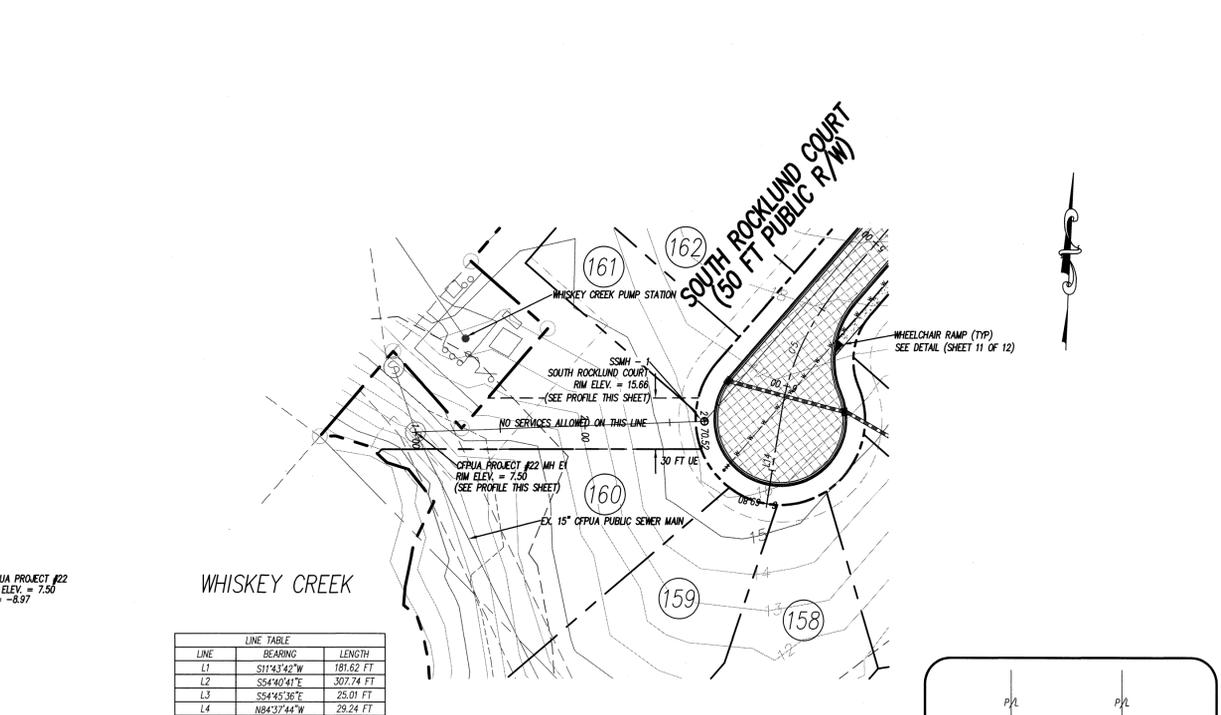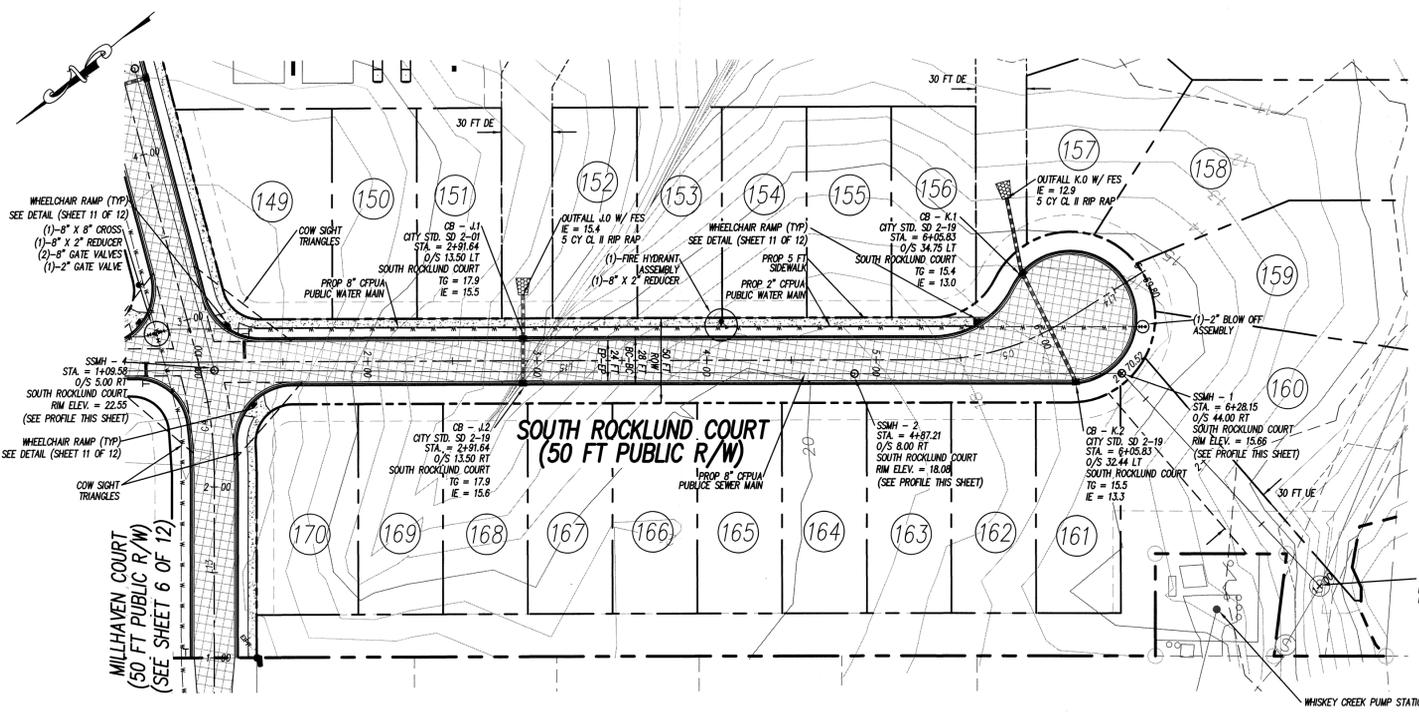


LINE TABLE








LINE	BEARING	LENGTH
L1	S11°43'42"W	181.62 FT
L2	S54°40'41"E	307.74 FT
L3	S54°45'36"E	25.01 FT
L4	N84°17'44"W	29.24 FT
L5	N81°44'45"W	11.63 FT
L6	N80°14'53"E	239.64 FT
L7	N35°14'47"E	50.00 FT
L8	S35°14'47"W	1603.75 FT
L9	S35°14'47"W	50.00 FT
L10	S54°45'37"E	25.01 FT
L11	N84°18'46"W	81.65 FT
L12	N69°46'16"W	511.39 FT
L13	N54°56'23"W	107.37 FT
L14	S03°15'15"W	50.00 FT
L15	N35°03'37"E	434.25 FT
L16	N35°03'37"E	264.35 FT

CURVE TABLE

CURVE	DELTA	RADIUS	ARC	TANGENT	CHORD BRG
C1	86°21'32"	230.00 FT	266.52 FT	150.49 FT	S21°28'32"E
C2	187°02'22"	230.00 FT	72.28 FT	36.44 FT	N89°15'04"E
C3	145°27'28"	230.00 FT	60.04 FT	30.19 FT	N62°17'32"W
C4	14°49'53"	230.00 FT	59.54 FT	29.94 FT	S62°21'19"E
C5	32°25'51"	151.14 FT	85.55 FT	43.95 FT	S17°49'56"W
C6	23°07'58"	300.00 FT	121.12 FT	61.40 FT	N21°16'22"E

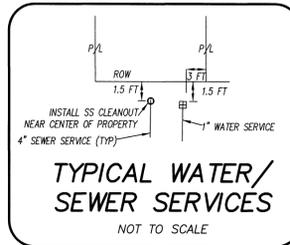

NOTE: RESIDENTIAL DRIVEWAYS MUST MEET OFFSET REQUIREMENTS AND SIGHT DISTANCE REQUIREMENTS AT EACH INTERSECTION (LOTS 121, 122, 129, 130, 142, 148, 149, 170, & 171).

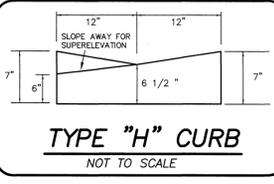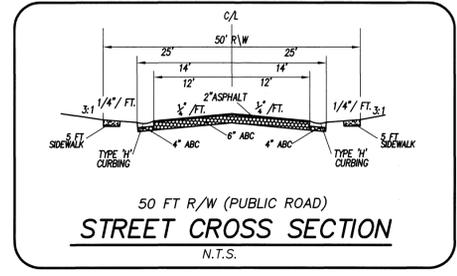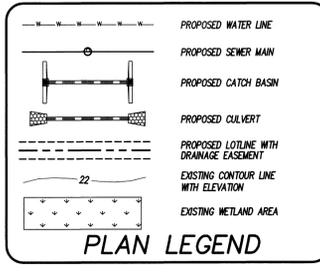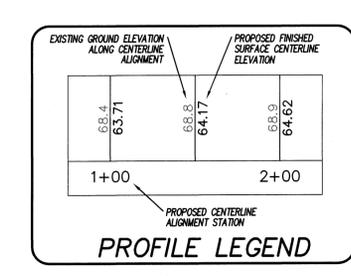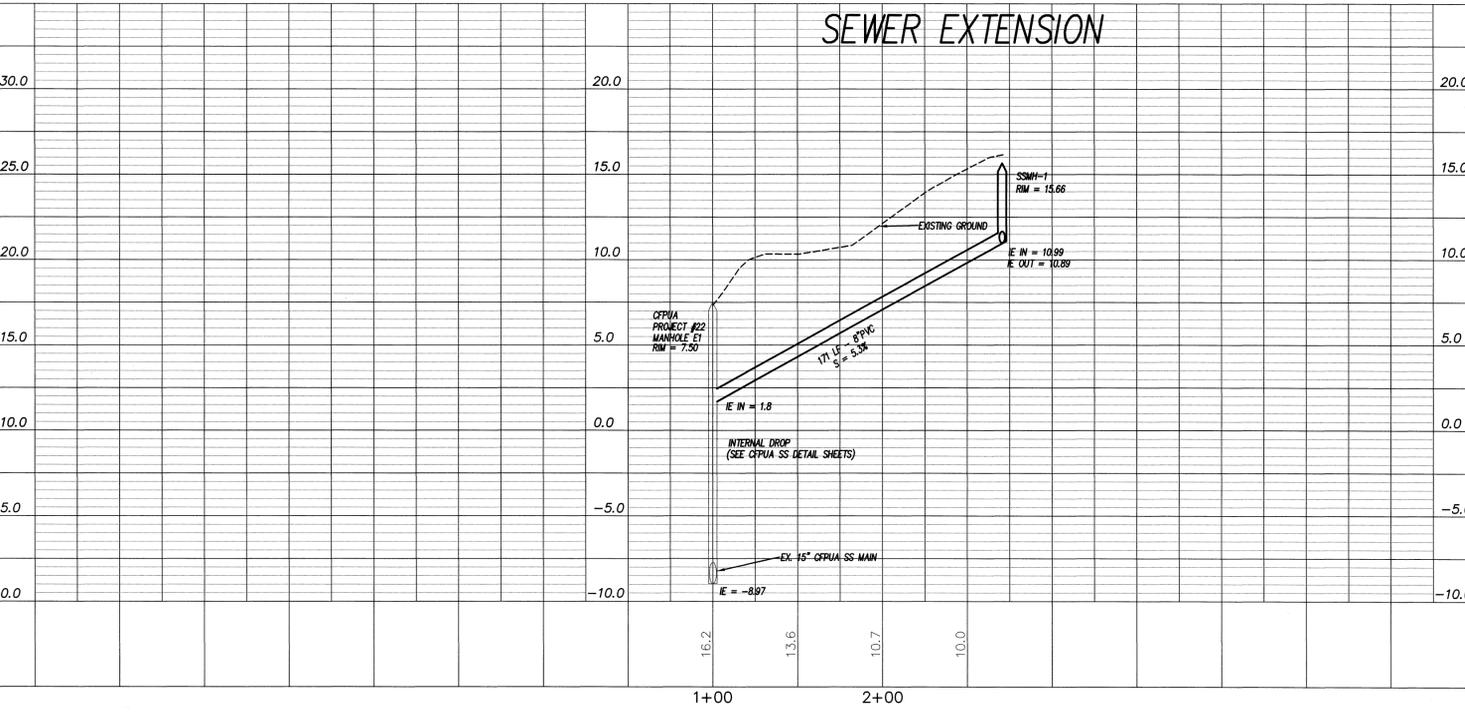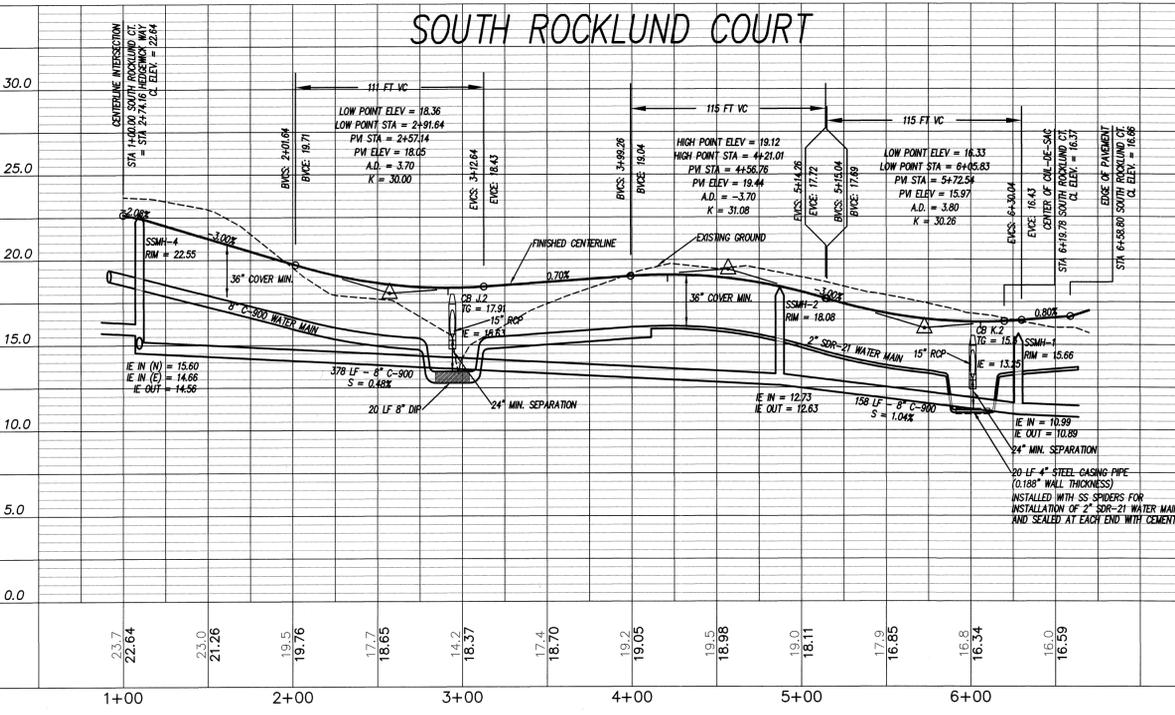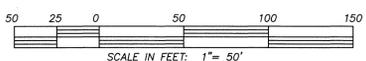

- CTPVA STANDARD SEWER NOTES:
- SEWER GUARDS REQUIRED AT ALL MANHOLES. STAINLESS STEEL SEWER GUARDS REQUIRED AT MANHOLES LOCATED IN TRAFFIC AREAS.
 - SERVICES SHALL BE PERPENDICULAR TO MAIN AND TERMINATE AT R/W LINE. SERVICES IN CUL-DE-SACS ARE REQUIRED TO BE PERPENDICULAR, OR MUST ORIGINATE IN MANHOLE AND TERMINATE AT RIGHT-OF-WAY LINE.
 - ALL SERVICES TYPING INTO DUCTILE IRON MAINS SHALL BE CONSTRUCTED OF CLASS 50, DIP, WITH PROTECTO 407 OCEANIC SPORT LINING.
 - 10' UTILITIES EASEMENT PROVIDED ALONG THE FRONTAGE OF ALL LOTS AND AS SHOWN.
 - NO FLEXIBLE COUPLINGS SHALL BE USED.

For each open utility cut of City streets, a \$325 permit shall be required from the City prior to occupancy and/or project acceptance.

STORMWATER MANAGEMENT PLAN
APPROVED
 CITY OF WILMINGTON
 ENGINEERING DEPARTMENT
 DATE _____ PERMIT # _____
 SIGNED _____

Approved Construction Plan
 Name _____ Date _____
 Planning _____
 Public Utilities _____
 Traffic _____
 Fire _____

STATION 1+00.00 THROUGH END
 NORTH ROCKLUND COURT
 &
 STATION 1+00.00 THROUGH END
 SOMERDALE COURT


PLANS & PROFILES FOR
THE CREEK AT WILLOWICK
 LOCATED IN MASONBORO TOWNSHIP
 NEW HANOVER COUNTY, NORTH CAROLINA

OWNER: TSV DEVELOPERS, INC.
 1304 EASTWOOD ROAD, SUITE 212
 WILMINGTON, NC 28403



REV. NO.	DATE	BY	REMARKS
8	7/20/13	JSL	REMOVED WATER/SEWER SERVICES, ADDED TYP. DETAIL
7	7/22/13	JSL	REVISED PER CFP/UA
6	7/10/12	JSL	REVISED SHEET NUMBER
5	08/28/09	JSL	REVISED WATER MAIN LOCATION
4	12/30/13	JSL	REVISED WATER DIP MAIN
3	11/22/13	JSL	REVISED PER WATER AND SEWER LOCATIONS
2	10/10/13	JSL	REVISED PER PUBLIC UTILITY OWNERSHIP
1	8/23/13	JSL	









DATE: 3-20-08
 HORZ. SCALE: 1" = 50'
 VERT. SCALE: 1" = 5'
 DRAWN BY: JSL
 CHECKED BY: HSR
 PROJECT NO: 04-0011
 DRAWING NO: 04-0011PP2
 Sheet No. **5** of **12**

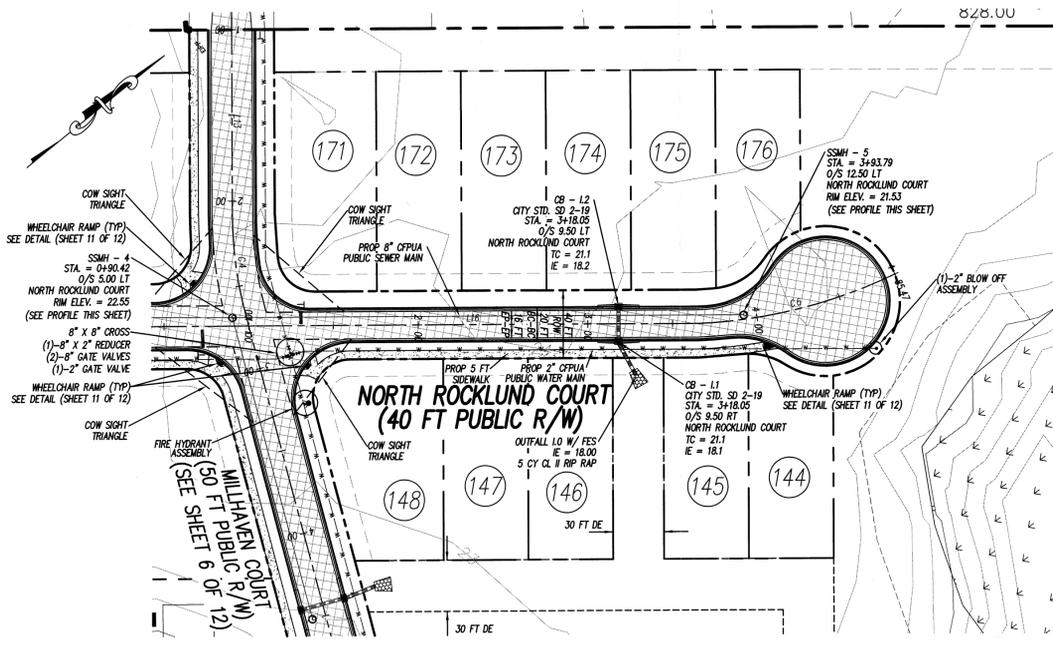

NOTE: RESIDENTIAL DRIVEWAYS MUST MEET OFFSET REQUIREMENTS AND SIGHT DISTANCE REQUIREMENTS AT EACH INTERSECTION (LOTS 121, 122, 129, 130, 142, 148, 149, 170, & 171).

LINE	BEARING	LENGTH
L1	S11°43'42"W	181.62 FT
L2	S54°40'41"E	307.74 FT
L3	S44°45'36"E	28.01 FT
L4	N84°37'44"W	29.24 FT
L5	N81°44'55"W	11.63 FT
L6	S35°14'47"W	239.64 FT
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L8	S35°14'47"W	1603.75 FT
L9	S35°14'47"W	50.00 FT
L10	S44°45'36"E	28.02 FT
L11	N84°48'48"W	81.65 FT
L12	N69°46'16"W	511.39 FT
L13	N54°56'23"W	107.37 FT
L14	S03°15'15"W	50.00 FT
L15	N35°03'37"E	434.25 FT
L16	N35°03'37"E	284.35 FT

CURVE	DELTA	RADIUS	ARC	TANGENT	CHORD	CHORD BRG
C1	86°23'37"	230.00 FT	266.52 FT	150.49 FT	S21°28'52"E	
C2	18°02'29"	230.00 FT	72.28 FT	38.44 FT	N89°19'04"E	
C3	145°2'58"	230.00 FT	60.04 FT	30.19 FT	N82°12'32"W	
C4	14°49'53"	230.00 FT	59.54 FT	29.94 FT	S82°21'19"E	
C5	32°25'51"	151.14 FT	85.55 FT	43.95 FT	S17°49'56"W	
C6	230°7'58"	300.00 FT	121.12 FT	61.40 FT	N21°16'22"E	

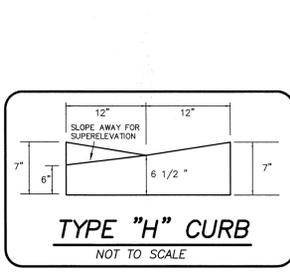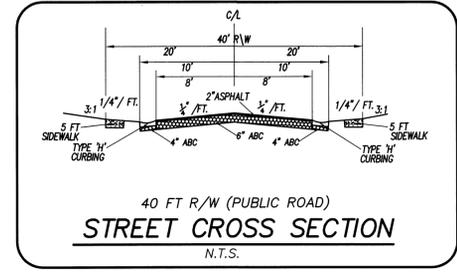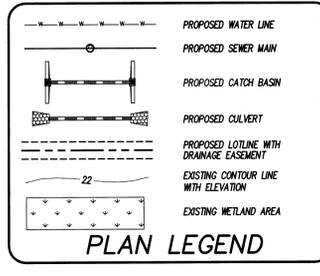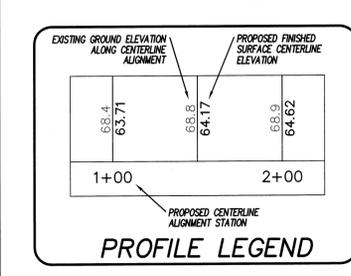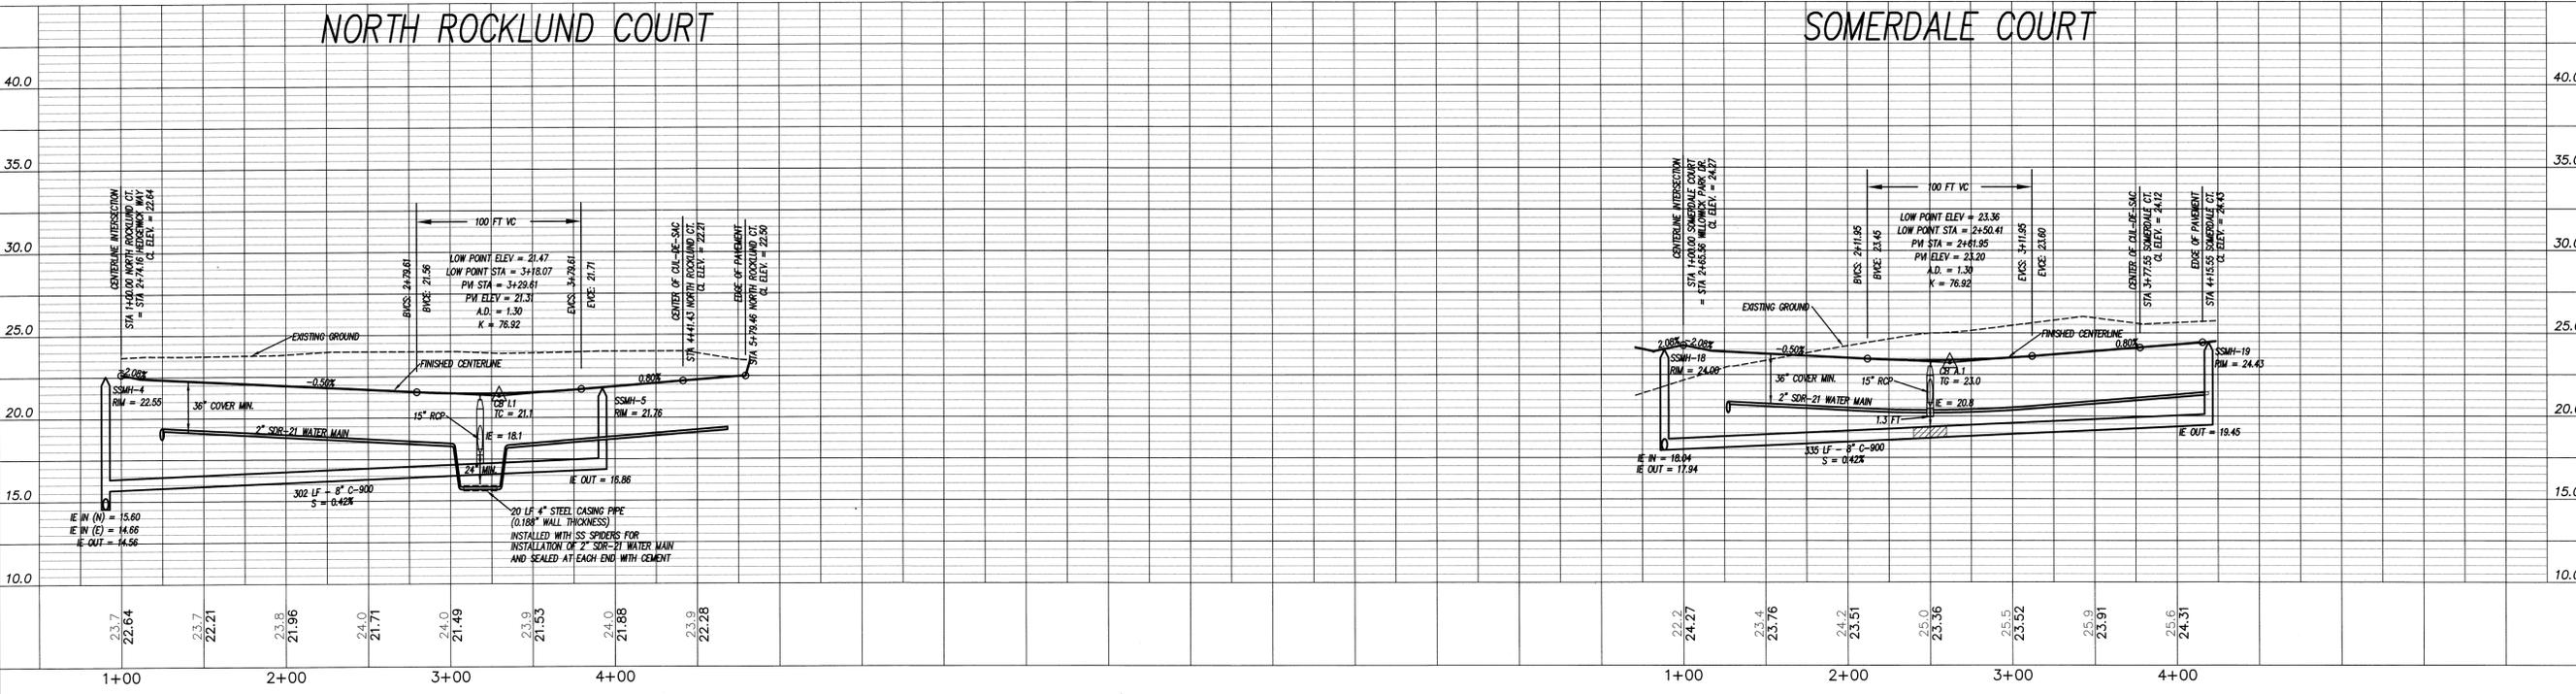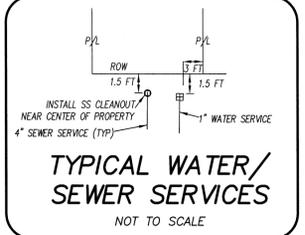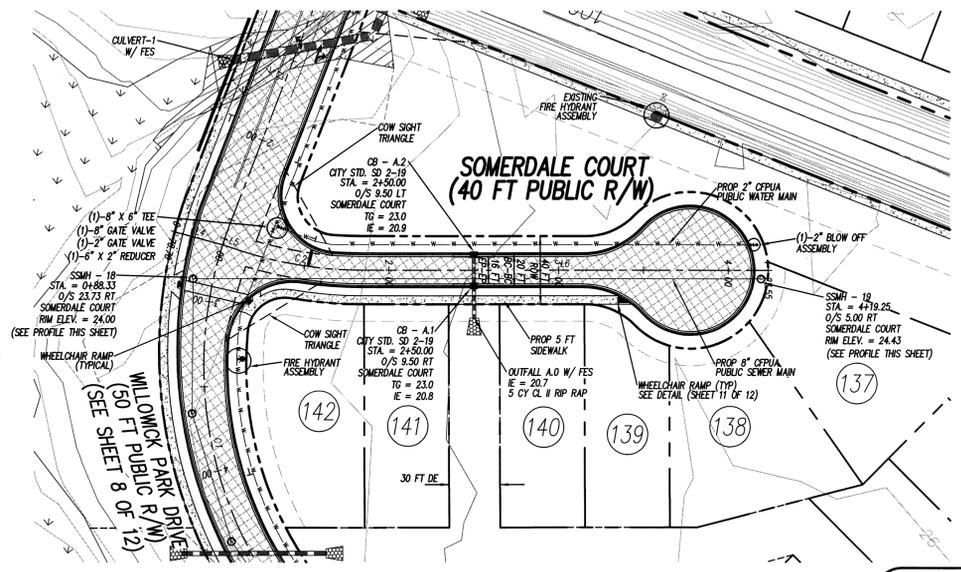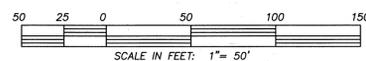



- CFPA STANDARD SEWER NOTES:**
- SEWER GUARDS REQUIRED AT ALL MANHOLES. STAINLESS STEEL SEWER GUARDS REQUIRED AT MANHOLES LOCATED IN TRAFFIC AREAS.
 - SERVICES SHALL BE PERPENDICULAR TO MAIN AND TERMINATE AT R/W LINE. SERVICES IN CULVERTS ARE REQUIRED TO BE PERPENDICULAR, OR MUST ORIGINATE IN MANHOLE AND TERMINATE AT RIGHT-OF-WAY LINE.
 - ALL SERVICES THING INTO DUCTILE IRON MAINS SHALL BE CONSTRUCTED OF CLASS 50, DIP, WITH PROTECTED 401 CERAMIC EPOXY LINING.
 - 10' UTILITIES EASEMENT PROVIDED ALONG THE FRONTAGE OF ALL LOTS AND AS SHOWN.
 - NO FLEXIBLE COUPLINGS SHALL BE USED.

For each open utility cut of City streets, a \$325 permit shall be required from the City prior to occupancy and/or project acceptance.

STORMWATER MANAGEMENT PLAN APPROVED
 CITY OF WILMINGTON
 ENGINEERING DEPARTMENT
 DATE _____ PERMIT # _____
 SIGNED _____

Approved Construction Plan
 Name _____ Date _____
 Planning _____
 Public Utilities _____
 Traffic _____
 Fire _____

ASPHALT TAPER LENGTH
 L = WS/2
 L = TAPER WIDTH X SPEED LIMIT / 2
 L = 3 FT X 25 MPH / 2
 L = 75 / 2
 L = 37.5 FT

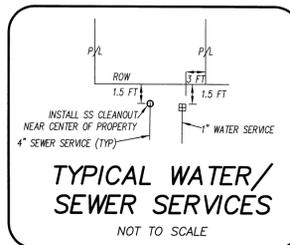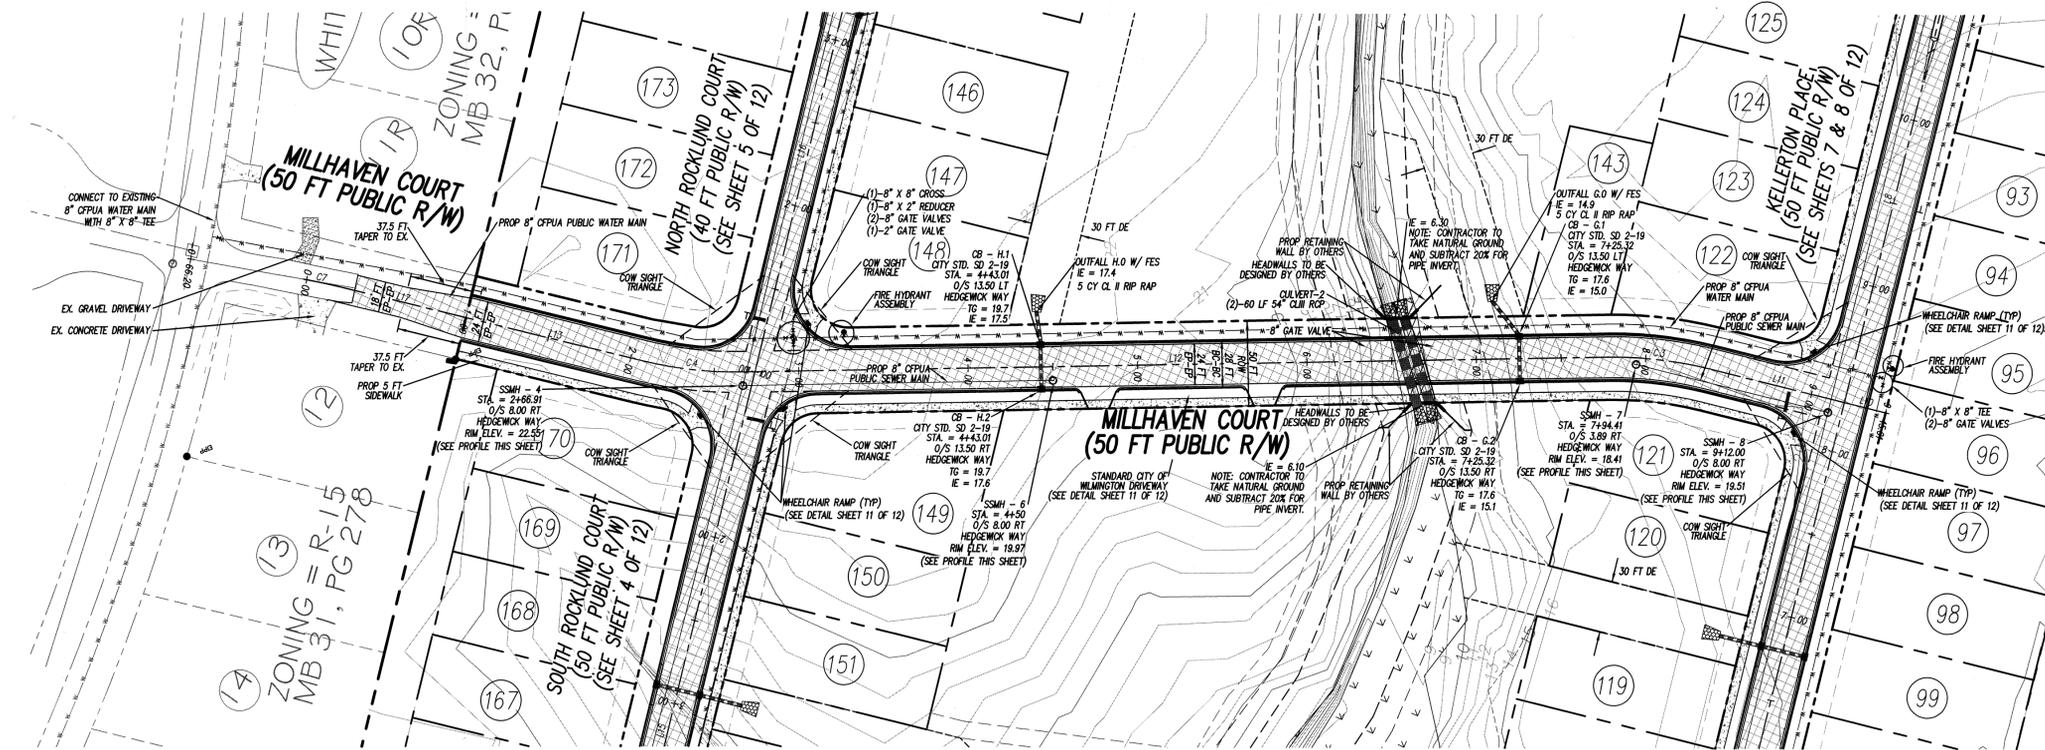



LINE TABLE

LINE	BEARING	LENGTH
L1	S143°32'W	181.62 FT
L2	S54°40'41\"/>	

CURVE TABLE

CURVE	DELTA	RADIUS	ARC	TANGENT	CHORD BRC
C1	66°23'37\"/>				

NOTE: RESIDENTIAL DRIVEWAYS MUST MEET OFFSET REQUIREMENTS AND SIGHT DISTANCE REQUIREMENTS AT EACH INTERSECTION (LOTS 121, 122, 129, 130, 142, 148, 149, 170, & 171).

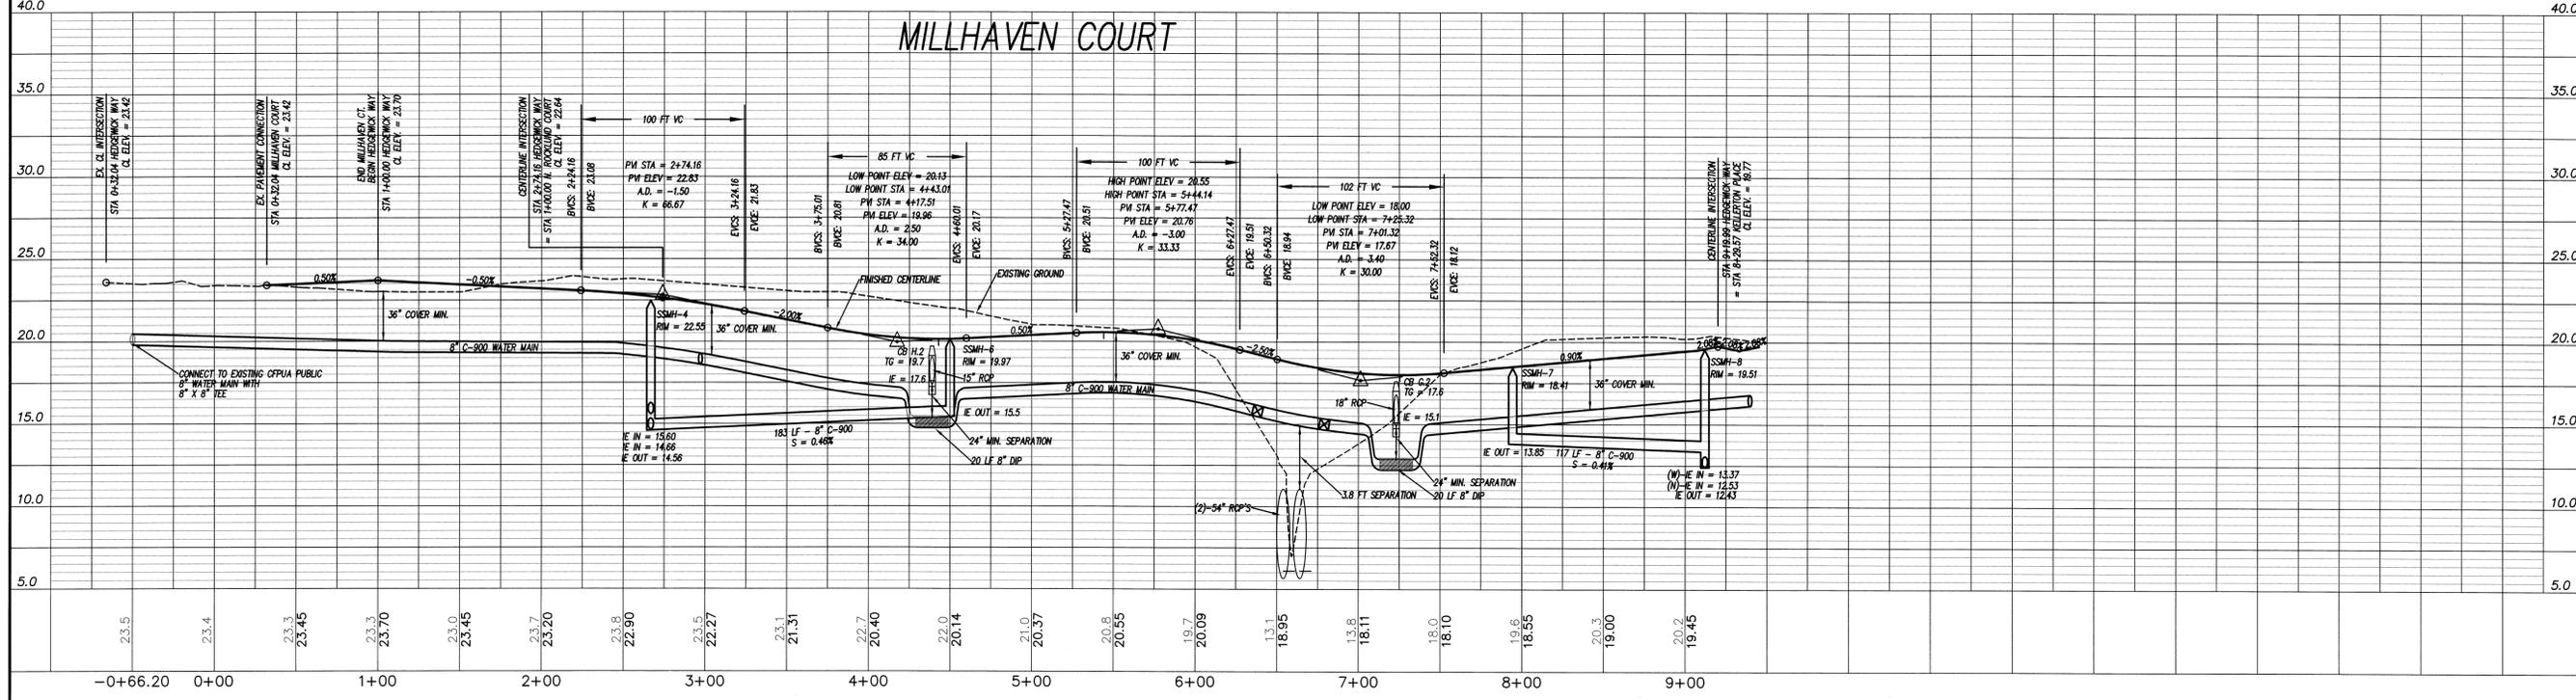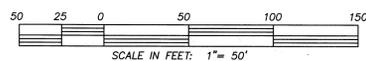





GSD
 LICENSE # C-2710
COASTAL SITE DESIGN, PC
 ENGINEERING
 LAND PLANNING
 COMMERCIAL / RESIDENTIAL
 P.O. Box 4041
 Wilmington, NC 28406
 (910) 791-4441

STATION 1+00.00 THROUGH END
HEDGEWICK WAY

PLANS & PROFILES FOR
THE CREEK AT WILLOWICK
 LOCATED IN WASHINGTON TOWNSHIP
 NEW HANOVER COUNTY, NORTH CAROLINA
 OWNER: TSV DEVELOPERS, INC.
 1904 EASTWOOD ROAD, SUITE 212
 WILMINGTON, NC 28403



REV. NO.	DATE	BY	REMARKS
1	7/22/13	JSL	REVISED PER CFPWA COMMENTS
2	7/10/12	JSL	REVISED PER CFPWA COMMENTS
3	10/28/09	JSL	REVISED PER CFPWA COMMENTS
4	12/20/13	JSL	REVISED WATER MAIN LOCATION
5	10/10/13	JSL	REVISED LOCATIONS OF WATER AND SEWER MAINS
6	9/23/13	JSL	REVISED PER MILLHAVEN COURT EXTENSION
7	8/23/13	JSL	REVISED PER PUBLIC UTILITY OWNERSHIP
8	7/30/13	JSL	REMOVED WATER/SEWER SERVICES, ADDED TYP. DETAIL

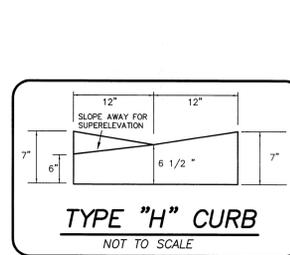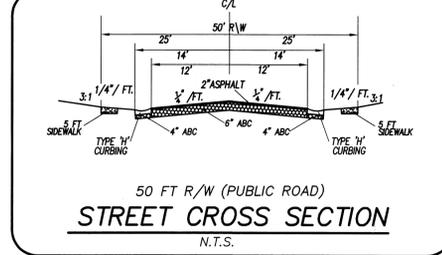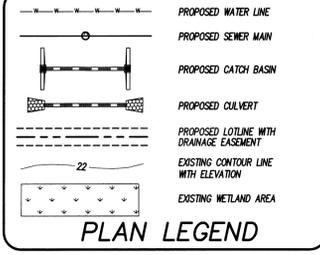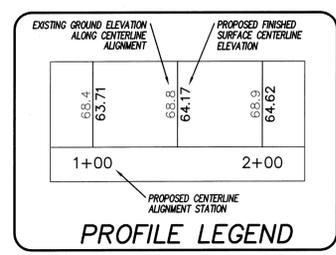

- CITY STANDARD SEWER NOTES:**
- SEWER GUARDS REQUIRED AT ALL MANHOLES. STAINLESS STEEL SEWER GUARDS REQUIRED AT MANHOLES LOCATED IN TRAFFIC AREAS.
 - SERVICES SHALL BE PERPENDICULAR TO MAIN AND TERMINATE AT R/W LINE. SERVICES IN CULVERTS ARE REQUIRED TO BE PERPENDICULAR, OR MUST ORIGINATE IN MANHOLE AND TERMINATE AT RIGHT-OF-WAY LINE.
 - ALL SERVICES THING INTO DUCTILE IRON MAINS SHALL BE CONSTRUCTED OF CLASS 30, DIP, WITH PROTECTO 401 CERAMIC EPOXY LINING.
 - 10' UTILITIES EASEMENT PROVIDED ALONG THE FRONTAGE OF ALL LOTS AND AS SHOWN.
 - NO FLEXIBLE COUPLINGS SHALL BE USED.

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STORMWATER MANAGEMENT PLAN
APPROVED
 CITY OF WILMINGTON
 ENGINEERING DEPARTMENT
 DATE _____ PERMIT # _____
 SIGNED _____


Approved Construction Plan
 Name _____ Date _____
 Planning _____
 Public Utilities _____
 Traffic _____
 Fire _____

DATE: 3-20-08
 HORZ. SCALE: 1" = 50'
 VERT. SCALE: 1" = 5'
 DRAWN BY: JSL
 CHECKED BY: HSR
 PROJECT NO. 04-0011
 DRAWING NO. 04-0011P2
 Sheet No. **6** of **12**







REV. NO.	DATE	REMARKS
1	7/30/13	REVISED WATER/SEWER SERVICES, ADDED TYP. DETAIL
2	7/22/13	REVISED PER COMMENTS FROM CFPWA
3	7/10/12	REVISED PER CFPWA COMMENTS / WATER MAIN LOCATION
4	12/20/13	REVISED DIP WATER MAINS
5	11/21/13	REVISED ISLAND SIZE
6	10/29/13	REVISED WATER AND SEWER MAIN LOCATIONS
7	10/10/13	REVISED PER PUBLIC UTILITY OWNERSHIP
8	8/23/13	

DATE: 3-20-08
 HORZ. SCALE: 1" = 50'
 VERT. SCALE: 1" = 5'
 DRAWN BY: JSL
 CHECKED BY: HSR
 PROJECT NO: 04-001
 DRAWING NO: 04-001PP4
 Sheet No. **7** of **12**




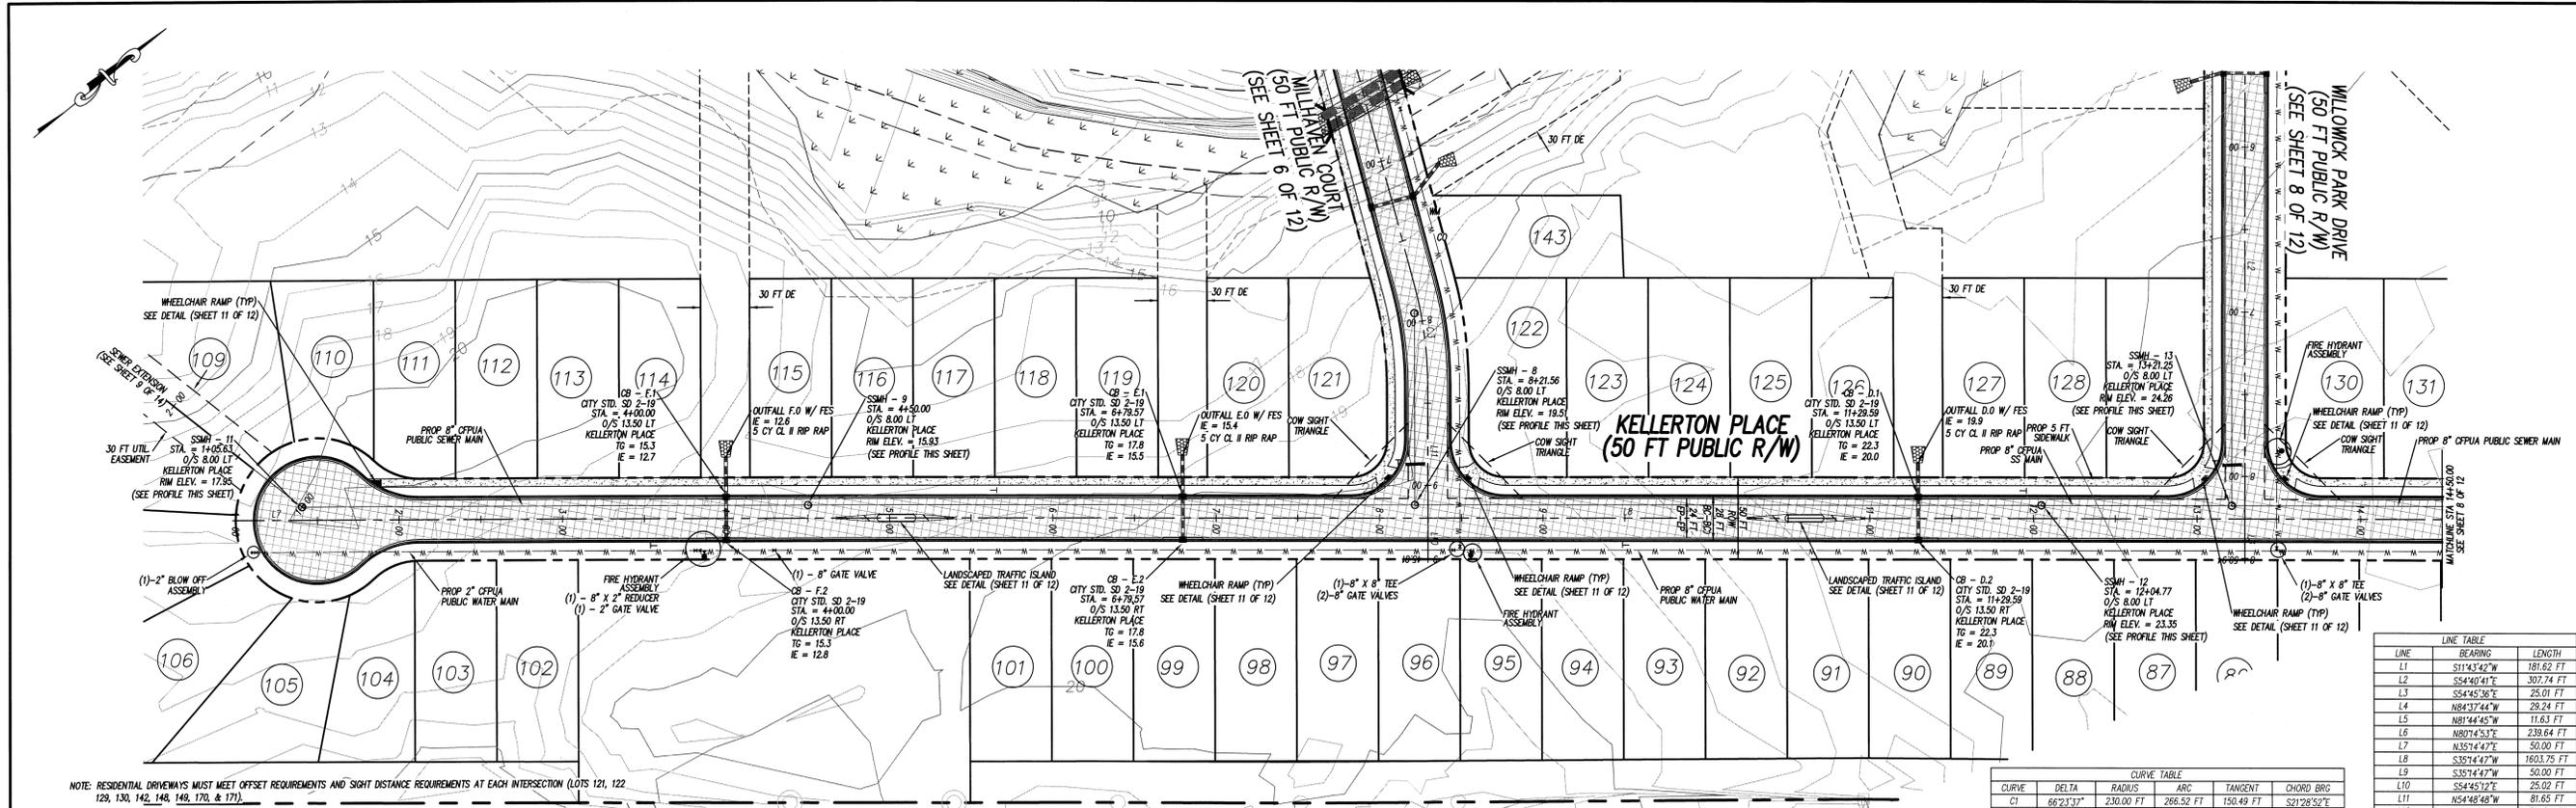


CURVE	DELTA	RADIUS	ARC	TANGENT	CHORD BRG
C1	66°23'37"	230.00 FT	266.52 FT	150.49 FT	S212°28'52"E
C2	18°00'22"	230.00 FT	72.28 FT	36.44 FT	N88°15'04"E
C3	14°57'28"	230.00 FT	60.04 FT	30.19 FT	N62°17'32"W
C4	14°49'53"	230.00 FT	59.54 FT	29.94 FT	S62°21'19"E
C5	32°25'51"	151.14 FT	85.55 FT	43.55 FT	S17°49'58"W
C6	23°07'58"	300.00 FT	121.12 FT	61.40 FT	N21°16'52"E

LINE	BEARING	LENGTH
L1	S11°43'42"W	181.62 FT
L2	S54°40'41"E	307.74 FT
L3	S54°45'36"E	25.01 FT
L4	N84°37'44"W	28.24 FT
L5	N81°44'45"W	11.63 FT
L6	N80°14'53"E	239.84 FT
L7	N35°14'47"E	50.00 FT
L8	S35°14'47"W	1603.75 FT
L9	S35°14'47"W	50.00 FT
L10	S54°45'12"E	25.02 FT
L11	N54°45'12"W	81.65 FT
L12	N69°46'16"W	511.39 FT
L13	N54°56'23"W	107.37 FT
L14	S03°51'57"W	50.00 FT
L15	N35°03'37"E	434.26 FT
L16	N35°03'37"E	264.35 FT

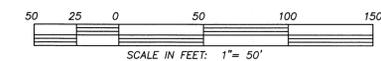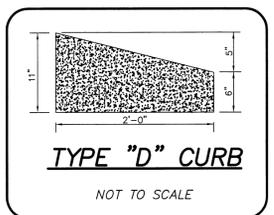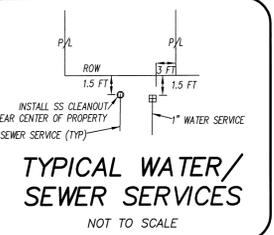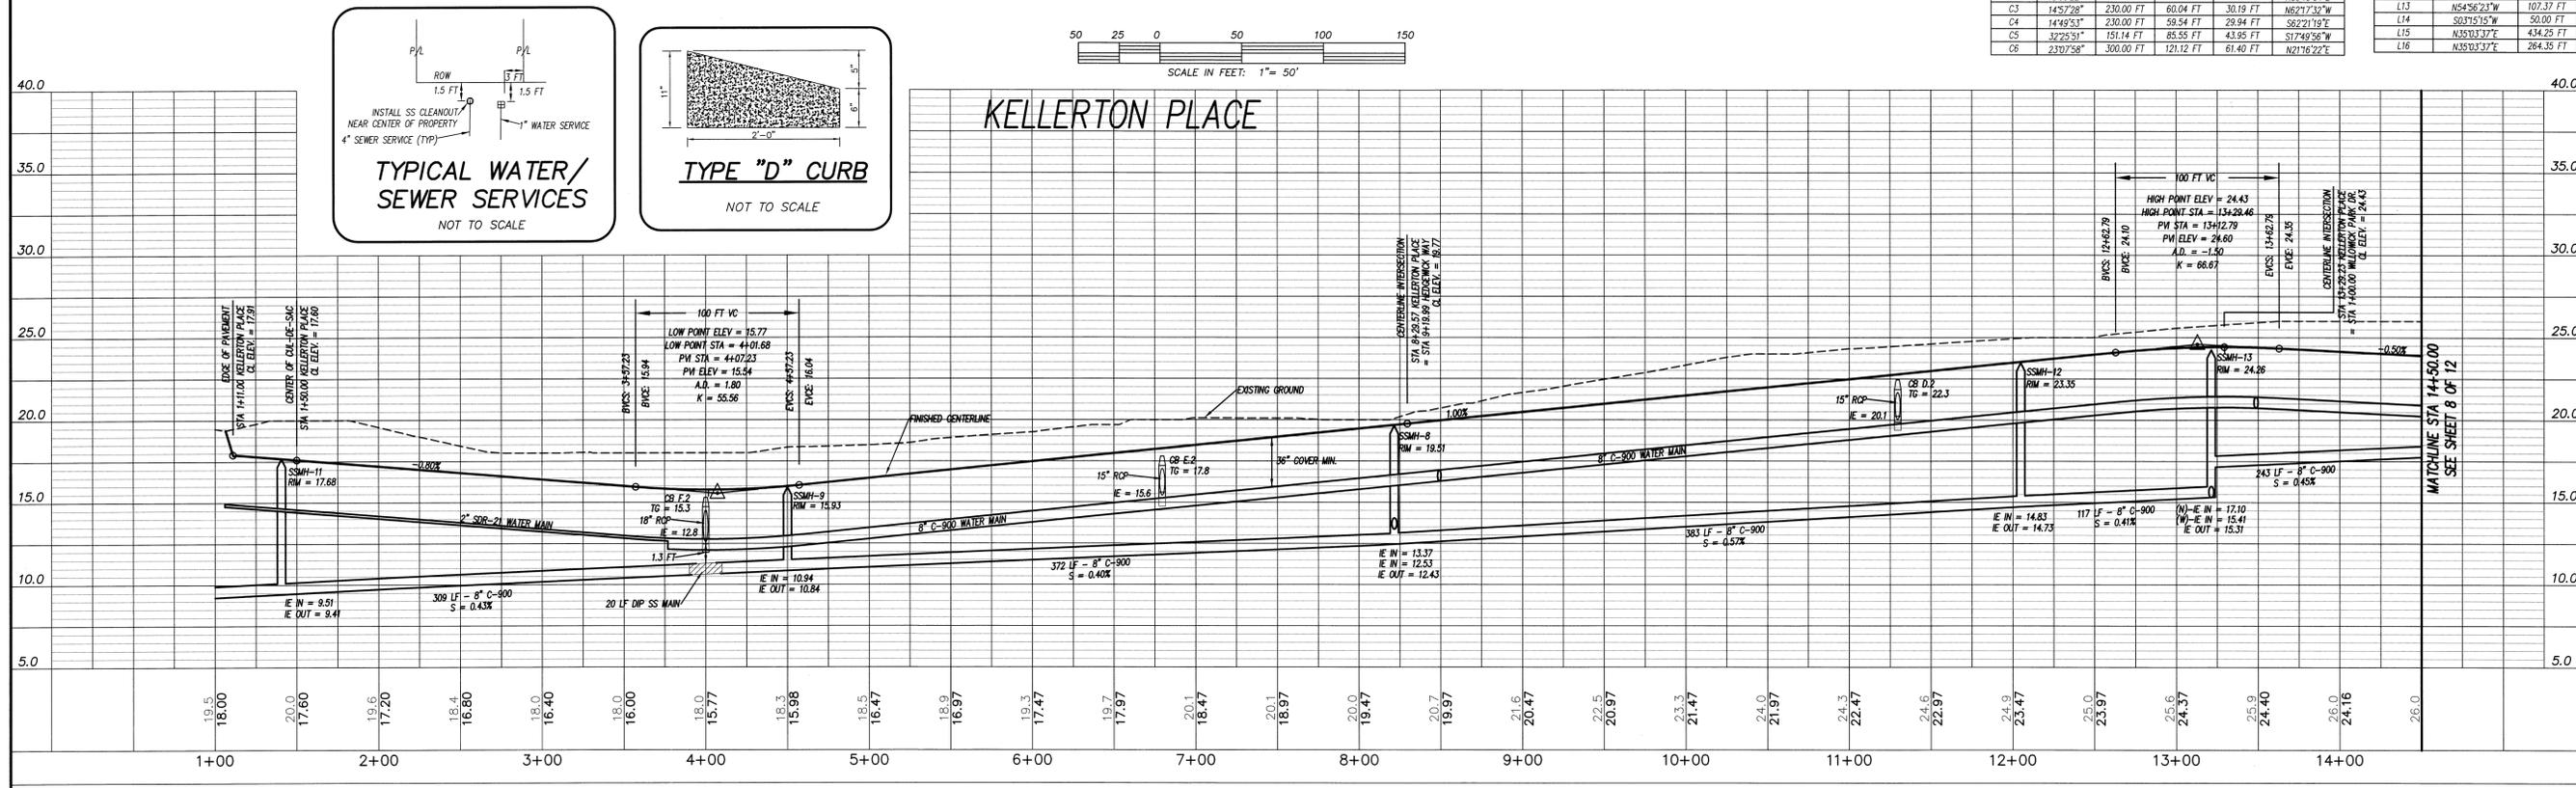

KELLERTON PLACE

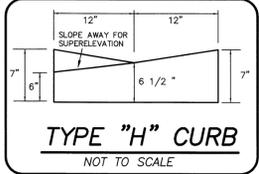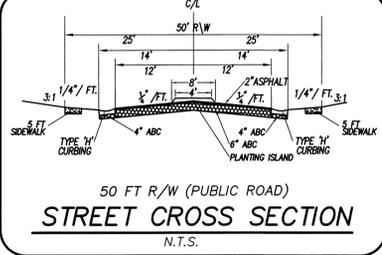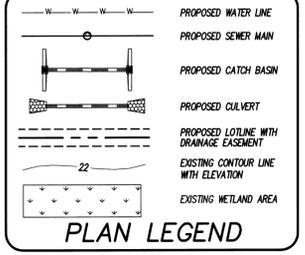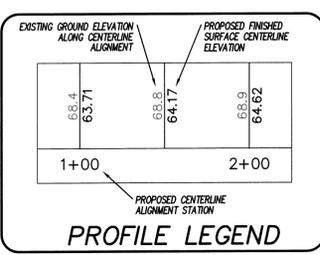

- CFWA STANDARD SEWER NOTES:**
- SEWER GUARDS REQUIRED AT ALL MANHOLES. STAINLESS STEEL SEWER GUARDS REQUIRED AT MANHOLES LOCATED IN TRAFFIC AREAS.
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 - ALL SERVICES TYPING INTO DUCTILE IRON MAINS SHALL BE CONSTRUCTED OF CLASS 50, DIP, WITH PROTECTED 401 CERAMIC EPOXY LINING.
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STORMWATER MANAGEMENT PLAN APPROVED
 CITY OF WILMINGTON
 ENGINEERING DEPARTMENT
 DATE _____ PERMIT # _____
 SIGNED _____

Approved Construction Plan
 Name _____ Date _____
 Planning _____
 Public Utilities _____
 Traffic _____
 Fire _____







STATION 14+50.00 THROUGH END
KELLERTON PLACE
 &
 STATION 1+00.00 THROUGH END
WILLOWICK PARK DRIVE

PLANS & PROFILES for
THE CREEK AT WILLOWICK
 LOCATED IN MASONBORO TOWNSHIP
 NEW HANOVER COUNTY, NORTH CAROLINA
 OWNER: TSV DEVELOPERS, INC.
 1904 EASTWOOD ROAD, SUITE 212
 WILMINGTON, NC 28403



REV. NO.	DATE	BY	REMARKS
1	7/22/13	JSL	REVISED PER CPWA COMMENTS
2	7/30/13	JSL	REVISED SHEET NUMBER
3	09/19/13	JSL	REVISED SS PIPE SLOPE PER CPWA / WATER MAIN RELOCATION
4	12/20/13	JSL	REVISED 2" WATER MAINS
5	11/22/13	JSL	REVISED WATER AND SEWER MAIN LOCATIONS
6	10/10/13	JSL	REVISED PER PUBLIC UTILITY OWNERSHIP
7	8/23/13	JSL	REVISED WATER/SEWER SERVICES, ADDED TYP. DETAIL
8	7/30/13	JSL	REMOVED WATER/SEWER SERVICES, ADDED TYP. DETAIL

DATE: 3-20-08
 HORZ. SCALE: 1" = 50'
 VERT. SCALE: 1" = 5'
 DRAWN BY: JSL
 CHECKED BY: HSR
 PROJECT NO. 04-0011
 DRAWING NO. 04-0011P05
 Sheet No. **8** of **12**

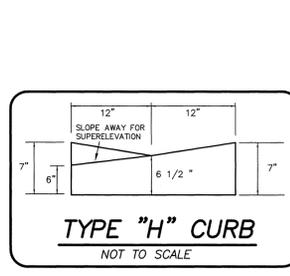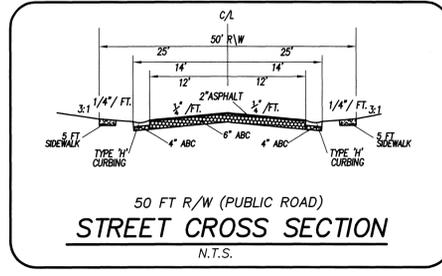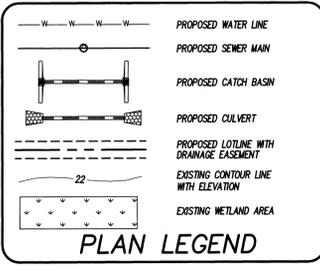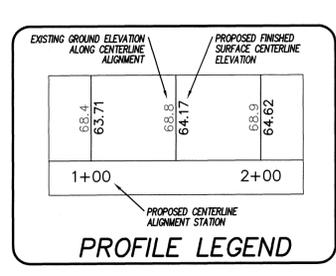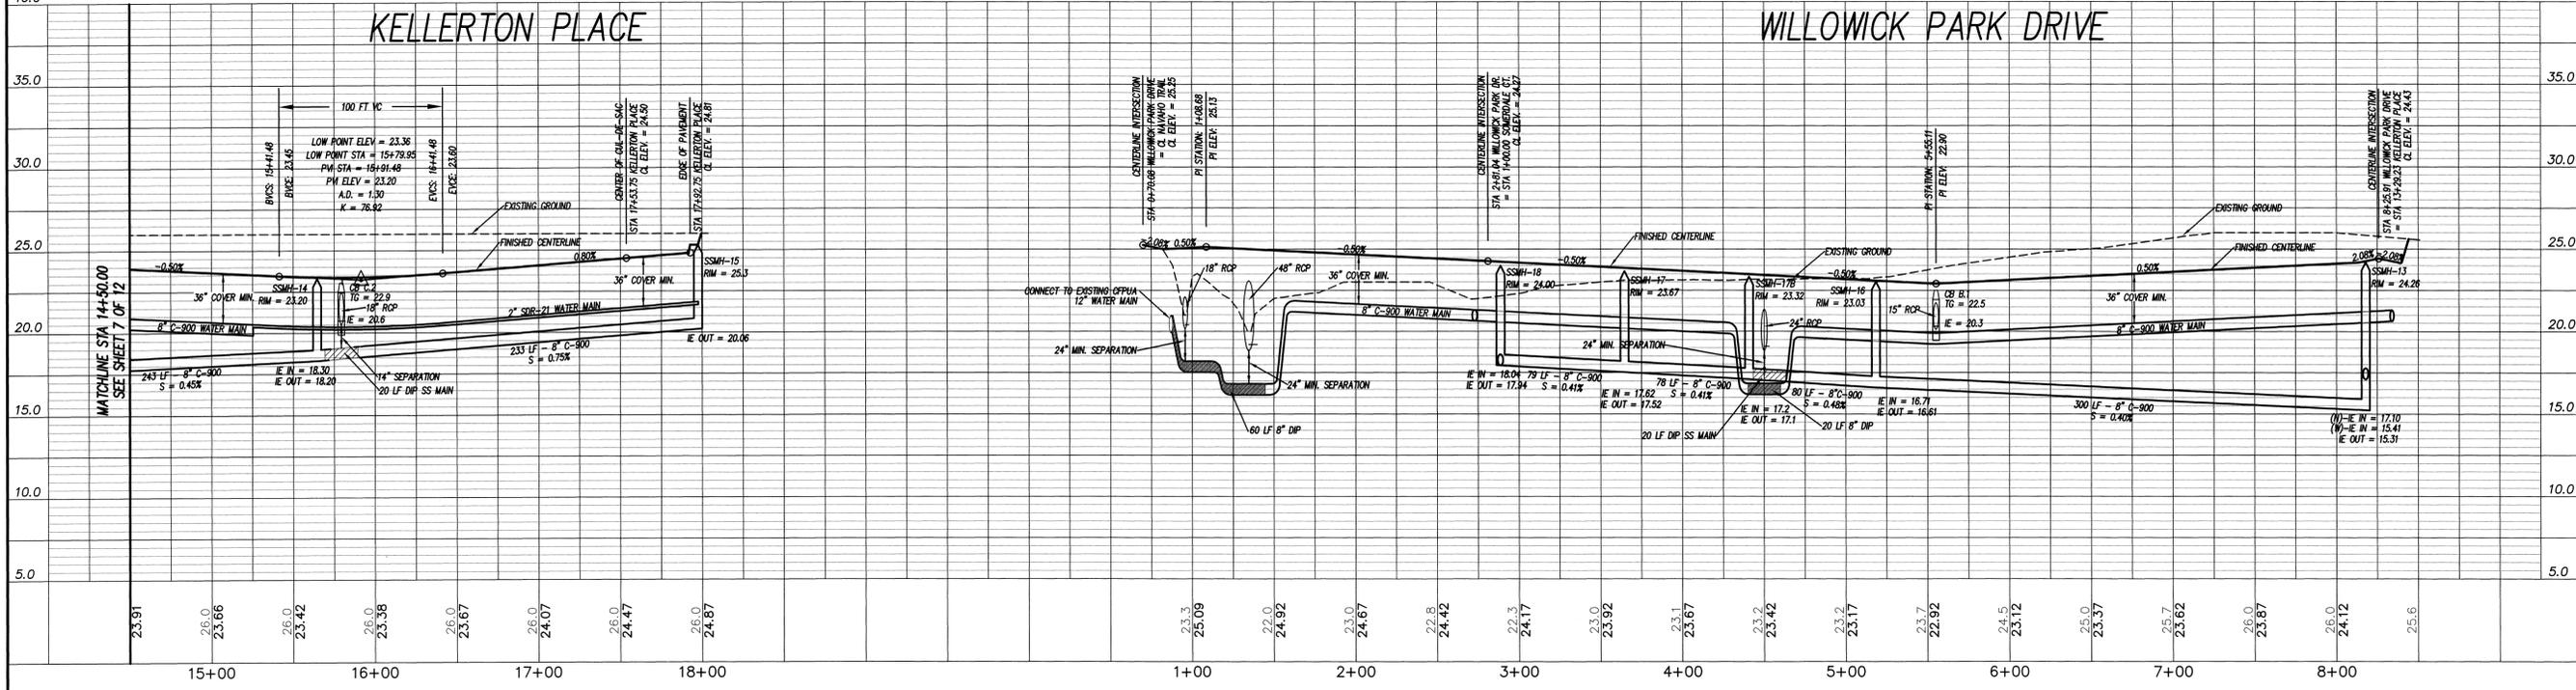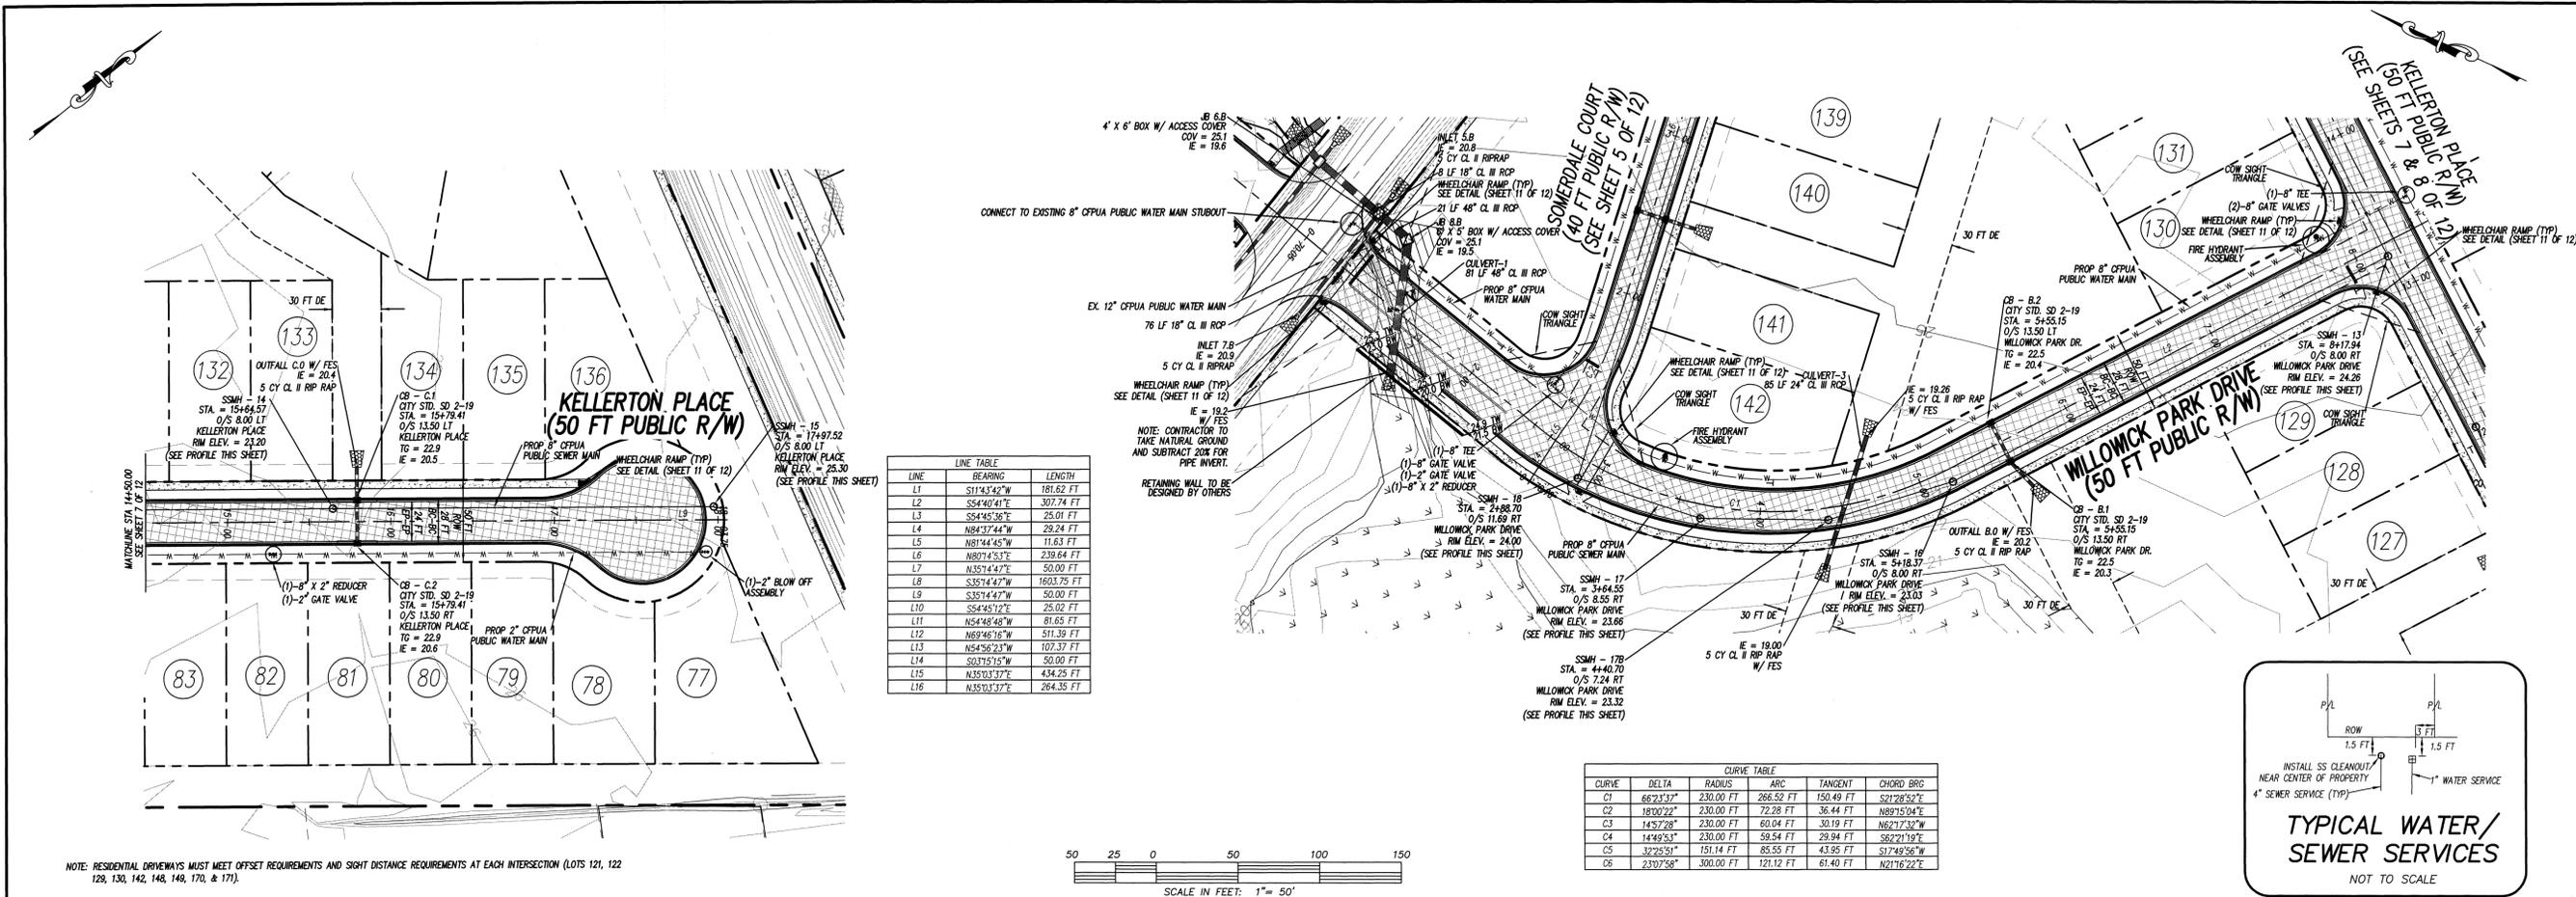

- CPWA STANDARD SEWER NOTES:**
- SEWER GUARDS REQUIRED AT ALL MANHOLES. STAINLESS STEEL SEWER GUARDS REQUIRED AT MANHOLES LOCATED IN TRAFFIC AREAS.
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STORMWATER MANAGEMENT PLAN
APPROVED
 CITY OF WILMINGTON
 ENGINEERING DEPARTMENT
 DATE _____ PERMIT # _____
 SIGNED _____

Approved Construction Plan
 Name _____ Date _____
 Planning _____
 Public Utilities _____
 Traffic _____
 Fire _____

STATION 1+00.00 THROUGH END
 SEWER EXTENSION


PLANS & PROFILES for
THE CREEK AT WILLOWICK
 LOCATED IN WILMINGTON TOWNSHIP
 NEW HANOVER COUNTY, NORTH CAROLINA

OWNER: TSV DEVELOPERS, INC.
 1904 EASTWOOD ROAD,
 WILMINGTON, NC 28403









REVISED WATER AND SEWER LOCATIONS	DATE	REMARKS
6	10/10/13	
7	6/23/13	REVISED PER PUBLIC UTILITY OWNERSHIP
8	7/30/13	REVISED WATER/SEWER SERVICES, ADDED TYP. DETAIL
9	7/22/13	REVISED PER C/P/UA COMMENTS
10	7/10/12	ADDED LICENSE NUMBER
11	08/28/09	REVISED SHEET NUMBER
12	1/2/14	REVISED PER C/P/UA COMMENTS
13	11/22/13	REVISED CONNECTION POINT OF SEWER

DATE: 3-20-08
 HORZ. SCALE: 1" = 50'
 VERT. SCALE: 1" = 5'
 DRAWN BY: JSL
 CHECKED BY: HSR
 PROJECT NO.: 040011
 Sheet No. **9** of **12**

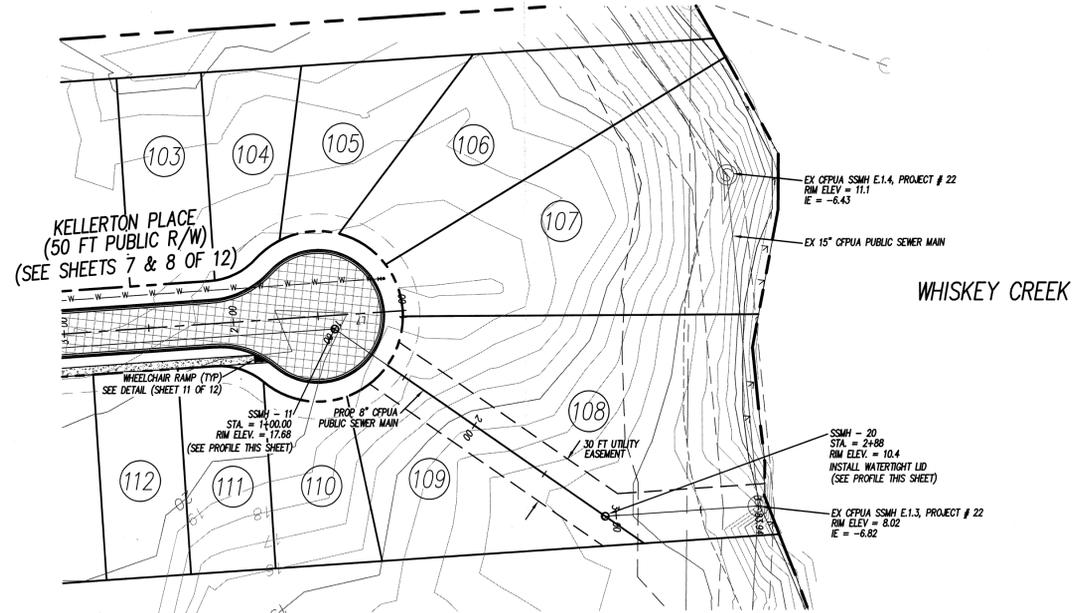

NOTE: RESIDENTIAL DRIVEWAYS MUST MEET OFFSET REQUIREMENTS AND SIGHT DISTANCE REQUIREMENTS AT EACH INTERSECTION (LOTS 121, 122, 129, 130, 142, 148, 149, 170, & 171).

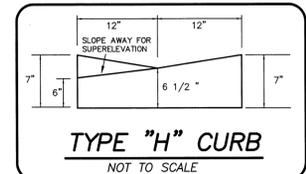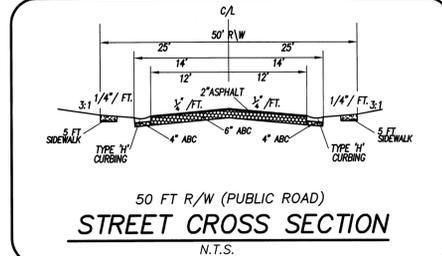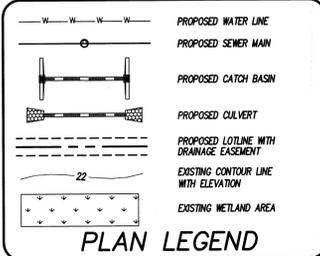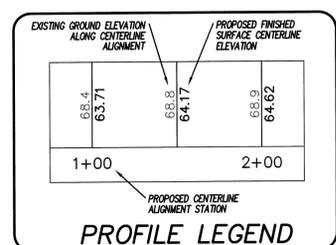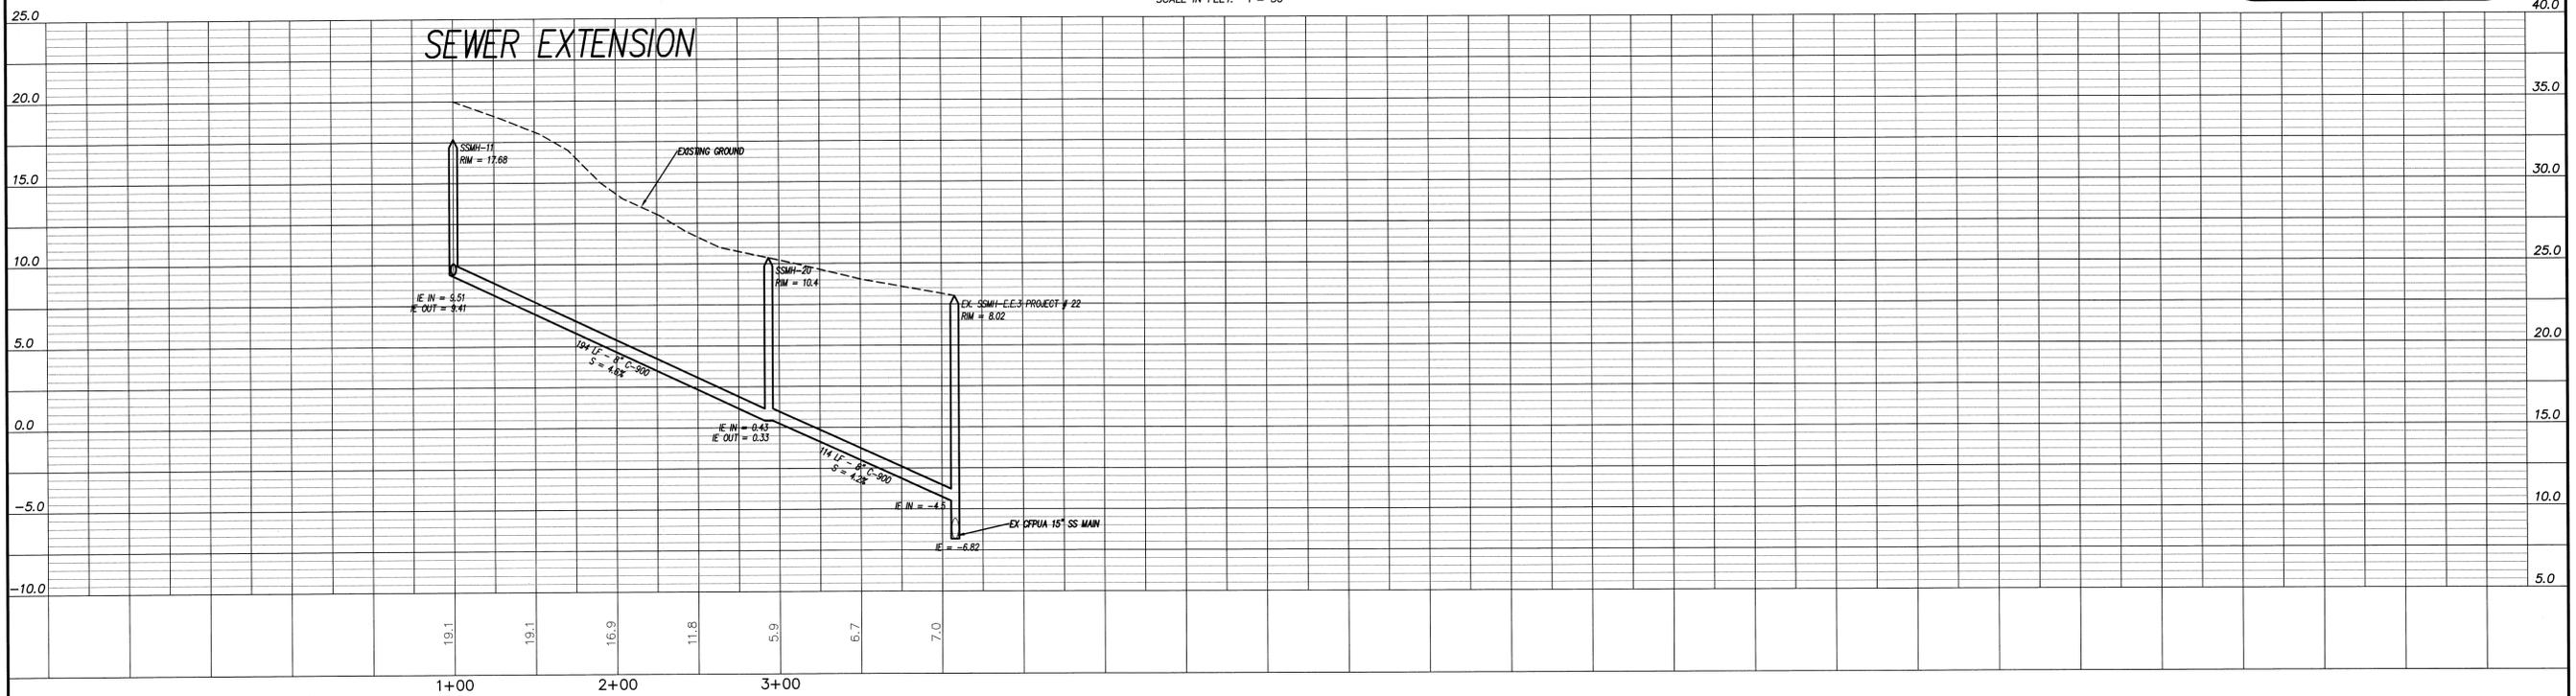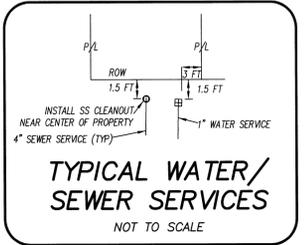



- CEP/UA STANDARD SEWER NOTES:**
- SEWER GUARDS REQUIRED AT ALL MANHOLES. STAINLESS STEEL SEWER GUARDS REQUIRED AT MANHOLES LOCATED IN TRAFFIC AREAS.
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 - ALL SERVICES TING INTO DUCTILE IRON MAINS SHALL BE CONSTRUCTED OF CLASS 50, DP, WITH PROTECTO 401 CERAMIC EPOXY LINING.
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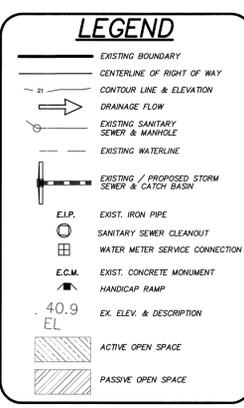
STORMWATER MANAGEMENT PLAN
APPROVED
 CITY OF WILMINGTON
 ENGINEERING DEPARTMENT
 DATE _____ PERMIT # _____
 SIGNED _____

Approved Construction Plan
 Name _____ Date _____
 Planning _____
 Public Utilities _____
 Traffic _____
 Fire _____

LOCATION MAP




- ### UTILITY NOTES:
- PROJECT SHALL COMPLY WITH THE CPVIA CROSS CONNECTION CONTROL REQUIREMENTS. WATER METER(S) CANNOT BE SET AND ACTIVATED ON NEW MAINS UNTIL ALL REQUIREMENTS ARE MET. CALL 790-8064 FOR INFORMATION.
 - IF THE CONTRACTOR DESIRES CPVIA WATER FOR CONSTRUCTION HE SHALL APPLY IN ADVANCE FOR THIS SERVICE AND MUST PROVIDE A REDUCED PRESSURE ZONE (RPZ) BACKFLOW PREVENTION DEVICE ON THE DEVELOPER'S SIDE OF THE WATER METER BOX.
 - ALL COMMERCIAL WATER SERVICES AND ANY IRRIGATION SYSTEMS SUPPLIED BY CPVIA WATER SHALL HAVE A BACKFLOW PREVENTION DEVICE ACCEPTABLE TO THE CITY AND APPROVED BY USOCFOCHR OR ASSE. CALL 343-3910 FOR INFORMATION.
 - WHEN PVC WATER MAINS AND/OR POLYETHYLENE SERVICES ARE PROPOSED, THE PIPES ARE TO BE MARKED WITH NO. 10 INSULATED COPPER WIRE INSTALLED THE ENTIRE LENGTH AND STRIPPED TO THE PIPES WITH DUCT TAPE. THE INSULATED WIRE IS TO BE STRIPPED TO BARE WIRE AND SECURED TO ALL VALVES AND FITTINGS. THE WIRE IS TO BE ACCESSIBLE AT ALL FIRE HYDRANTS AND WATER METER BOXES TO AID IN FUTURE LOCATION OF FACILITIES.
 - 36" MINIMUM COVER OVER ALL WATER MAINS.
 - ANY SEPARATE CONNECTION FOR IRRIGATION SHALL COMPLY WITH CPVIA CROSS-CONNECTION REQUIREMENTS WITH APPROVED BACKFLOW PREVENTION DEVICES.
 - AT LOCATIONS WHERE WATER MAIN CROSSES UNDER STORM SEWER, A MINIMUM OF 18" VERTICAL SEPARATION SHALL BE PROVIDED.
 - ALL WATER MAINS TO BE C-900.
 - EASEMENTS FROM ADJACENT PROPERTY TO BE OBTAINED FOR SERVICE LINE LOCATIONS.
 - WATER AND SEWER SERVICES CANNOT BE ACTIVATED ON NEW MAINS UNTIL ENGINEER'S CERTIFICATION AND AS-BUILTS ARE RECEIVED AND "FINAL APPROVAL" ISSUED BY PUBLIC WATER SUPPLY SECTION OF NCDENR AND "FINAL ENGINEERING CERTIFICATION" ISSUED BY DIVISION OF WATER QUALITY OF NCDENR.
 - LANDSCAPING CANNOT BLOCK OR IMPEDE THE FDC OR FIRE HYDRANTS. A 3 FT CLEAR SPACE SHALL BE MAINTAINED AROUND THE CIRCUMFERENCE OF THE FDC AND FIRE HYDRANT.
 - HYDRANTS MUST BE LOCATED WITHIN 8 FT OF THE CURB.
 - NEW HYDRANTS MUST BE AVAILABLE FOR USE PRIOR TO CONSTRUCTION OF THE BUILDINGS.
 - CONTRACTOR SHALL MAINTAIN AN ALL WEATHER ACCESS FOR EMERGENCY VEHICLES AT ALL TIMES DURING CONSTRUCTION.
 - TEMPORARY STREET SIGNS SHALL BE INSTALLED AT EACH STREET INTERSECTION WHEN CONSTRUCTION OF NEW ROADWAYS ALLOWS PASSAGE BY VEHICLES.
 - A 10 FT NON-MUNICIPAL UTILITY EASEMENT IS TO BE PROVIDED TO THE OUTSIDE OF ALL RIGHTS OF WAY.

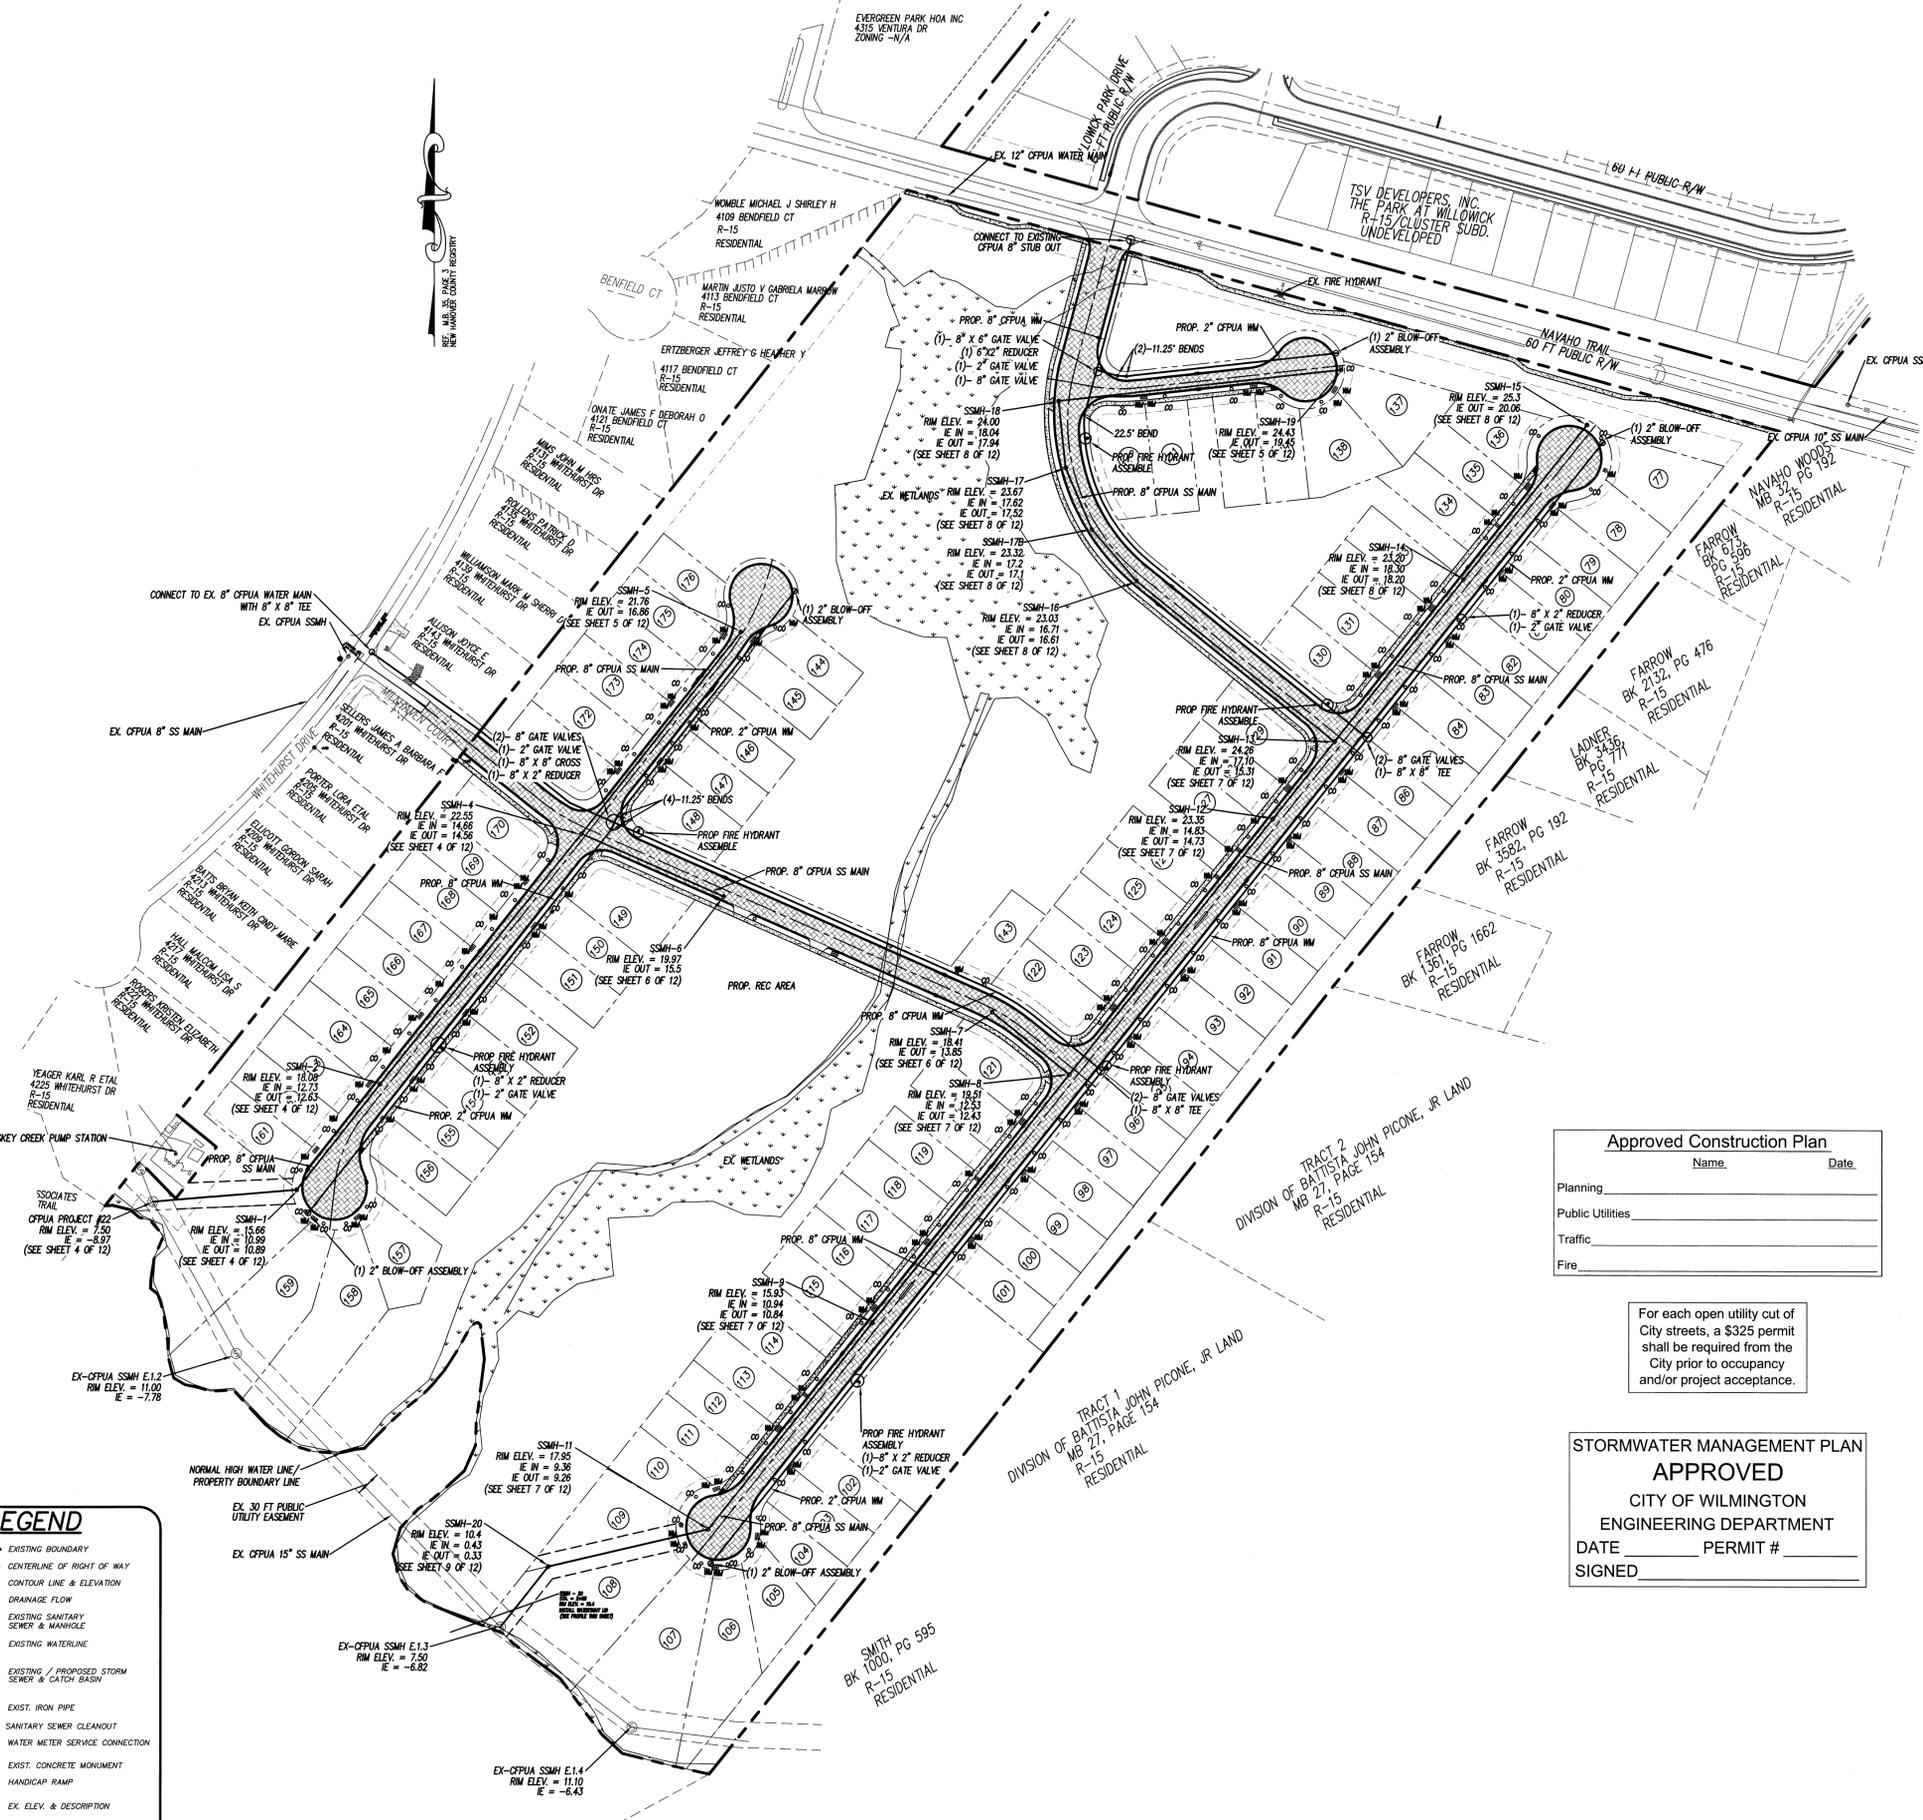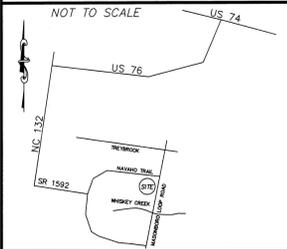

Approved Construction Plan	
Name	Date
Planning	
Public Utilities	
Traffic	
Fire	

For each open utility cut of City streets, a \$325 permit shall be required from the City prior to occupancy and/or project acceptance.


STORMWATER MANAGEMENT PLAN
APPROVED
 CITY OF WILMINGTON
 ENGINEERING DEPARTMENT
 DATE _____ PERMIT # _____
 SIGNED _____

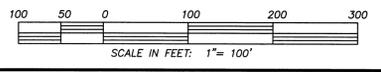

LICENSE # C-2710
COASTAL SITE DESIGN, PC
 ENGINEERING
 LAND PLANNING
 COMMERCIAL / RESIDENTIAL
 P.O. Box 4041
 Wilmington, NC 28406
 (910) 791-4441

UTILITY PLAN for
THE CREEK AT WILLOW
 THE CREEK AT WILLOW




UTILITY PLAN for
THE CREEK AT WILLOW
 LOCATED IN MASONBORO TOWNSHIP
 NEW HANOVER COUNTY, NORTH CAROLINA
 OWNER: TSV DEVELOPERS, INC.
 1904 EASTWOOD ROAD, SUITE 212
 WILMINGTON, NC 28403

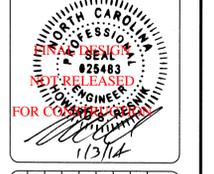





REV. NO.	DATE	BY	REMARKS
1	7/10/22	RLW	ADDED LICENSE NUMBER
2	10/26/23	JDM	REVISED PER CPVIA COMMENTS
3	09/28/23	RLW	REVISED PER LEGEND CHANGES
4	11/22/23	RLW	REVISED SEWER CONNECTION
5	11/22/23	RLW	REVISED WATER AND SEWER MAIN LOCATIONS
6	10/10/23	JSM	REVISED PER TRC COMMENTS
7	8/23/23	JSM	REVISED PER CPVIA COMMENTS
8	7/22/23	JSM	REVISED PER CPVIA COMMENTS

DATE: 05-03-07
 HORZ. SCALE: 1" = 100'
 DRAWN BY: CSH
 CHECKED BY: HSR
 PROJECT NO: 04-0011
 DRAWING NO: 04-0011UTL-PH2

LOCATION MAP

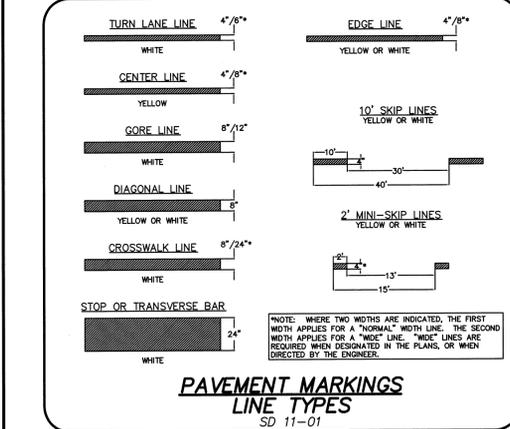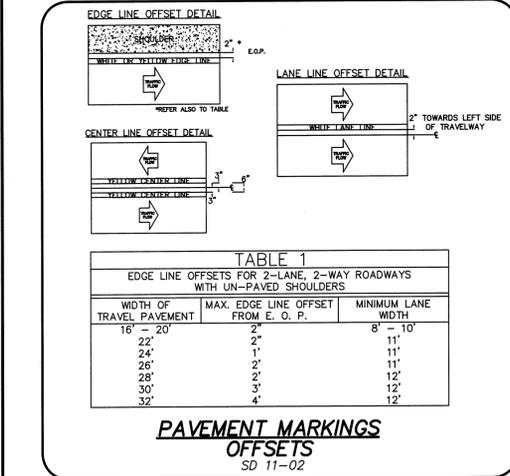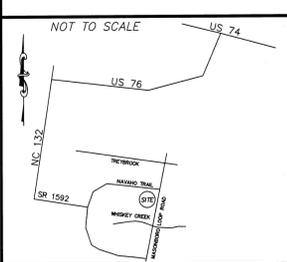


NOTE: ALL SIGNS MOUNTED AT 7'. CONTACT TRAFFIC ENGINEERING PRIOR TO TRAFFIC SIGN INSTALLATION.

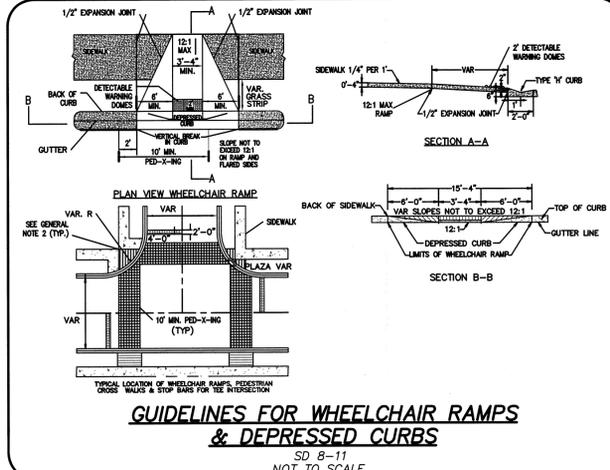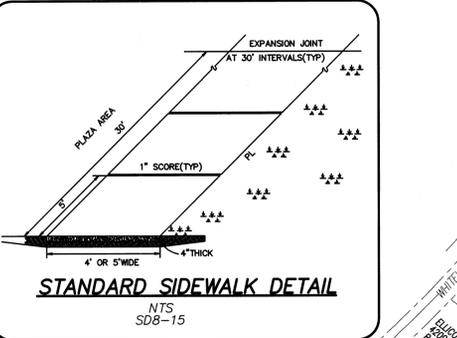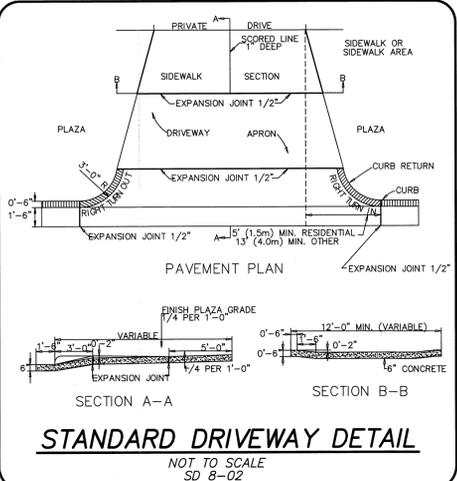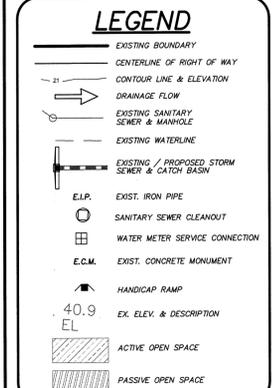

Approved Construction Plan
Name _____ Date _____


Planning _____
Public Utilities _____
Traffic _____
Fire _____

For each open utility cut of City streets, a \$325 permit shall be required from the City prior to occupancy and/or project acceptance.


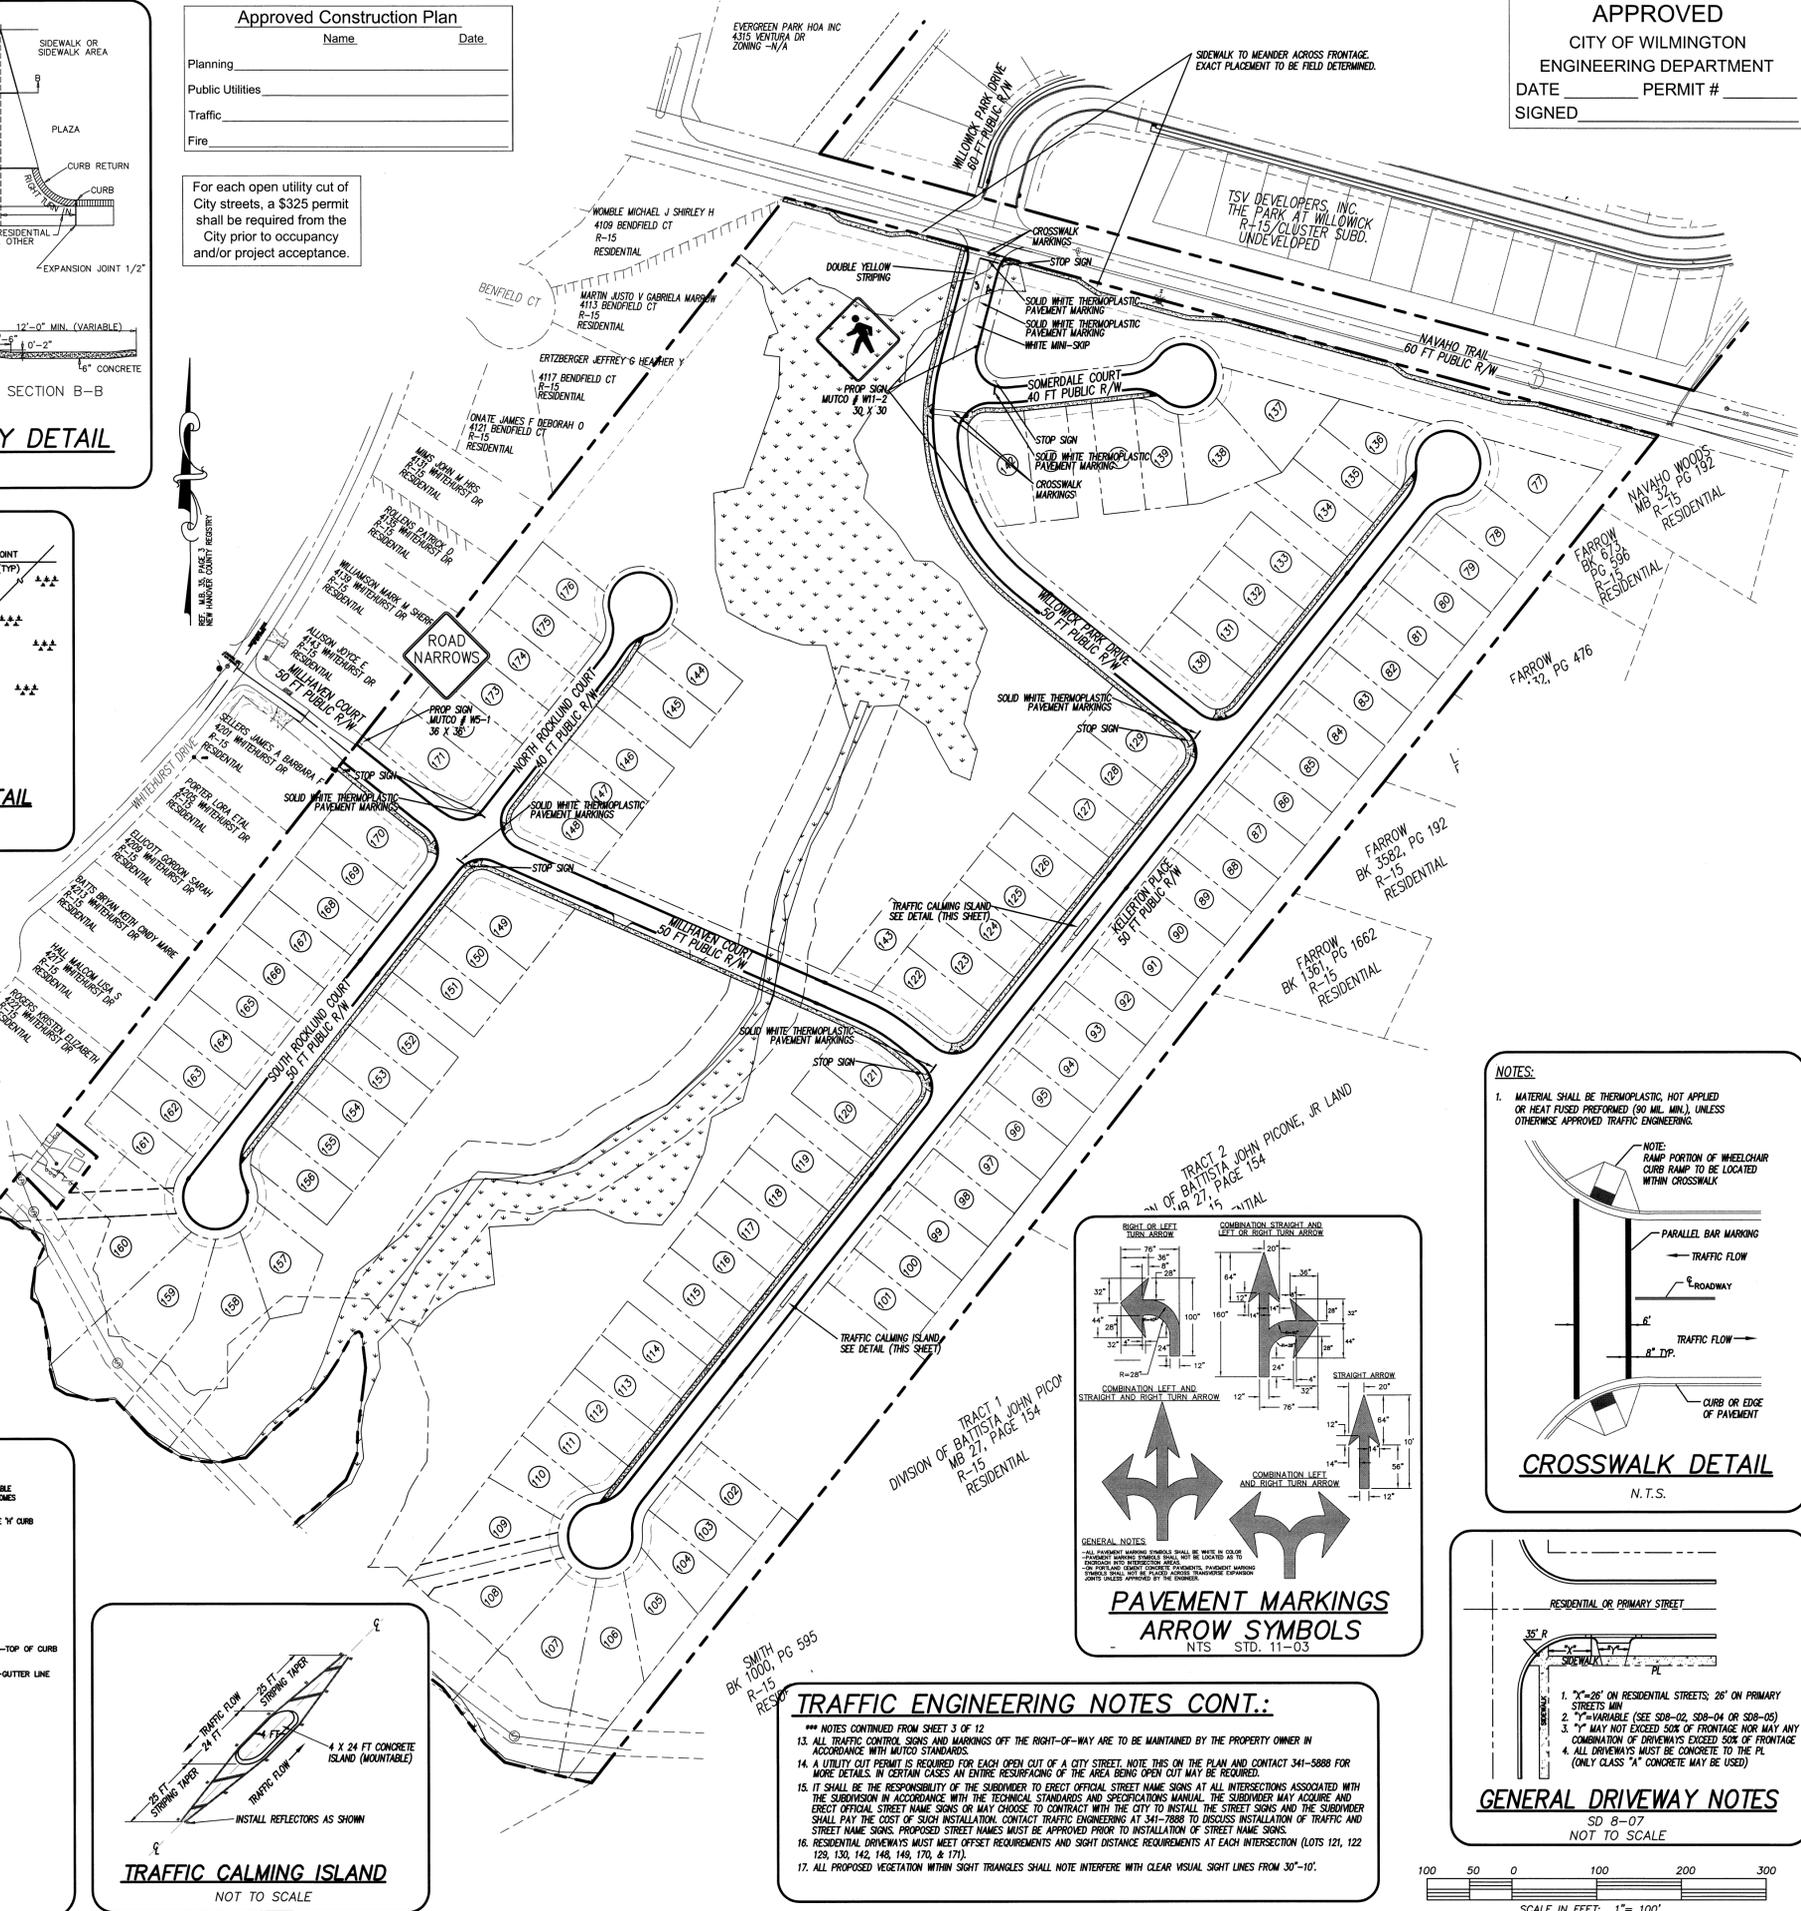


STORMWATER MANAGEMENT PLAN
APPROVED
CITY OF WILMINGTON
ENGINEERING DEPARTMENT
DATE _____ PERMIT # _____
SIGNED _____

SIGNAGE PLAN for
THE CREEK AT WILLOWICK
LOCATED IN MASONBORO TOWNSHIP
NEW HANOVER COUNTY, NORTH CAROLINA
OWNER: TSV DEVELOPERS, INC.
1904 EASTWOOD ROAD, SUITE 212
WILMINGTON, NC 28403

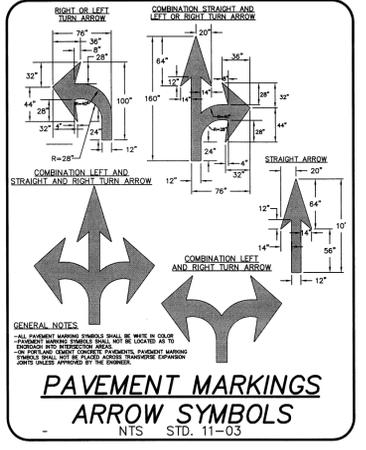

- TRAFFIC ENGINEERING NOTES CONT.:**
- ALL TRAFFIC CONTROL SIGNS AND MARKINGS OFF THE RIGHT-OF-WAY ARE TO BE MAINTAINED BY THE PROPERTY OWNER IN ACCORDANCE WITH MUTCD STANDARDS.
 - A UTILITY CUT PERMIT IS REQUIRED FOR EACH OPEN CUT OF A CITY STREET. NOTE THIS ON THE PLAN AND CONTACT 341-5888 FOR MORE DETAILS. IN CERTAIN CASES AN ENTIRE RESURFACING OF THE AREA BEING OPEN CUT MAY BE REQUIRED.
 - IT SHALL BE THE RESPONSIBILITY OF THE SUBDIVIDER TO ERECT OFFICIAL STREET NAME SIGNS AT ALL INTERSECTIONS ASSOCIATED WITH THE SUBDIVISION IN ACCORDANCE WITH THE TECHNICAL STANDARDS AND SPECIFICATIONS MANUAL. THE SUBDIVIDER MAY ACQUIRE AND ERECT OFFICIAL STREET NAME SIGNS OR MAY CHOOSE TO CONTRACT WITH THE CITY TO INSTALL THE STREET SIGNS AND THE SUBDIVIDER SHALL PAY THE COST OF SIGN INSTALLATION. CONTACT TRAFFIC ENGINEERING AT 341-7888 TO DISCUSS INSTALLATION OF TRAFFIC AND STREET NAME SIGNS. PROPOSED STREET NAMES MUST BE APPROVED PRIOR TO INSTALLATION OF STREET NAME SIGNS.
 - RESIDENTIAL DRIVEWAYS MUST MEET OFFSET REQUIREMENTS AND SIGHT DISTANCE REQUIREMENTS AT EACH INTERSECTION (LOTS 121, 122, 129, 130, 142, 148, 149, 170, & 171).
 - ALL PROPOSED VEGETATION WITHIN SIGHT TRIANGLES SHALL NOT INTERFERE WITH CLEAR VISUAL SIGHT LINES FROM 30'-10'.

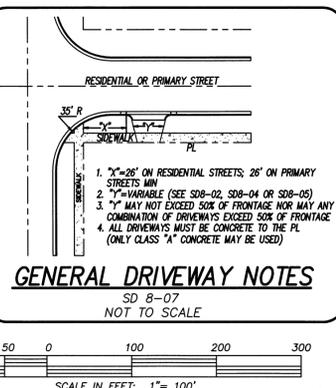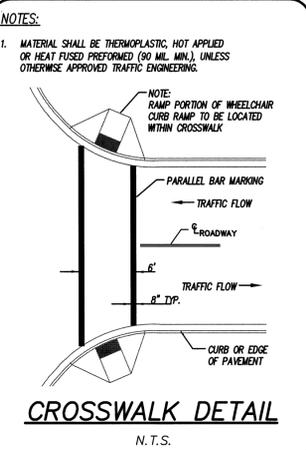


REV. NO.	DATE	BY	REMARKS
1	11/12/08	JH	REVISED PER LEGEND CHANGES
2	08/28/09	RLW	ADDED SHEET NUMBER
3	7/10/12	JSM	REVISED PER LEGEND CHANGES
4	7/22/13	JSM	ADDED COW DETAILS
5	10/19/13	JSM	REVISED PER TRAFFIC ENGINEERING
6	10/29/13	JSM	REVISED PER TRAFFIC ENGINEERING
7	1/23/14	RLW	REVISED SIDEWALK LOCATION ALONG NAVAHO STREETS MIN

DATE: 09-09-08
HORZ. SCALE: 1" = 100'
DRAWN BY: JSL
CHECKED BY: HSR
PROJECT NO: 04-0011
DRAWING NO: 04-0011SIGN-PH2



LOCATION MAP

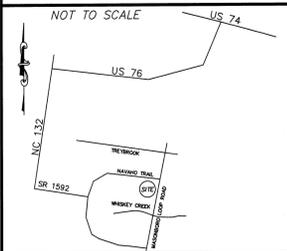

LEGEND

- TOB
- EXISTING TREE TO BE REMOVED
- EXISTING TREE
- CRITICAL ROOT ZONE
- TREE PROTECTION FENCING
- LIMITS OF DISTURBANCE / CLEARING LIMITS

GENERAL NOTES:


1. BOUNDARY AND TREE INFORMATION PREPARED AND PROVIDED BY ARNOLD CARSON, PLS, PC.
2. THIS PLAN SHEET DOES NOT PROPRIETARY TO SHOW ANY DESIGN INFORMATION, BUT RATHER ONLY DISPLAYS THE EXISTING SITE BOUNDARY AND TREES AS PROVIDED BY THE SURVEYOR.

ENVIRONMENTAL NOTES:

1. ALL SIGNIFICANT TREES ON SITE ARE TO BE RETAINED OR MITIGATED.
2. NO LAND DISTURBANCE IS PERMITTED OUTSIDE THE DESIGNATED LIMITS OF DISTURBANCE FOR SITE IMPROVEMENTS OTHER THAN WHAT IS NECESSARY TO TIE INTO EXISTING CONTIGUOUS OR MEET LANDSCAPING REQUIREMENTS.
3. ALL TREES OUTSIDE THE LIMITS OF DISTURBANCE ON SITE ARE TO BE PRESERVED.
 - THE 25 FT PERIMETER BUFFER AND ALL AREAS OUTSIDE OF CLEARING LIMITS ARE TO BE TREE SAVE AREAS. THE CONTRACTOR / DEVELOPER WILL NEED INSTALL TREE PROTECTION FENCING WHERE NECESSARY IN ADDITION TO SILT FENCE.
4. TREE WELLS TO BE PROVIDED AND INSTALLED AS NECESSARY TO MAINTAIN EXISTING GRADE AT ROOT ZONE (TREE CANOPY) OF TREES TO BE PRESERVED.
5. JURISDICTIONAL DETERMINATION FROM USACE HAS BEEN PERFORMED.
6. WATER BODY SERVING THIS SITE IS WHISKEY CREEK SA-HOH.

TREE PROTECTION NOTES:


1. DO NOT COMPACT SOIL BENEATH TREES. NO VEHICLE SHALL BE ALLOWED TO PARK UNDER TREES. NO HEAVY MATERIALS SHALL BE STORED BENEATH TREES. RESULTS OF COMPACTION CAUSE WATER AND AIR NOT TO REACH THE ROOTS AND THE TREE WILL DIE. THESE "FEEDING ROOTS" OCCUR WELL AWAY FROM THE BASE OF THE TREE TO THE EDGE OF THE OVERHEAD BRANCH CANOPY. DAMAGING THE BARK WITH LAWNMOWERS, CONSTRUCTION EQUIPMENT, OR ANYTHING ELSE IS PROHIBITED. PROTECTIVE BARRIERS SHOULD PREVENT DAMAGE FROM OCCURRING DURING CONSTRUCTION.
2. NO CUTTING OF LARGE STRUCTURAL ROOTS LOCATED NEAR THE BASE OF THE TRUNK. THESE ARE ESSENTIAL IN SUPPORTING THE TREE AND HOLDING IT UPRIGHT IN HIGH WINDS. REMOVAL OF THESE ROOTS ALONG ONE SIDE IS OFTEN DONE BECAUSE OF A WALK, PAVING OR BUILDING WHICH IS BEING CONSTRUCTED.
3. AVOID CUT AND FILL WITHIN DIAMETER OF TREE CROWN DURING EXCAVATION.

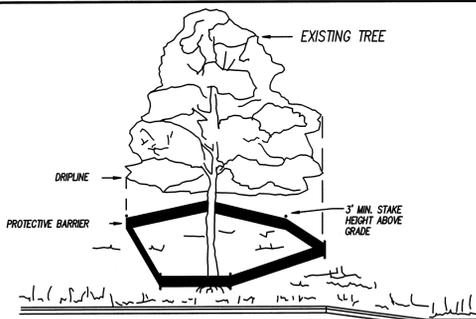

TREES TO BE SAVED WILL BE CLEARLY MARKED PRIOR TO CONSTRUCTION AND A PROTECTIVE BARRIER IS TO BE INSTALLED AT THE DRIPLINE.
 DRIP LINE - THE AREA OF SOIL DIRECTLY BENEATH THE TREE EXTENDING OUT TO THE TIPS OF THE OUTERMOST BRANCHES.

METHOD OF TREE PROTECTION DURING CONSTRUCTION

NTS
SD15-08

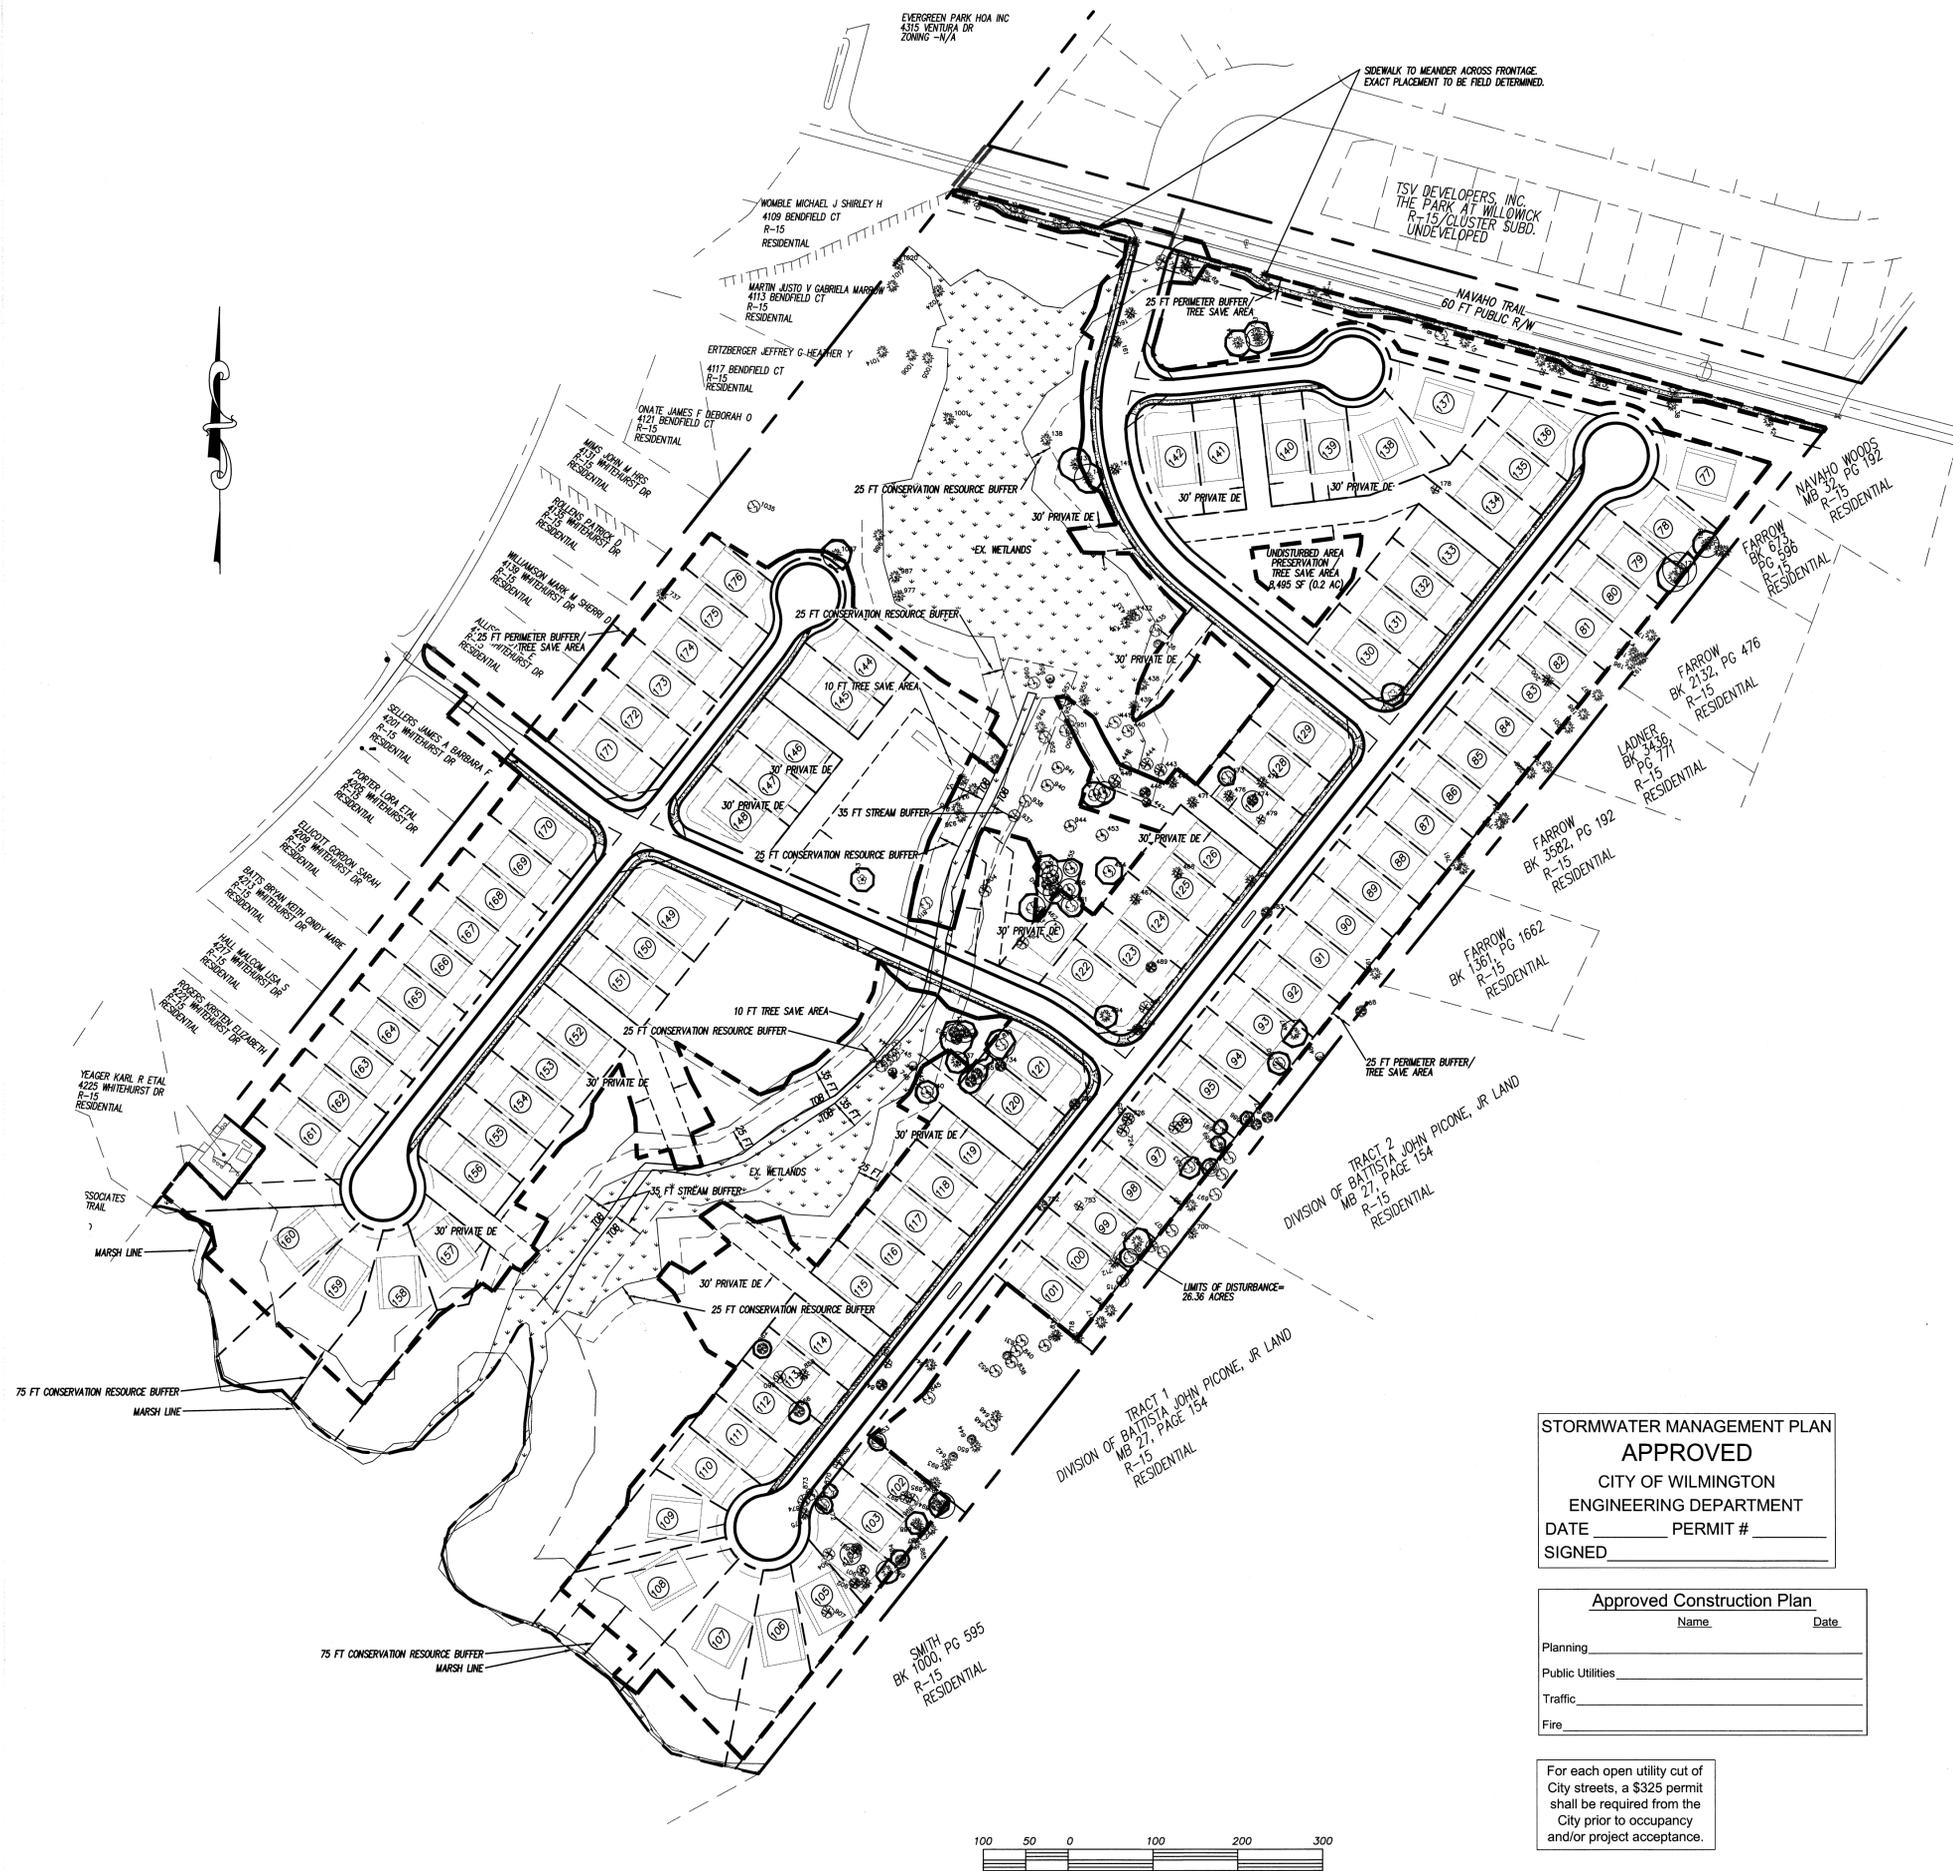

STORMWATER MANAGEMENT PLAN
APPROVED
 CITY OF WILMINGTON
 ENGINEERING DEPARTMENT
 DATE _____ PERMIT # _____
 SIGNED _____

Approved Construction Plan
 Name _____ Date _____
 Planning _____
 Public Utilities _____
 Traffic _____
 Fire _____

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LICENSE # C-2710
COASTAL SITE DESIGN, PC
 ENGINEERING
 LAND PLANNING
 COMMERCIAL / RESIDENTIAL
 P.O. Box 4041
 Wilmington, NC 28406
 (910) 791-4441

TREE REMOVAL AND CLEARING PLAN for
THE CREEK AT WILLOWICK

TREE REMOVAL AND CLEARING PLAN for
THE CREEK AT WILLOWICK
 LOCATED IN MASONBORO TOWNSHIP
 NEW HANOVER COUNTY, NORTH CAROLINA
 OWNER: TSV DEVELOPERS, INC.
 1904 EASTWOOD ROAD, SUITE 212
 WILMINGTON, NC 28403



REV. NO.	REMARKS	DATE	BY
1	ADDED STREAM AND CONSERVATION BUFFERS	8/23/13	JSM
2	REVISED PER CITY OF WILMINGTON PLANNING COMMENTS	10/10/13	JSM
3	REVISED SIDEWALK LOCATION ALONG NAVAHO	1/7/14	RLW

DATE: 07-22-13
 HORZ. SCALE: 1" = 100'
 DRAWN BY: JSM
 CHECKED BY: HSR
 PROJECT NO: 04-0011
 DRAWING NO: 04-0011PH2sp.3