Engineering has reviewed the plans for the Woodlands Landing at Echo Farms-Tract 3A project submitted February 1, 2019 and have the following comments:

***Woodlands at Echo Farms-Phase 3B will have to be modified from a high density permit to an offsite permit with the removal of Pond 3.1B from the permit documents. Modified application, supplements, O&Ms, calculations, plans and any other pertinent documentation will need to be submitted for review along with a \$500 permit modification fee. Coordinate with Norris & Tunstall to determine who will handle the modification.

Stormwater Management Permit Application Form (Form SWP 2.2)

- 1. IV. Project Information: #2, #4 and #5: Make sure the Total Property Area, Total Surface Water Area and Total Project Area is correct for the boundary that includes Pond 3.1B.
- 2. IV. Project Information:
 - a. #9: Make sure this table includes all on-site newly constructed impervious surface area for the updated project area. Update #10 and #11, if necessary.
 - b. #12: This must include the newly constructed impervious surface in the Echo Farms Blvd/Belfairs/Midvale roundabout (Midvale connection) and the Chastain Drive connection in Phase 3B (see attachment).
 - c. Pond 3.1B needs to be added to the table. On-site drainage area is for 3A only. Off-site drainage area is for Phase 3B. All Phase 3B impervious (including any 3B Future Development) will be listed as 'Offsite'.

Supplement-EZ Form

- 3. Supplement EZ form needs to include Pond 3.1B.
- 4. Minor revision: Both Wet Ponds: Wet Pond MDC from 02H .1053: #5: Depth of forebay at exit (inches): Enter 48 inches for 3A-1 and 36 inches for 3A-2. Because this is a state form, everything needs to be entered correctly.

Operation & Maintenance Agreement

- 5. The pond information for ponds 3A-1 and 3A-2 has been reversed (see attached).
- 6. Submit a fully executed O&M for Pond 3B.1.


Stormwater and Erosion Control Narrative


- 7. **Placeholder**: Provide permit for impacting wetlands.
- 8. Update Narrative and calculations to include Pond 3.1B. Because the proposed 3A drainage and impervious areas are less than what was proposed in the 3B SW permit, Pond 3.1B needs to be reassessed using the actual square footages to see if the water quality (1.5") and water quantity (pre/post) requirements are still being met. Modification of Pond 3.1B may be required.
- 9. Storm Drain Design Computations: Pond 3.1B: The inlet drainage area for DI-3.1B-4 is shown to be 0.16 acres. This is in conflict with the drainage area permitted in Phase 3B for the same structure (0.50 acres). Also, Phase 3B has this same structure as a flared end section to collect runoff from a swale that runs along the rear of Phase 3B lots. Phase 3A should fully incorporate the approved Phase 3B permit plans.

<u>Plans</u>


- 10. Provide the landscaping plan. I need them submitted by the responsible party for review. I cannot release the project until landscape plans are submitted and reviewed.
- 11. Provide the 10' maintenance and access shoulder and 5' landscape buffer around the perimeter of the wet ponds per section V-4 (g & h) of the technical standards. Show on plans.
- 12. See marked-up construction plans for further review comments.


Please submit one complete set of plans, the stormwater narrative, application, calculations and any other supporting documentation to Engineering for additional review. Please call or email if there are any questions. Thank you.

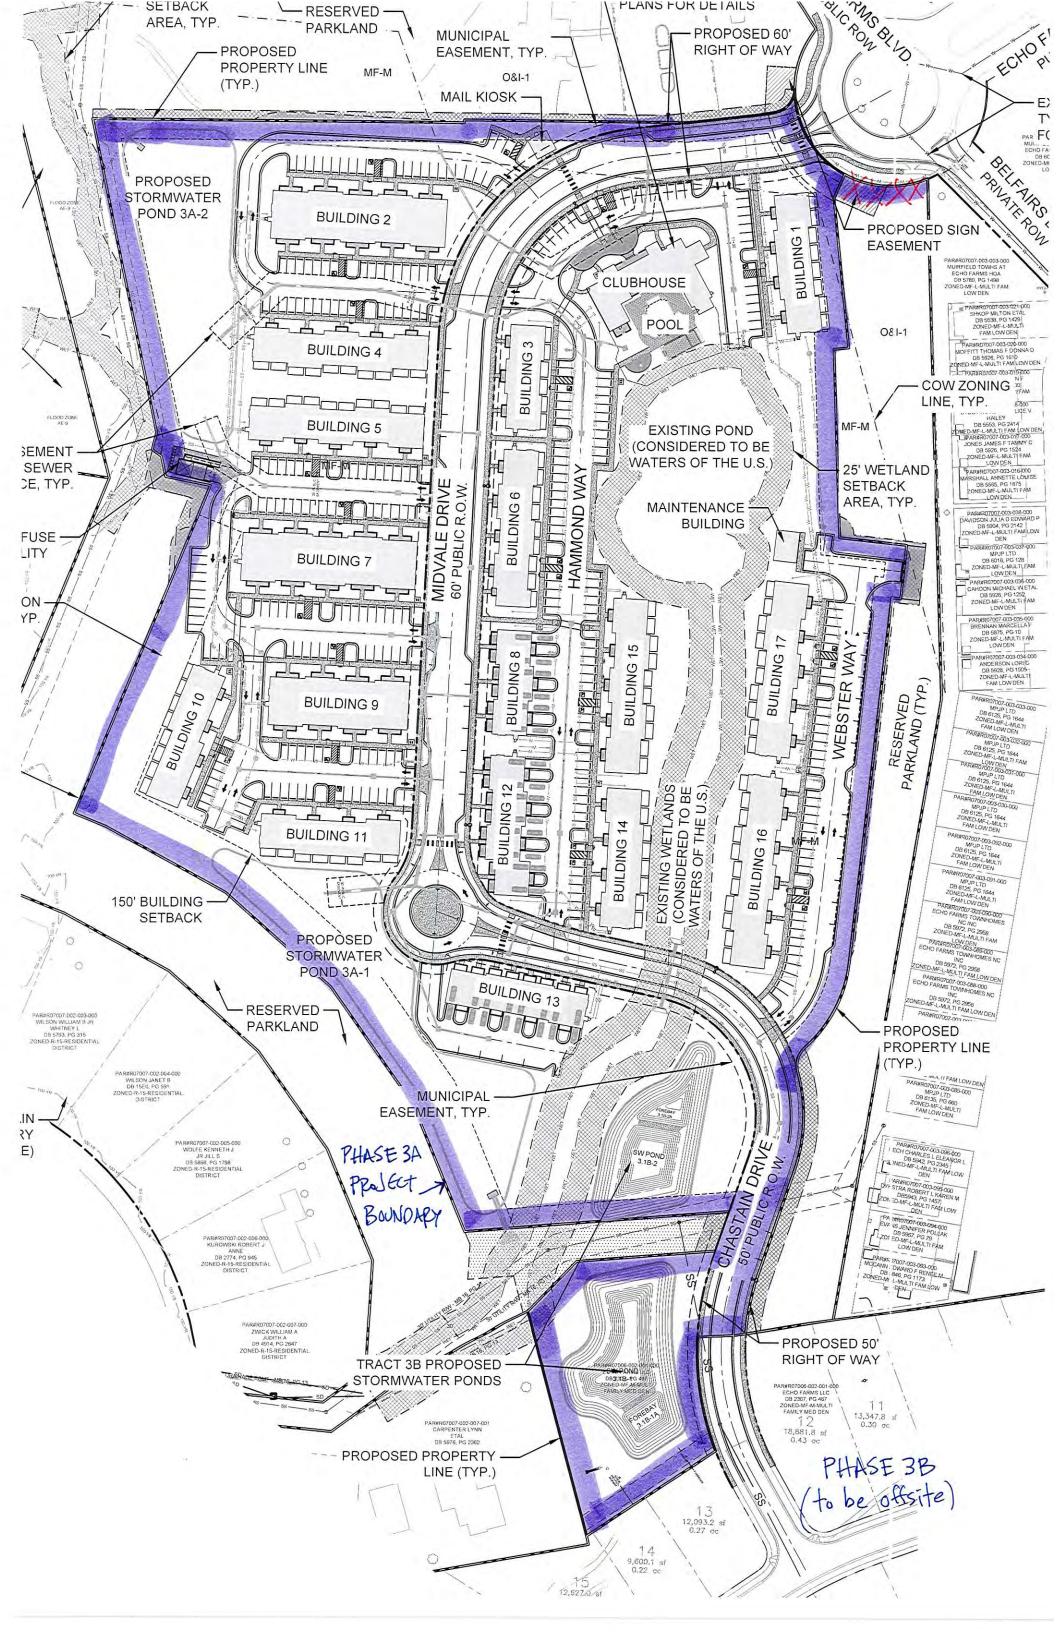


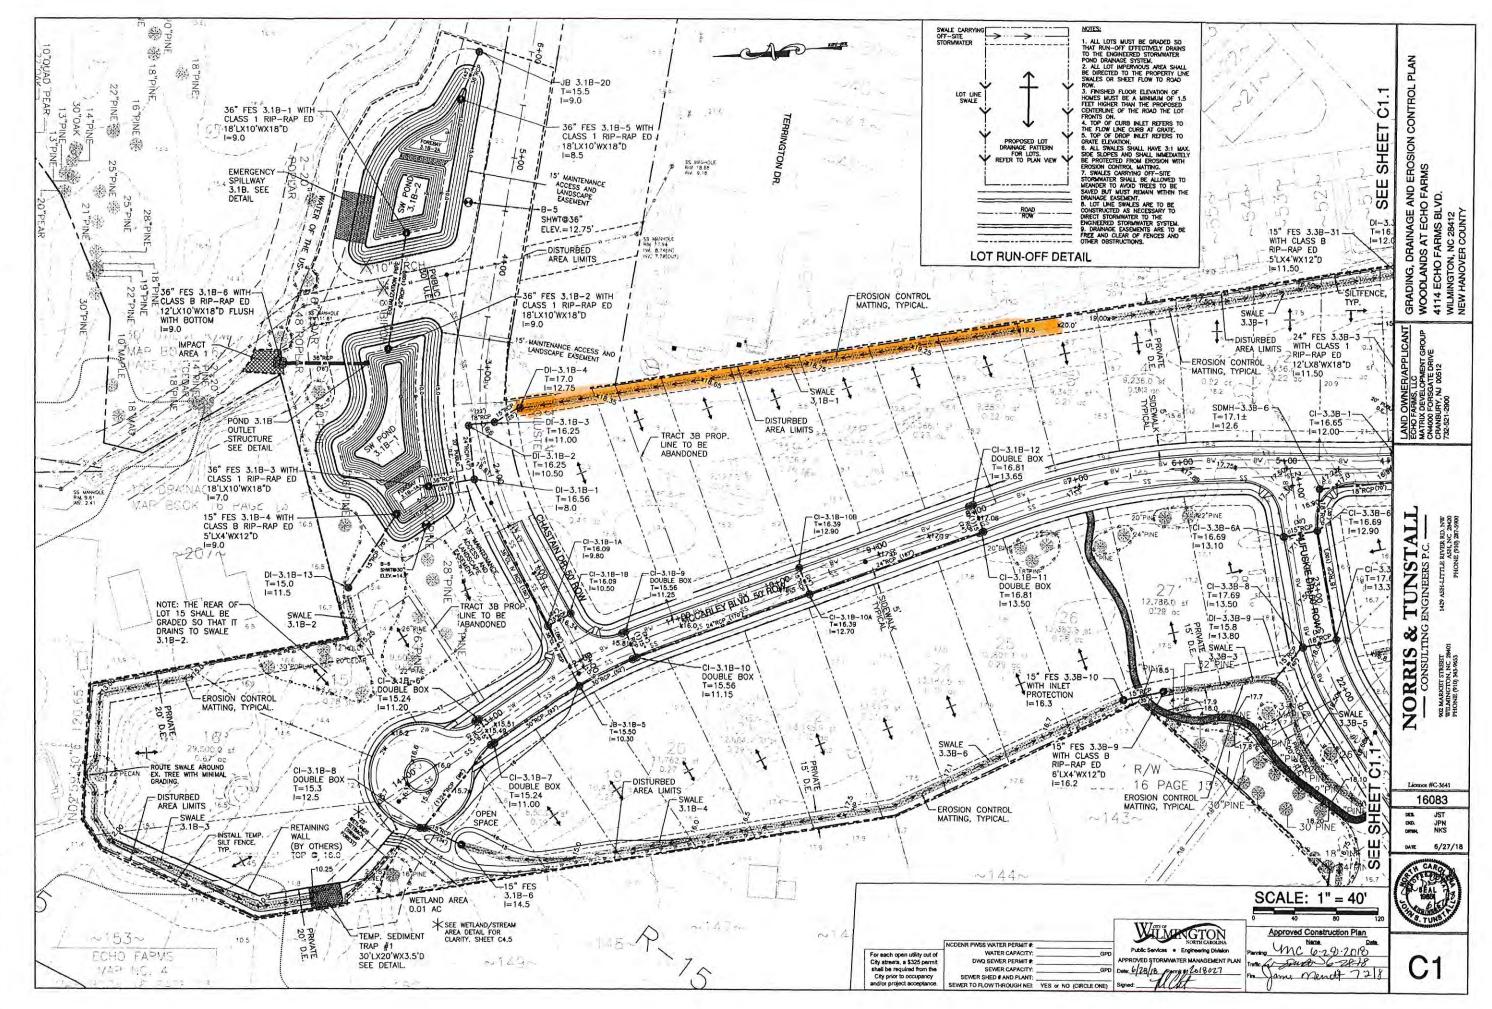

\15083 Woodlands at Ecno Farma\15/83 Plans\3mq\15083.fmaater.34.amq. 5/2}

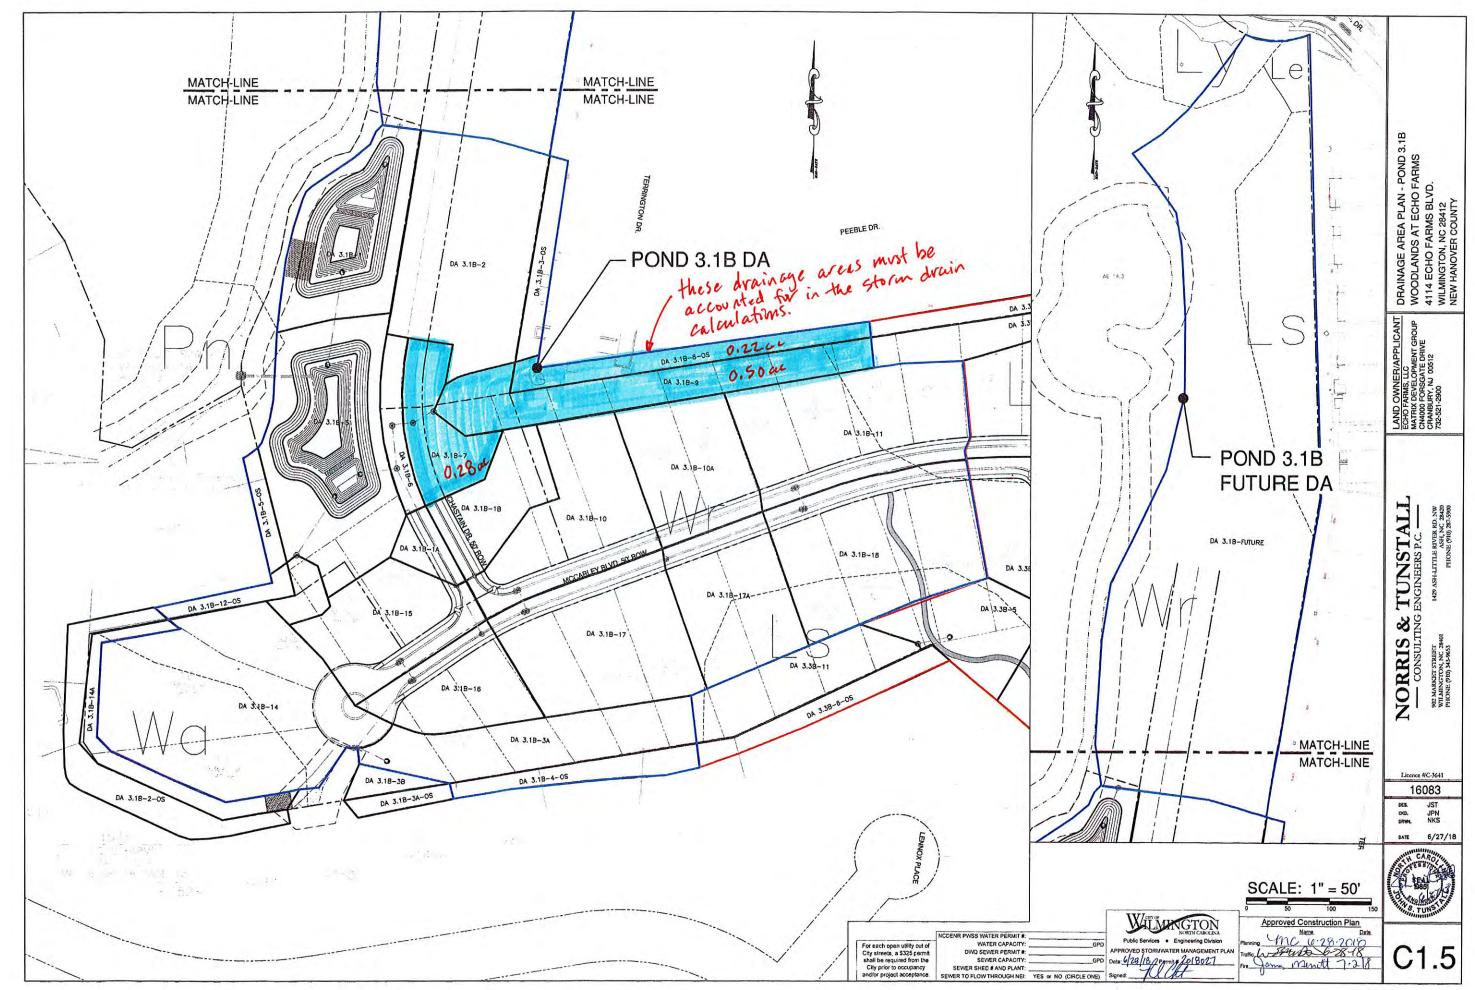

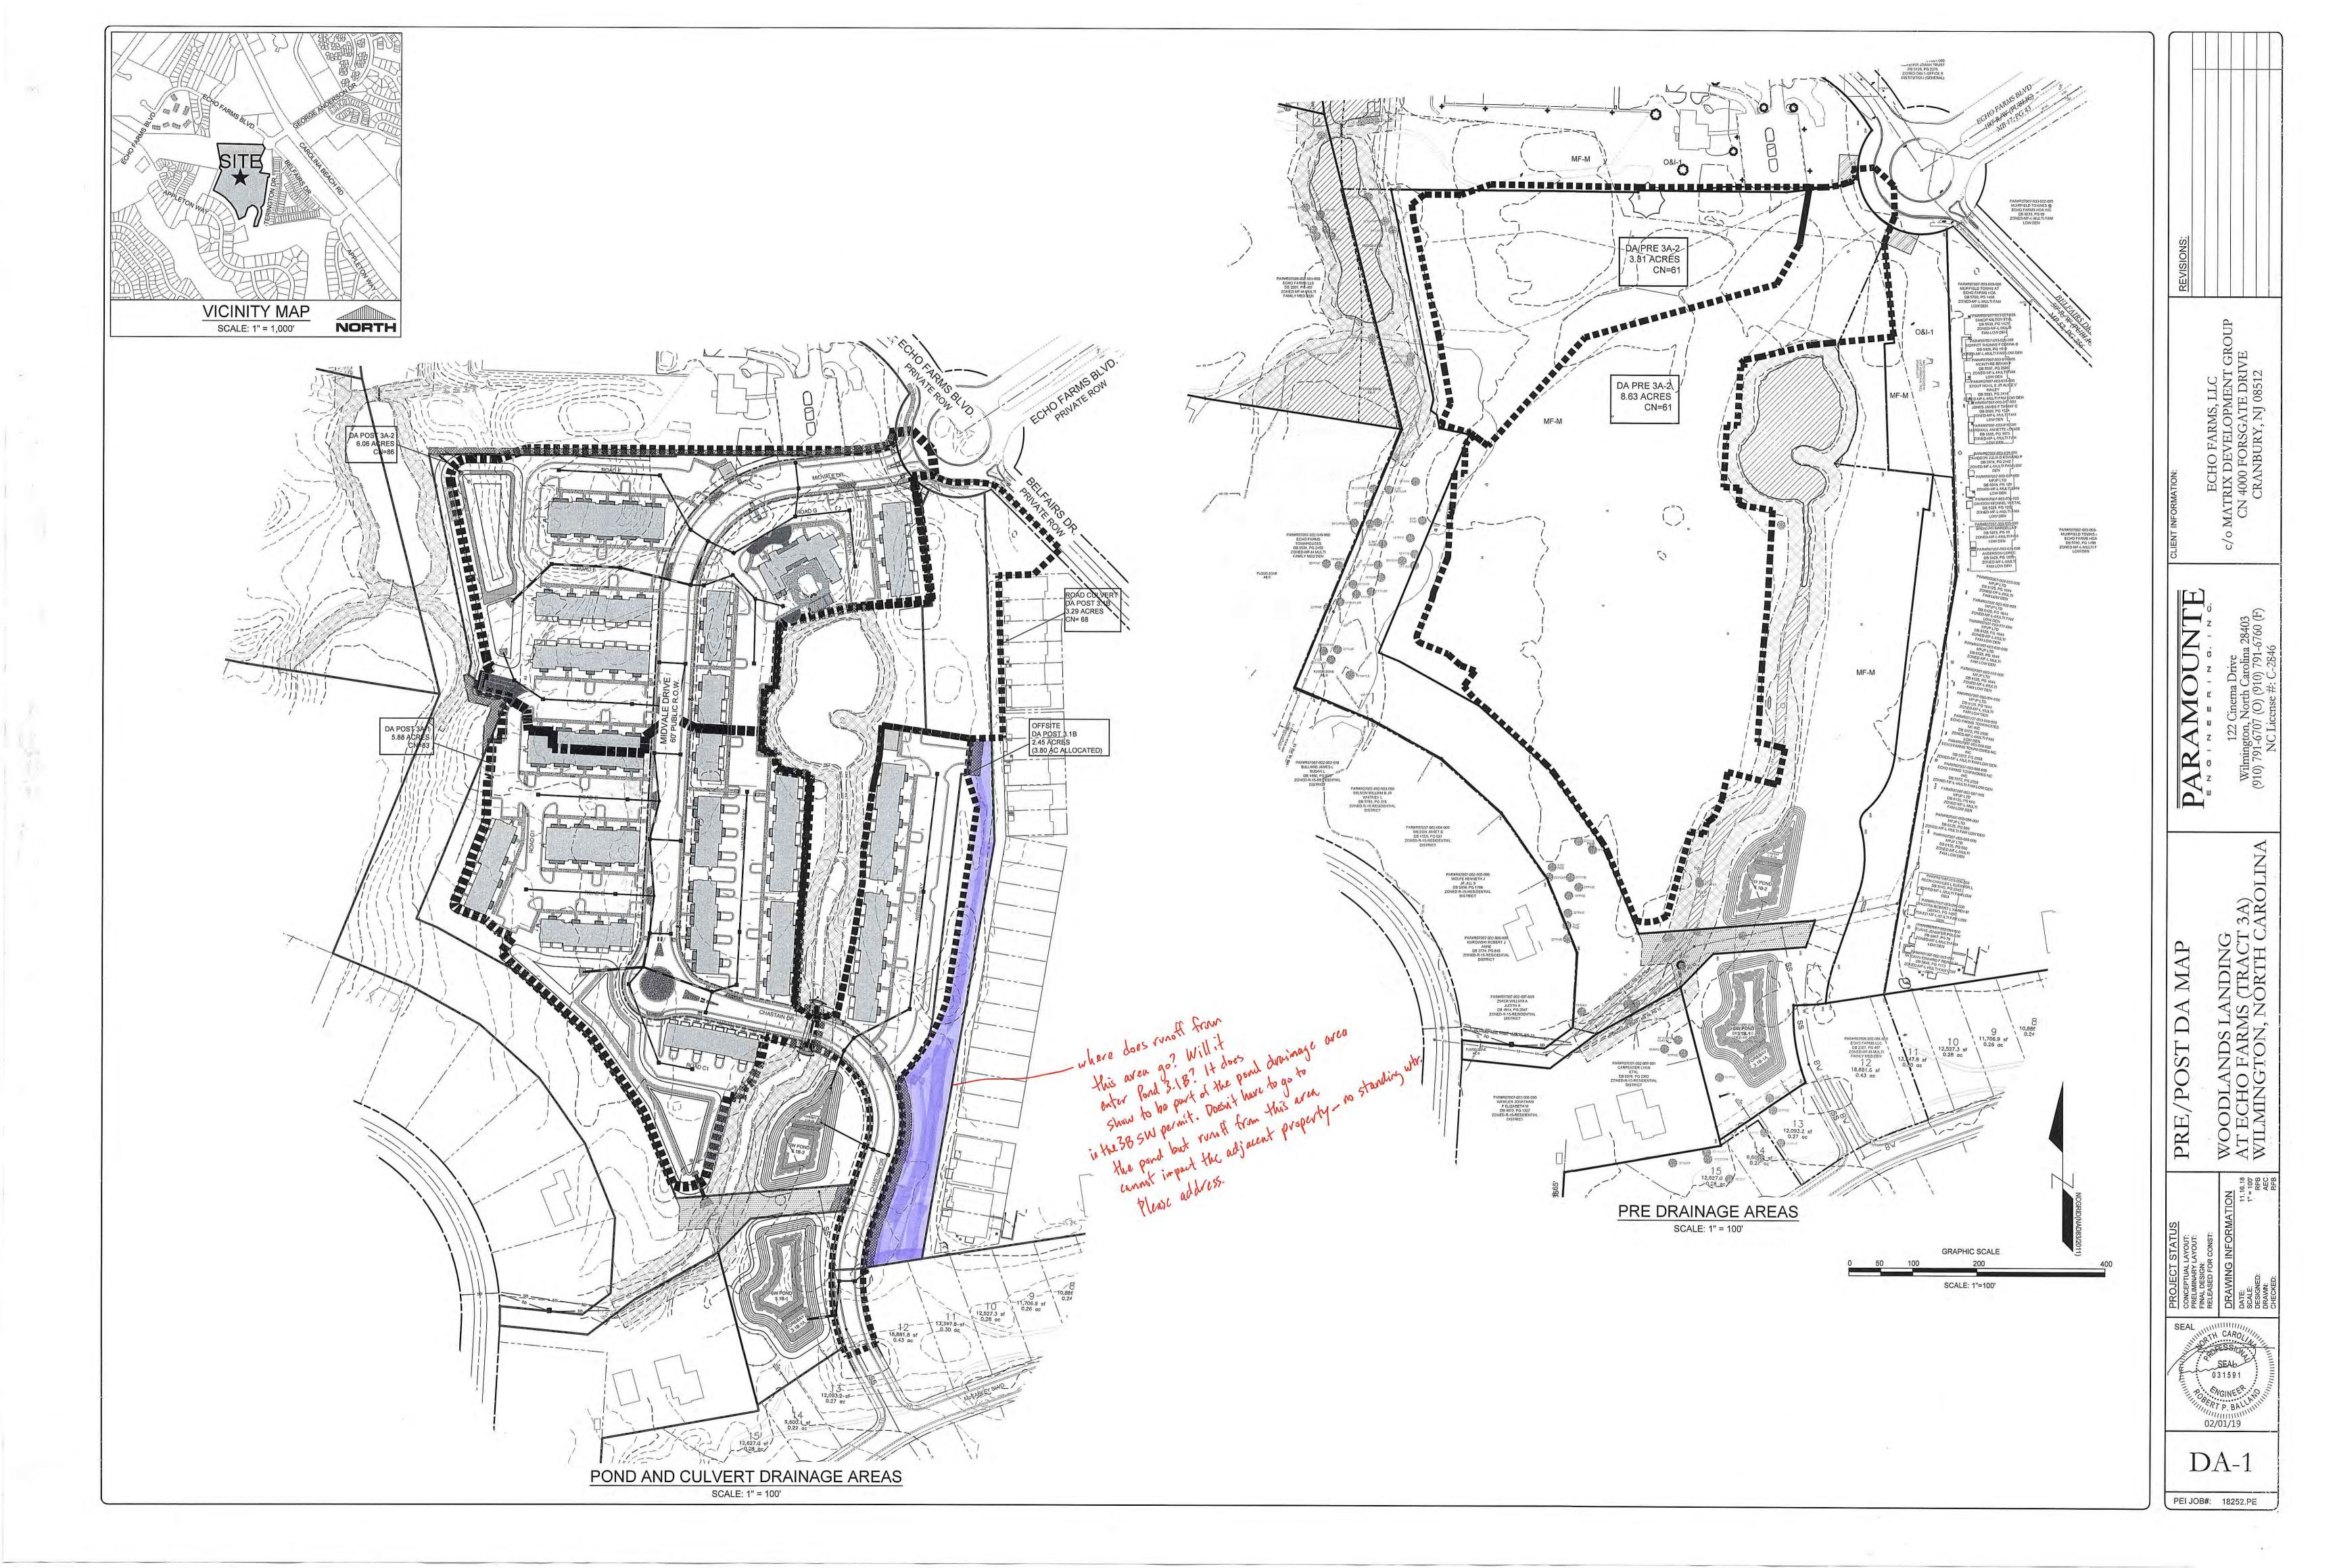

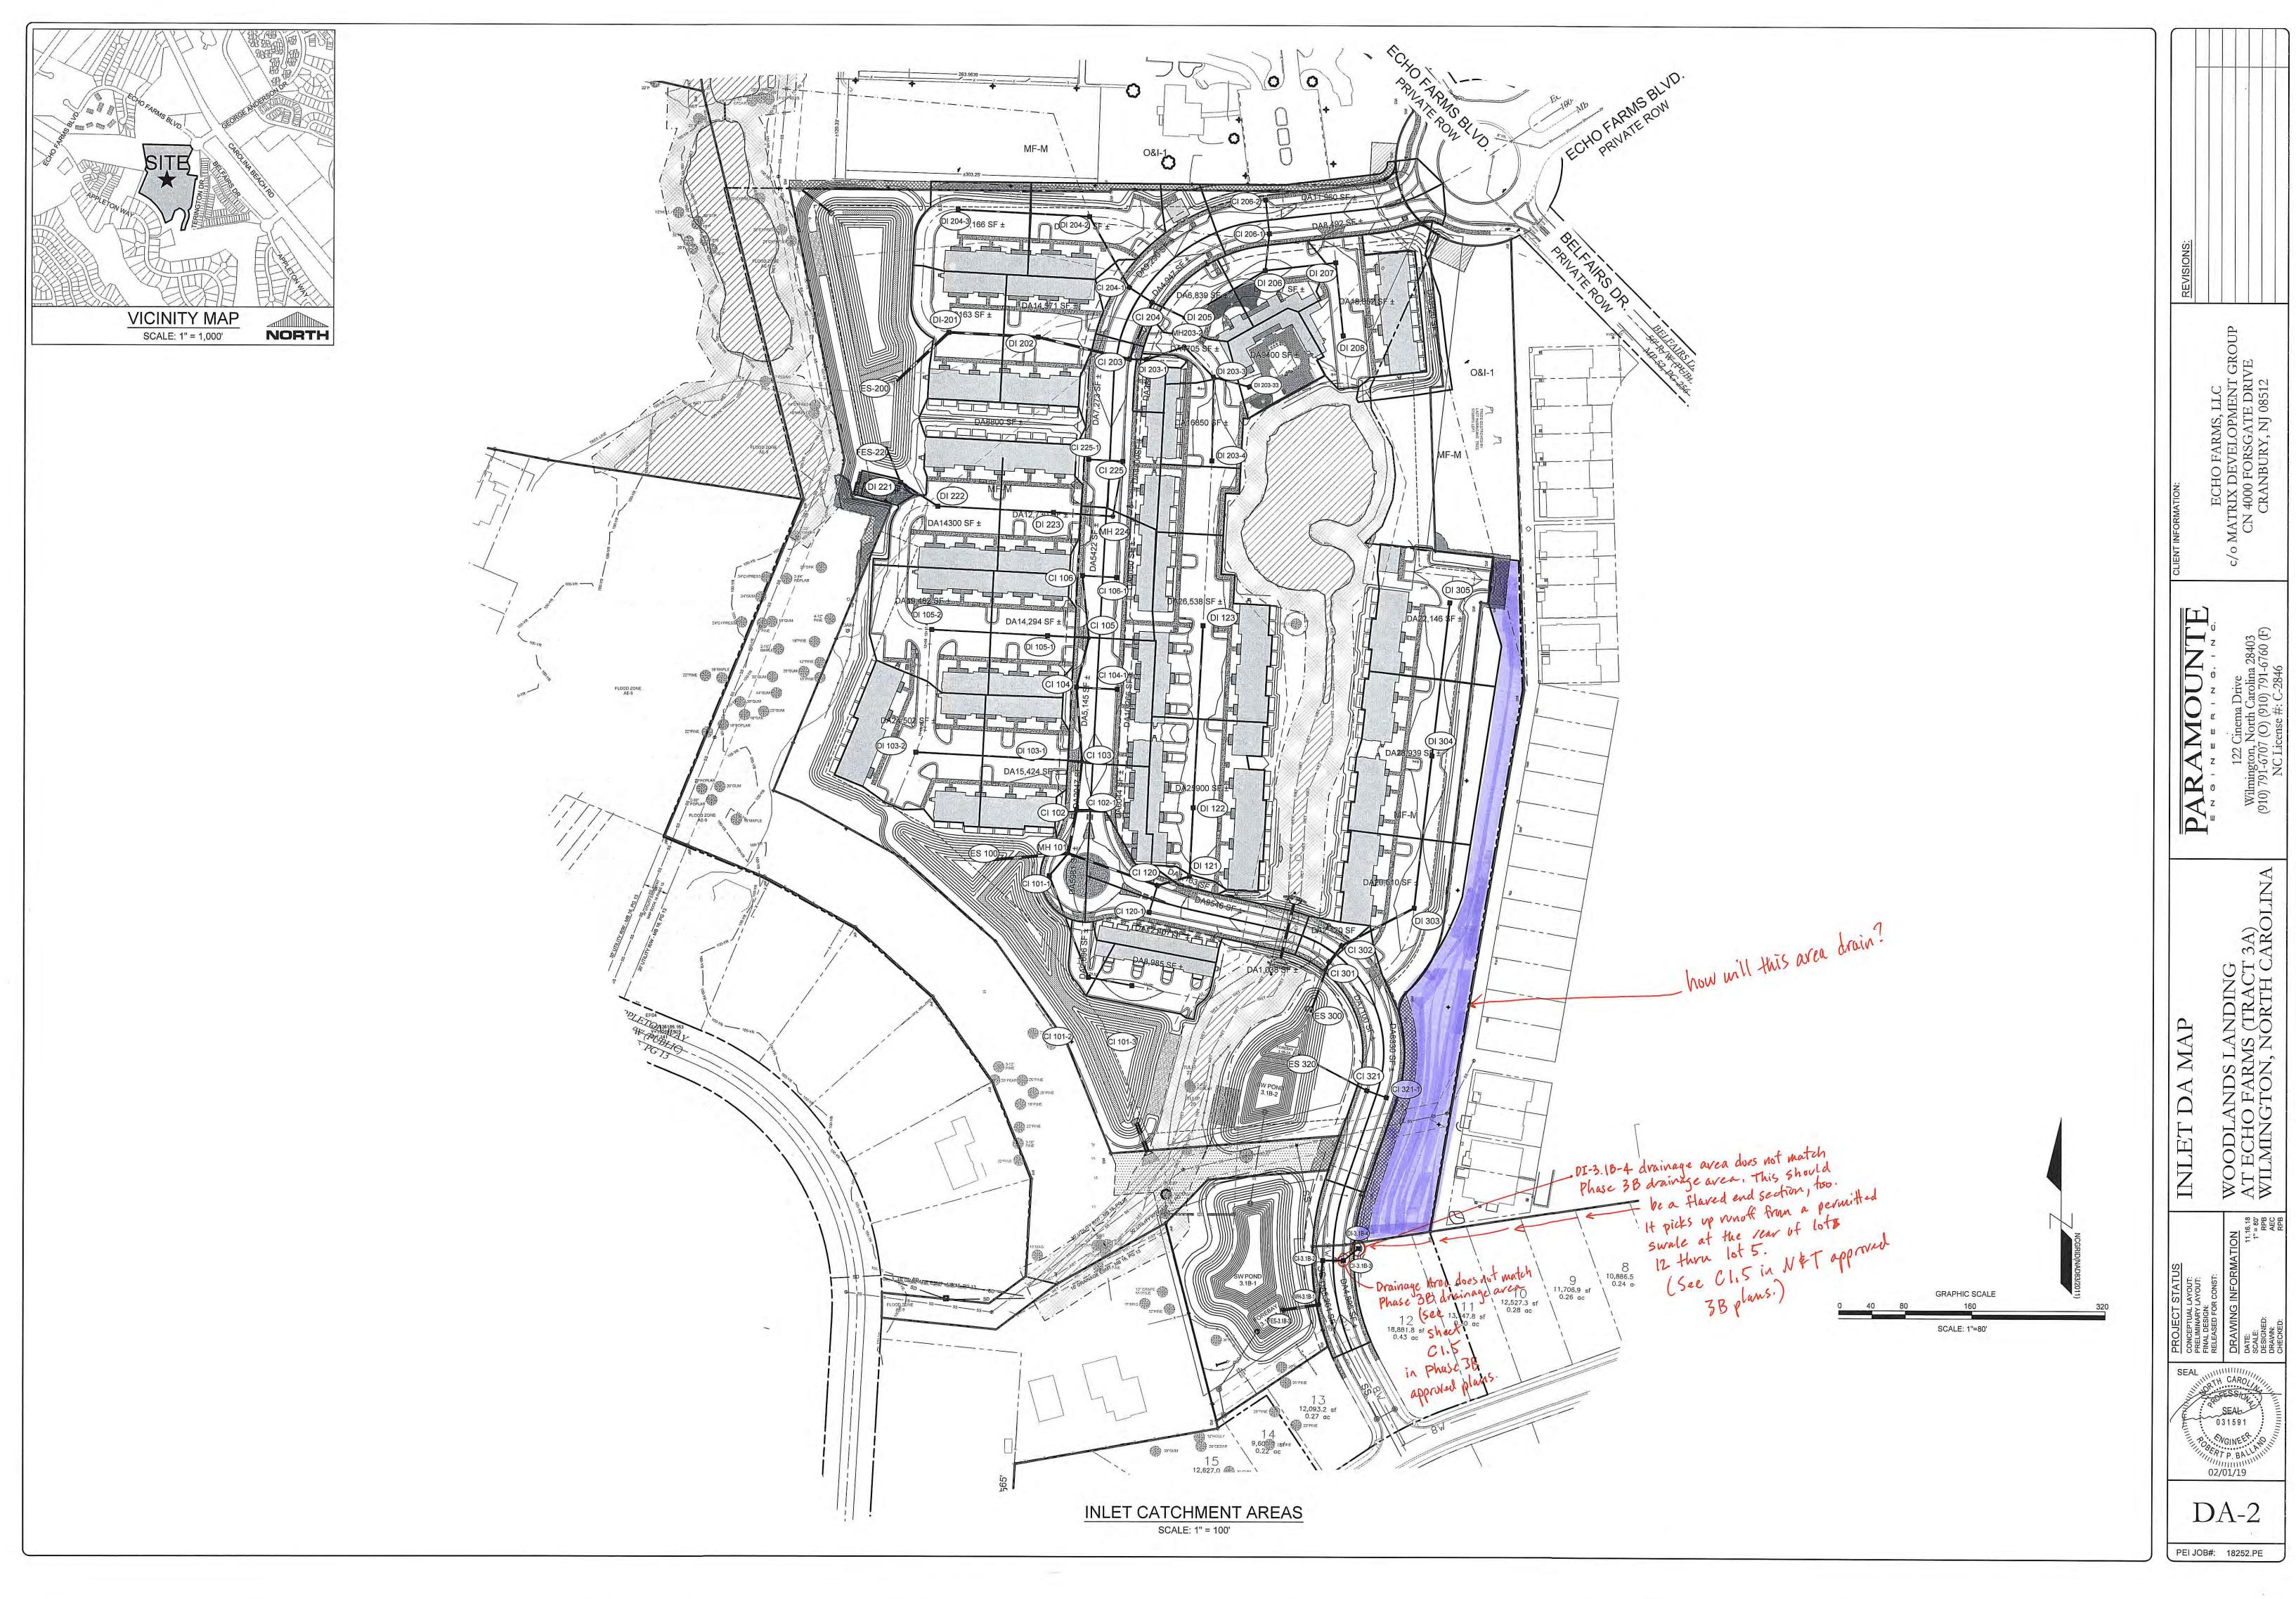

WOODLANDS LANDING AT ECHO FARMS - TRACT 3A 4114 ECHO FARMS BLVD. WILMINGTON, NORTH CAROLINA 28412

NOTICE REQUIRED

ALL EXISTING UNDERGROUND UTILITIES SHALL BE PHYSICALLY LOCATED PRIOR TO THE BEGINNING OF ANY CONSTRUCTION IN THE VICINITY OF SAID UTILITIES.

CONTRACTORS SHALL NOTIFY OPERATORS WHO MAINTAIN UNDERGROUND UTILITY LINES IN THE AREA OF PROPOSED EXCAVATION AT LEAST TWO WORKING DAYS, BUT NOT MORE THAN TEN WORKING DAYS PRIOR TO COMMENCEMENT OF EXCAVATION OR DEMOLITION.

CONTRACTORS SHALL CONTACT OVERHEAD ELECTRIC PROVIDER TO COMPLY WITH FEDERAL OSHA 1910.333 MINIMUM APPROACH DISTANCE TO ENERGIZED POWERLINES AND OSH 29 CFR 1926.1407-1411 MUST BE FOLLOWED.

CONTRACTOR SHALL CONTACT AT&T PRIOR TO ANY DEMOLITION TO ALLOW FOR AT&T TO DISCONNECT COMMUNICATIONS CABLES COMING INTO THE SITE.

CONTACT THESE UTILITIES

CITY OF WILMINGTON PLANNING & DEVELOPMENT ATTN: BRIAN CHAMBERS, PLANNER PH: 910-342-2782

ATTN: ZONING INSPECTIONS PH: 910-254-0900

PIEDMONT NATURAL GAS ATTN: CATHY PLEASANT PH: 910-251-2827

EMERGENCY DIAL 911 POLICE - FIRE - RESCUE ATTN: CITY OF WILMINGTON FIRE & LIFE SAFETY PH: 910-343-0696 CAPE FEAR PUBLIC UTILITY AUTHORITY (WATER & SEWER) ENGINEERING/INSPECTIONS PH: 910-332-6560

OPERATIONS/MAINTENANCE PH: 910-322-6550

DUKE ENERGY DISTRIBUTION CONSTRUCTION SERVICE DEP CSC PH: 1-800-452-2777


TRANSMISSION AGENT BILL WILDER PH: 910-772-4903

AT&T/BELL SOUTH ATTN: STEVE DAYVAULT (BUILDING ENGINEERING) PH: 910-341-0741

ATTN: JAMES BATSON, ENGINEERING PH: 910-341-1621

SPECTRUM GENERAL PH: 800-892-4357 For each open utility cu City streets, a \$325 pe shall be required from City prior to occupan and/or project accepta

DESIGN DOCUMENTS FEBRUARY 2019

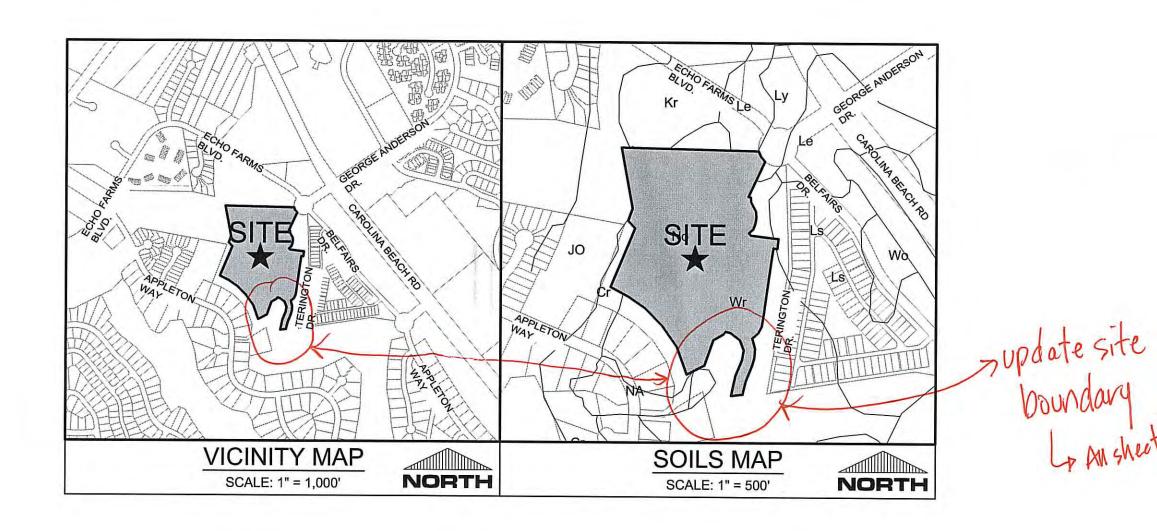

ut of				Approved Construction Plan		
ermit the cy nce.	WATER CAPACITY: DWQ SEWER PERMIT #: SEWER CAPACITY: SEWER SHED # AND PLANT: SEWER TO FLOW THROUGH NEI:	GPD GPD YES or NO (CIRCLE ONE)	Public Services • Engineering Division APPROVED STORMWATER MANAGEMENT PLAN Date:	Planning Traffic Fire	<u>Name</u>	<u>Date</u>
			Signed:			

OWNER:

ECHO FARMS, LLC C/O MATRIX DEVELOPMENT GROUP 4000CN FORSGATE DRIVE CRANBURY, NEW JERSEY 08512 (732) 521-2900

DEVELOPER:

GHK CAPE FEAR DEVELOPMENT, LLC 1051 MILITARY CUTOFF ROAD, SUITE 200 WILMINGTON, NC 28405 (910) 344-1000

ENGINEER (CIVIL):

PARAMOUNTE ENGINEERING, INC. 122 CINEMA DRIVE WILMINGTON, NORTH CAROLINA 28403 ATTN: ROB BALLAND, P.E. (910) 791-6707



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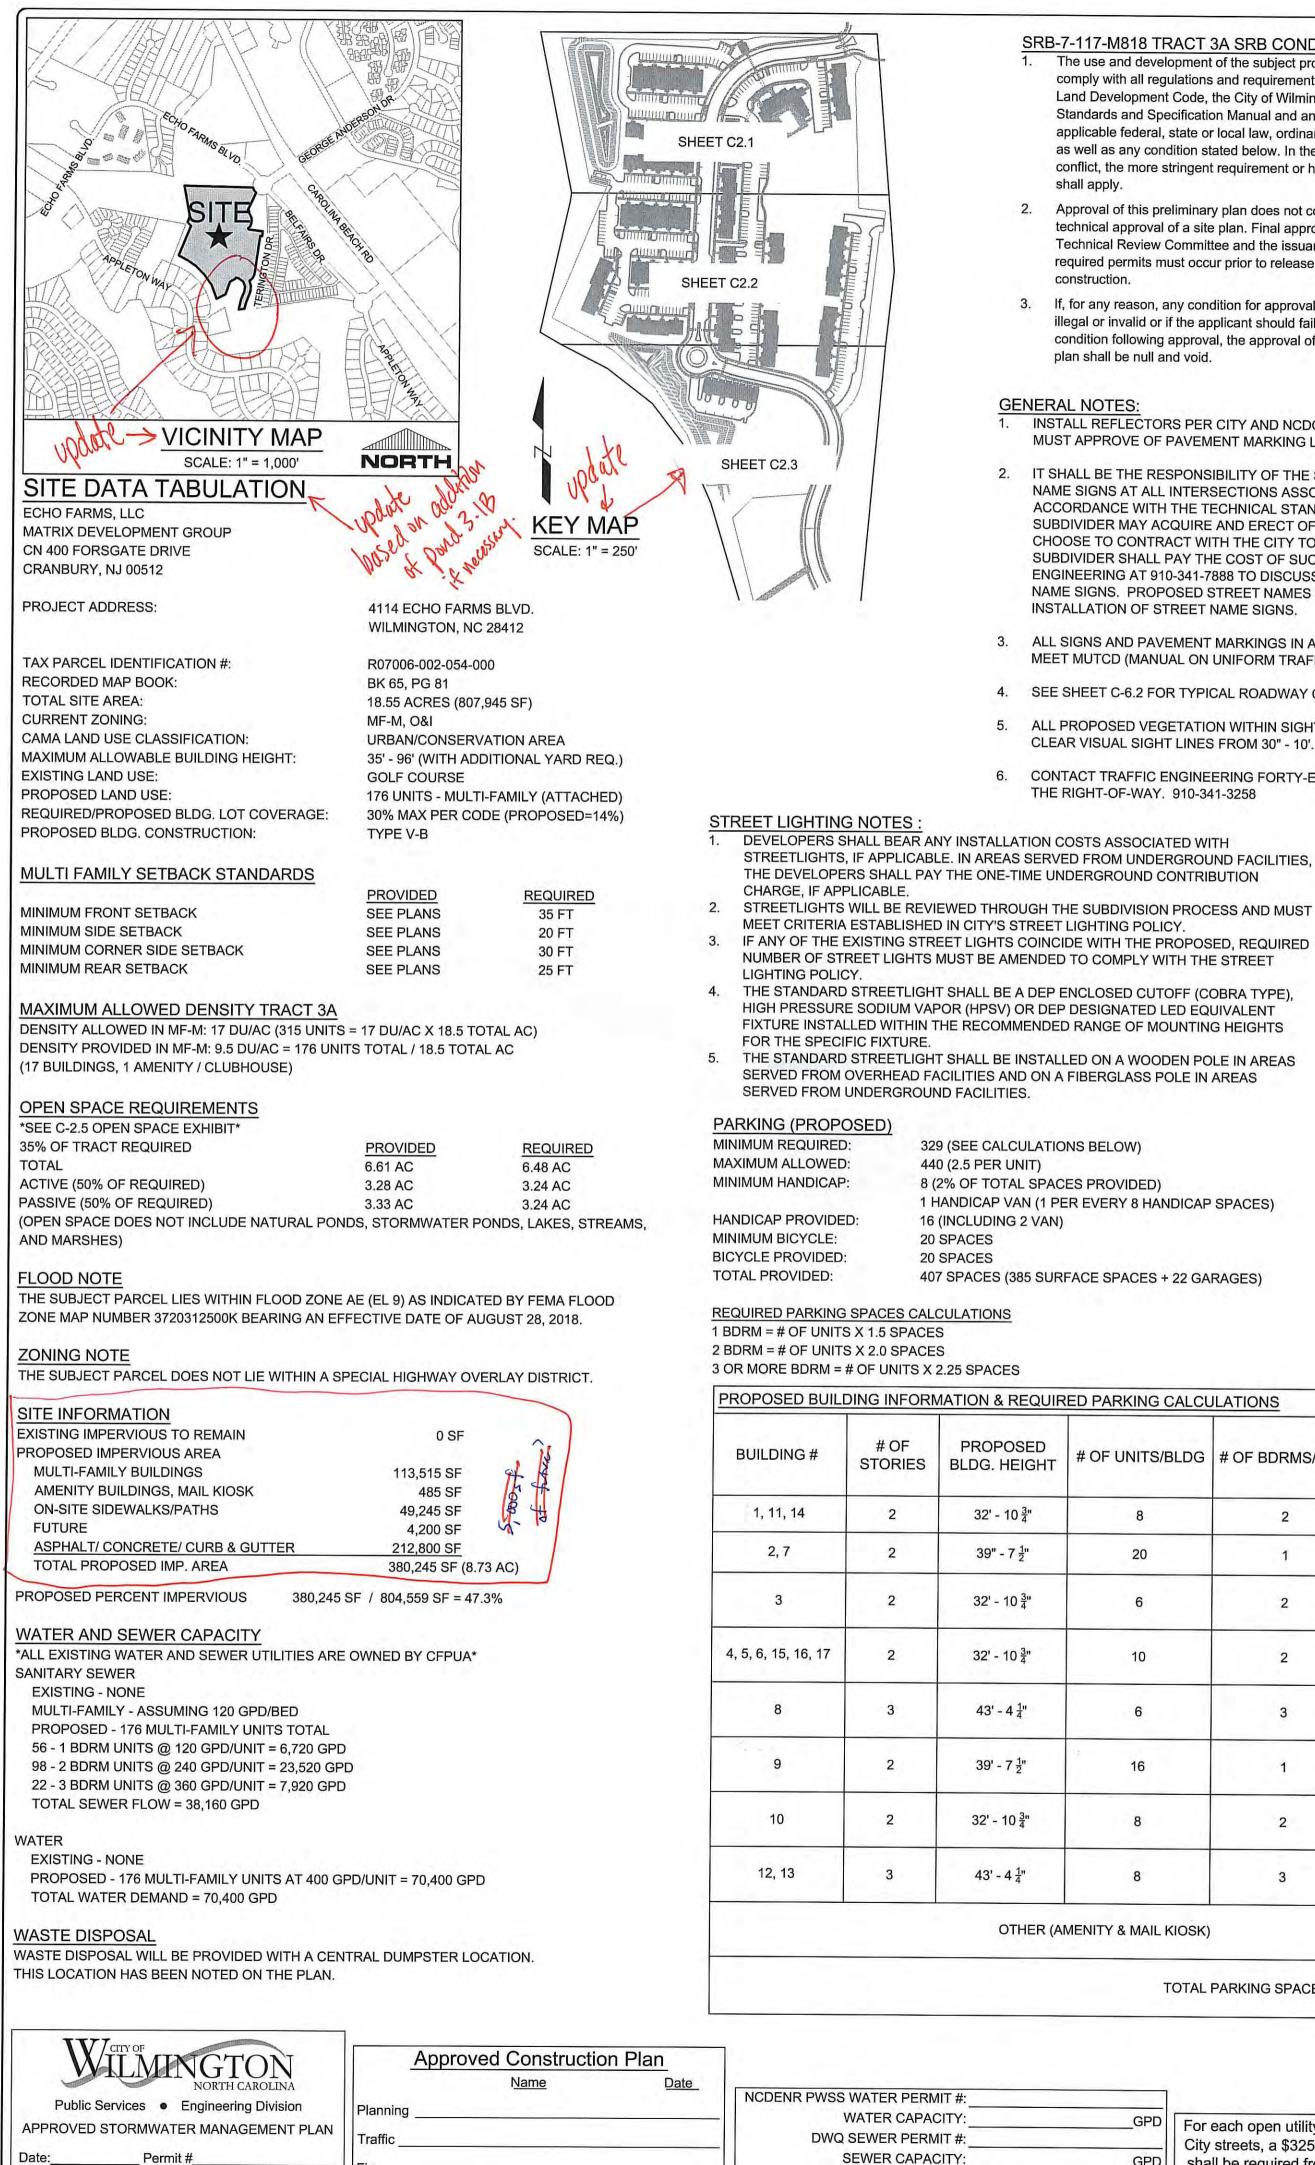
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	SHEET INDEX
SHEET NUMBER	SHEET TITLE
C-0.0	COVER SHEET
C-1.0	GENERAL NOTES
C-2.0-2.3	SITE PLANS
C-2.4	SITE INVENTORY PLAN
C-2.5	OPEN SPACE EXHIBIT
C-3.0	EROSION CONTROL PLAN, PH. I
C-4.0	OVERALL DRAINAGE PLAN
C-4.1 - C-4.3	GRADING & DRAINAGE PLANS
C-5.0 - C-5.2	UTILITY PLAN & PROFILES
C-6.0 - C-6.2	ROADWAY PROFILES
C-7.0-C-7.3, C-7.5	DETAILS





ENGINEERING, INC. 122 Cinema Drive Wilmington, North Carolina 28403 (910) 791-6707 (O) (910) 791-6760 (F) NC License #: C-2846 PROJECT # 18252.PE SEAL SEAL O31591 SEAL NGINEER O2/01/19



SEWER SHED # AND PLANT:

SEWER TO FLOW THROUGH NEI: YES or NO (CIRCLE ONE)

Signed

SRB-7-117-M818 TRACT 3A SRB CONDITIONS: The use and development of the subject property shall comply with all regulations and requirement imposed by the Land Development Code, the City of Wilmington Technical Standards and Specification Manual and any other applicable federal, state or local law, ordinance or regulation, as well as any condition stated below. In the event of a conflict, the more stringent requirement or higher standard

Approval of this preliminary plan does not constitute technical approval of a site plan. Final approval by the Technical Review Committee and the issuance of all required permits must occur prior to release of the project for construction.

3. If, for any reason, any condition for approval is found to be illegal or invalid or if the applicant should fail to accept any condition following approval, the approval of the preliminary plan shall be null and void.

- 4 accordance with the approved preliminary plan as submitted and approved.
- Utilities shall be placed in appropriate locations relative to the public rights-of-way and co-location of water and sewer utilities with the required street trees (per the City TSSM) shall be pursued by the applicant and designer.
- 6. A tree preservation plan and tree removal permit shall be required for this project and city staff shall issue these based on acceptable limits of clearing and tree preservation.
- All existing protected trees not located within the building
- Trees designated to be preserved shall be properly protected during construction and tree protection fencing shall be noted on the construction plans. Tree clearing will be limited to essential site improvements within the project limits as shown on the approved site plan.
- the LDC shall be shown and labeled on the Preliminary Plan.
- easements shall be added as necessary to the Preliminary Plan.
- for signature within thirty (30) calendar days of SRB approval.

INSTALL REFLECTORS PER CITY AND NCDOT STANDARDS. TRAFFIC ENGINEERING MUST APPROVE OF PAVEMENT MARKING LAYOUT PRIOR TO ACTUAL STRIPING.

2. IT SHALL BE THE RESPONSIBILITY OF THE SUBDIVIDER TO ERECT OFFICIAL STREET NAME SIGNS AT ALL INTERSECTIONS ASSOCIATED WITH THE SUBDIVISION IN ACCORDANCE WITH THE TECHNICAL STANDARDS AND SPECIFICATIONS MANUAL. THE SUBDIVIDER MAY ACQUIRE AND ERECT OFFICIAL STREET NAME SIGNS OR MAY CHOOSE TO CONTRACT WITH THE CITY TO INSTALL THE STREET SIGNS AND THE SUBDIVIDER SHALL PAY THE COST OF SUCH INSTALLATION. CONTACT TRAFFIC ENGINEERING AT 910-341-7888 TO DISCUSS INSTALLATION OF TRAFFIC AND STREET NAME SIGNS. PROPOSED STREET NAMES MUST BE APPROVED PRIOR TO INSTALLATION OF STREET NAME SIGNS.

ALL SIGNS AND PAVEMENT MARKINGS IN AREAS OPEN TO PUBLIC TRAFFIC ARE TO MEET MUTCD (MANUAL ON UNIFORM TRAFFIC CONTROL DEVICES) STANDARDS.

SEE SHEET C-6.2 FOR TYPICAL ROADWAY CROSS SECTIONS.


5. ALL PROPOSED VEGETATION WITHIN SIGHT TRIANGLES SHALL NOT INTERFERE WITH CLEAR VISUAL SIGHT LINES FROM 30" - 10'.

CONTACT TRAFFIC ENGINEERING FORTY-EIGHT HOURS PRIOR TO ANY EXCAVATION IN THE RIGHT-OF-WAY. 910-341-3258

1 HANDICAP VAN (1 PER EVERY 8 HANDICAP SPACES)


407 SPACES (385 SURFACE SPACES + 22 GARAGES)


¢ OF UNITS/BLDG	# OF BDRMS/UNIT	# OF REQ'D PARKING SPACES/BLDG (MIN.)	# OF PROVIDED PARKING SPACES/BLDG	
8	2	16	16, 20, & 20	
20	1	30	39 & 38	
6	2	12	15	
10	2	20	25, 20, 20, 20, 28, & 28	
6	3	13.5	16	
16	1	24	25	
8	2	16	16	
8	3	18	20 & 20	
NITY & MAIL KIOSK)			18 & 3	
TOTAL	330	407		

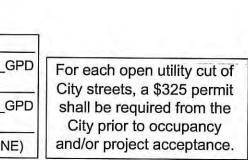





Call before you dig.

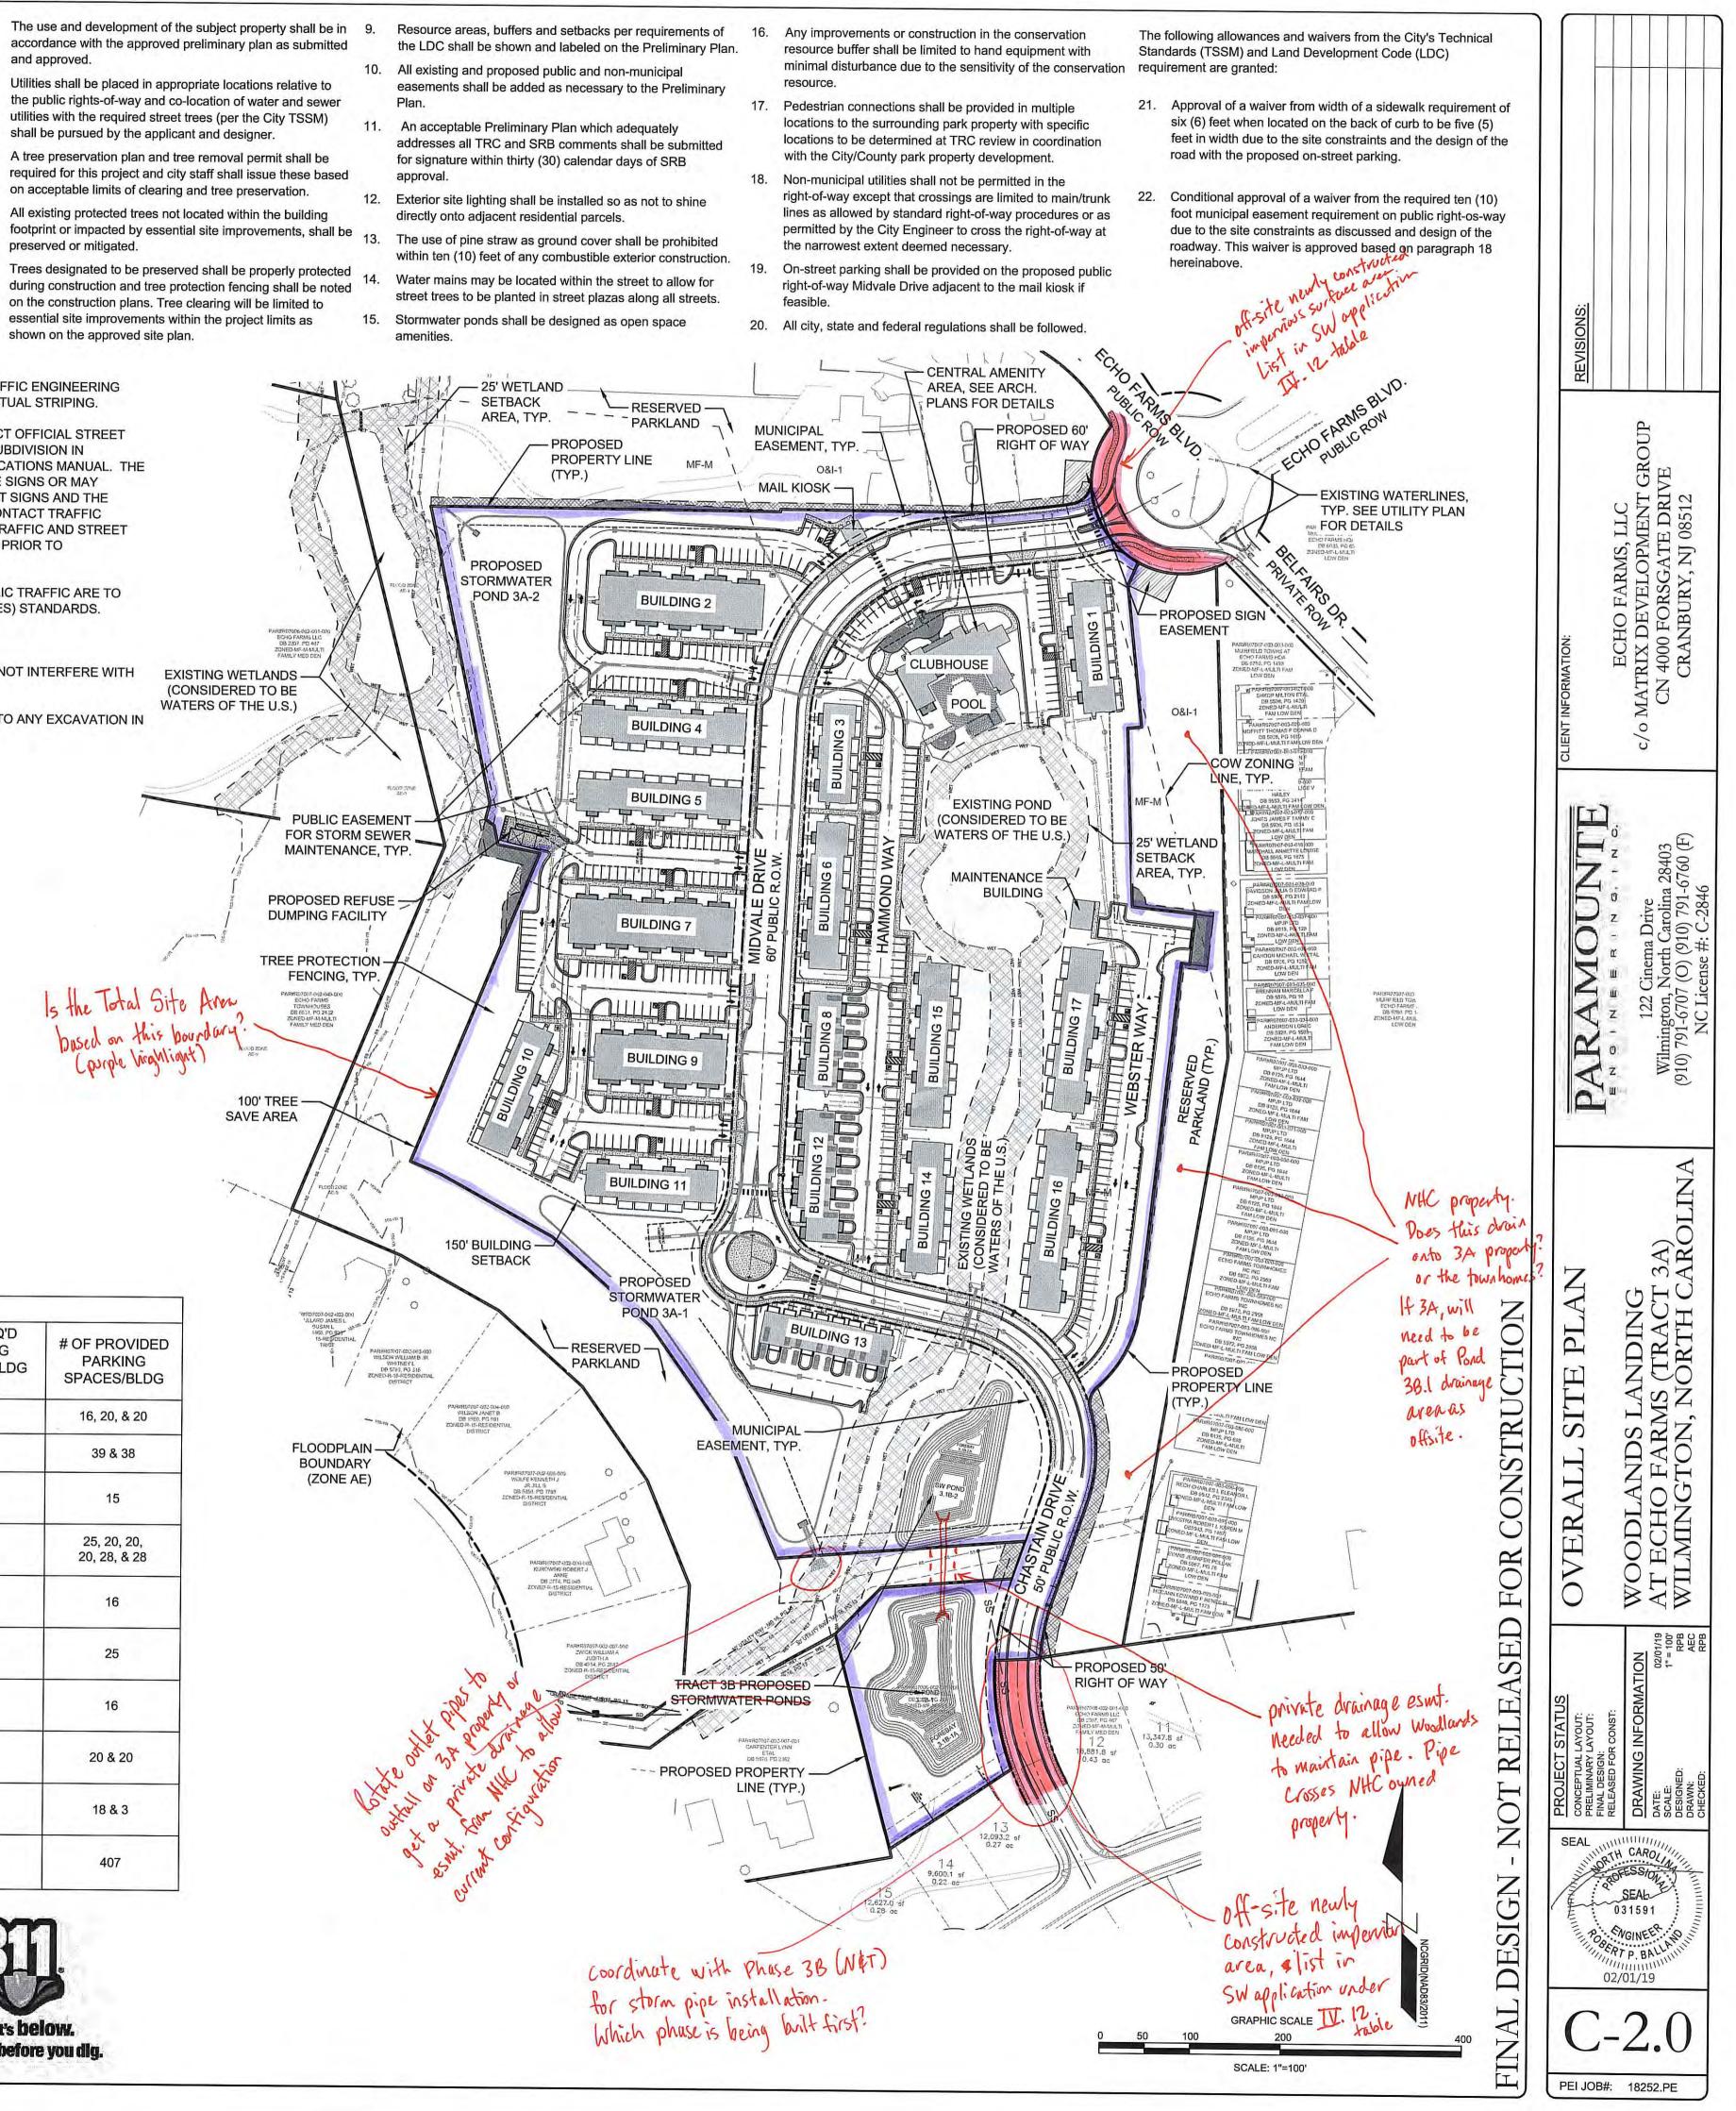


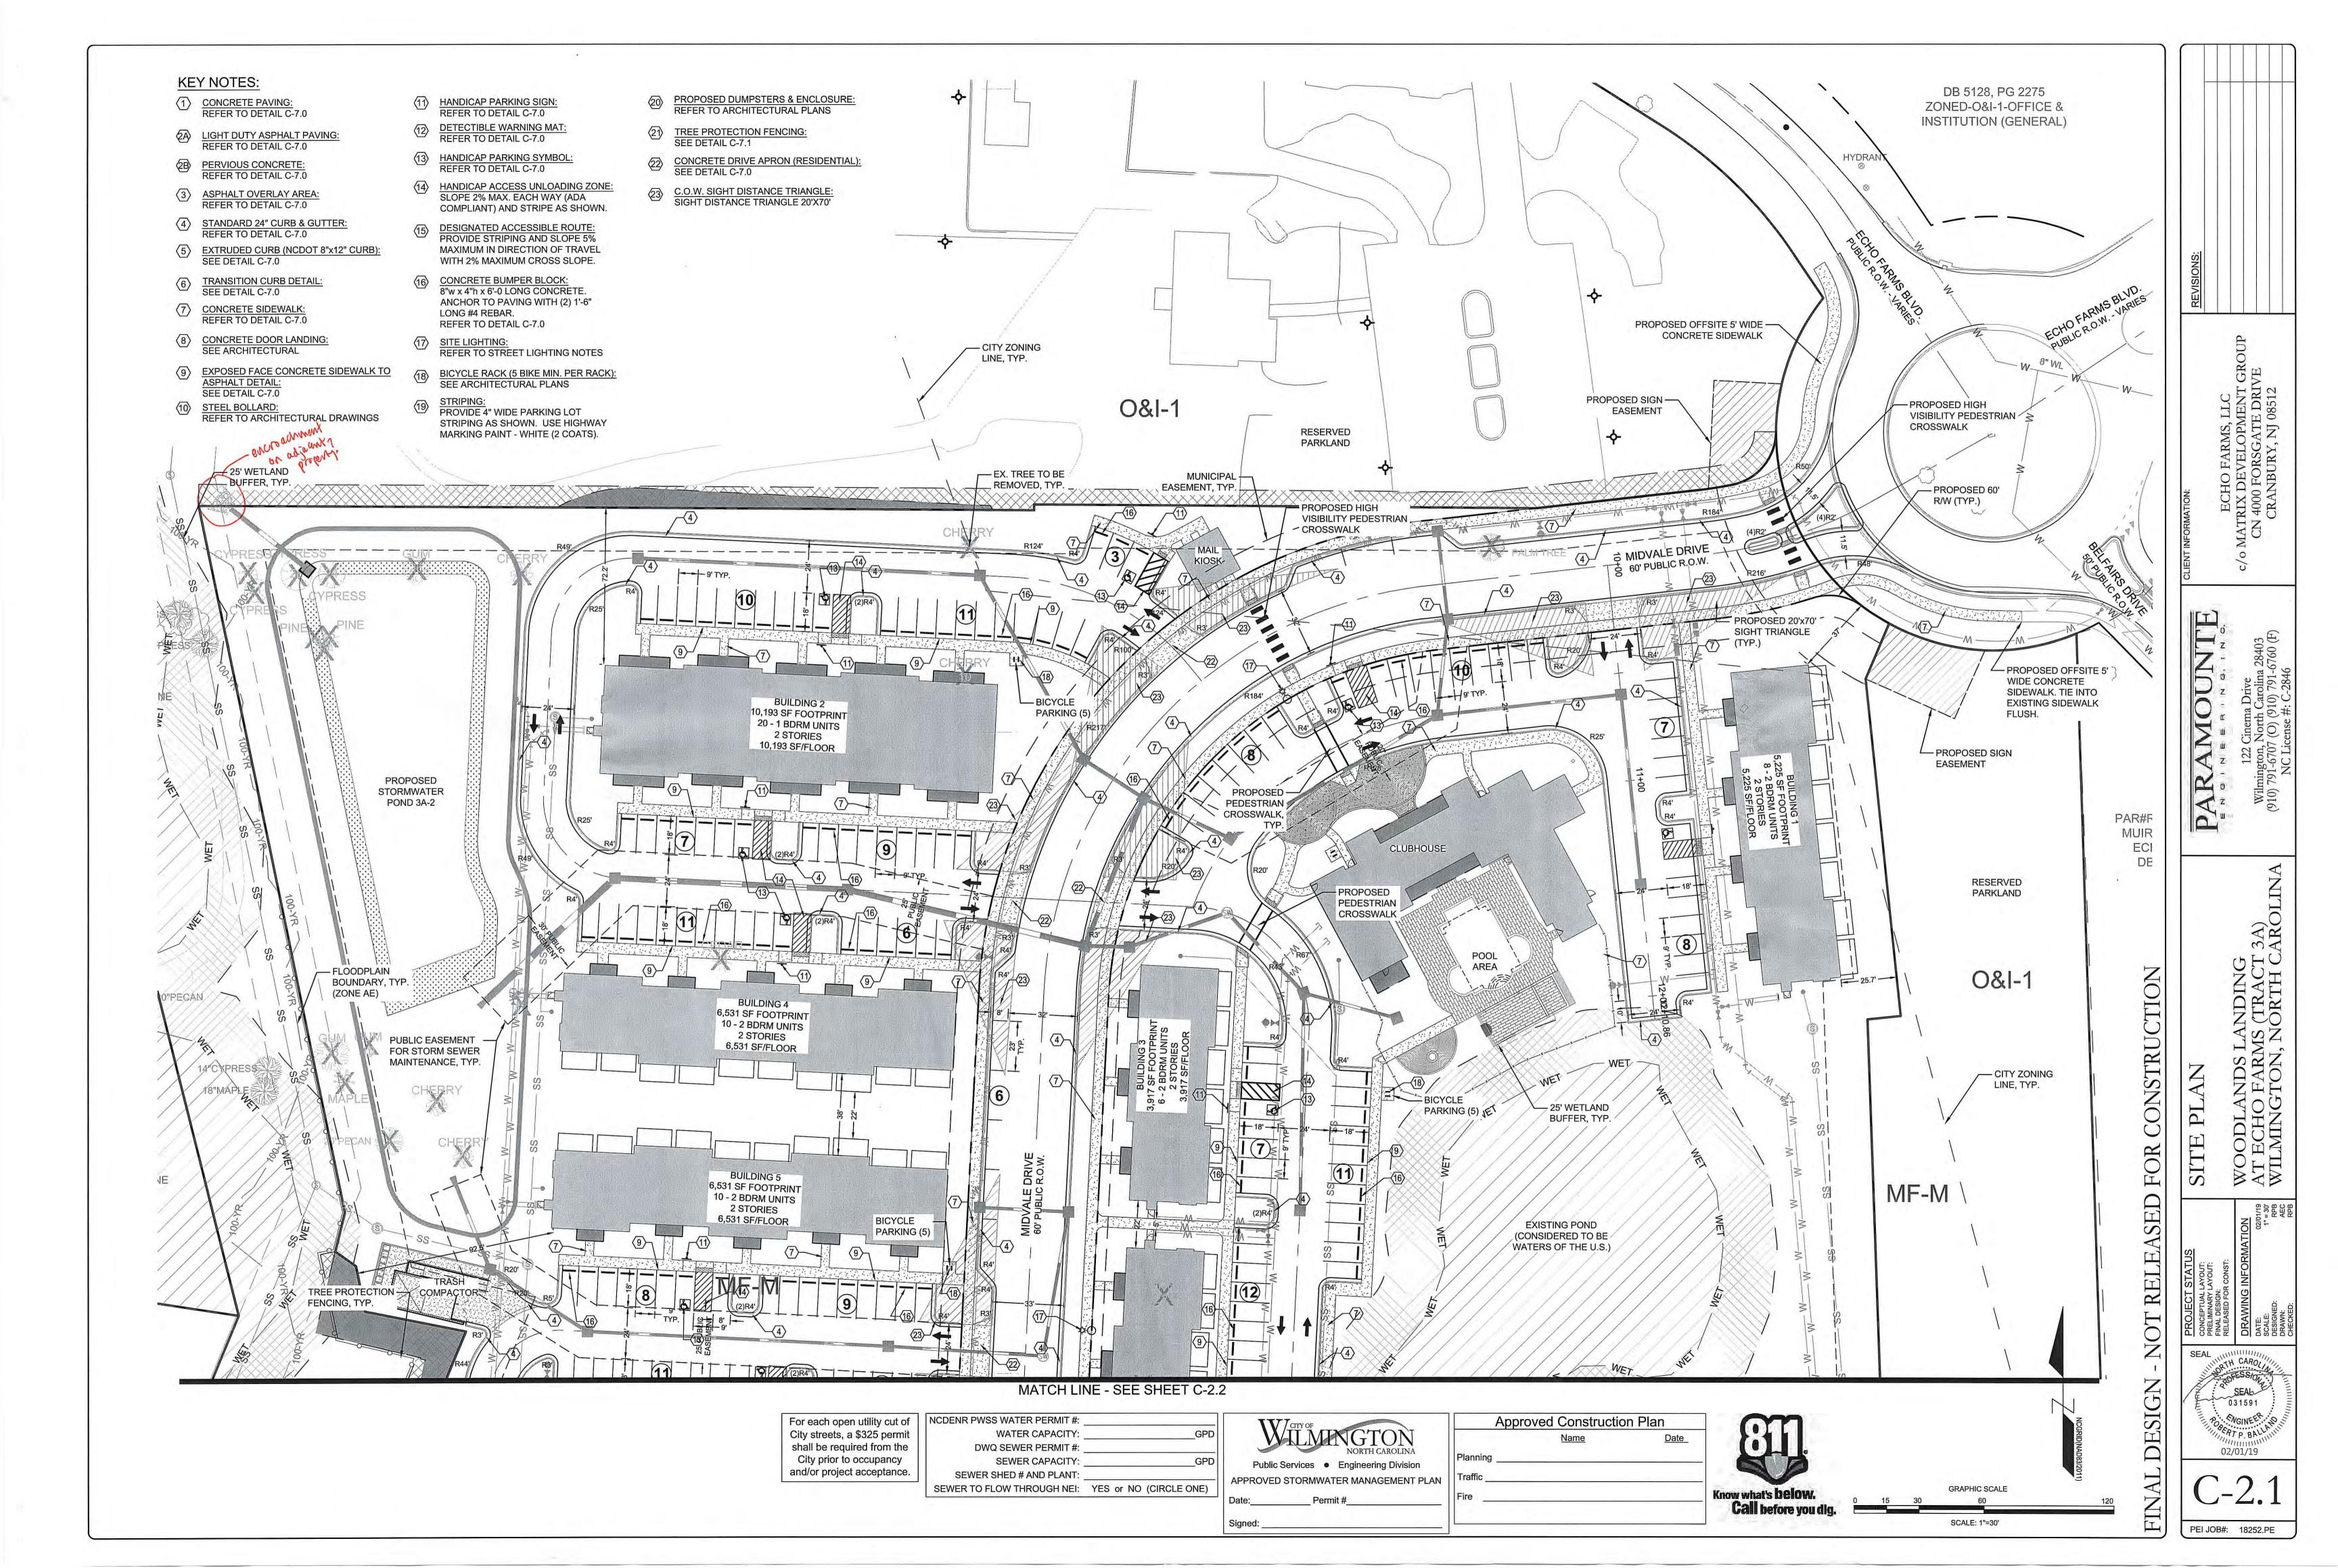


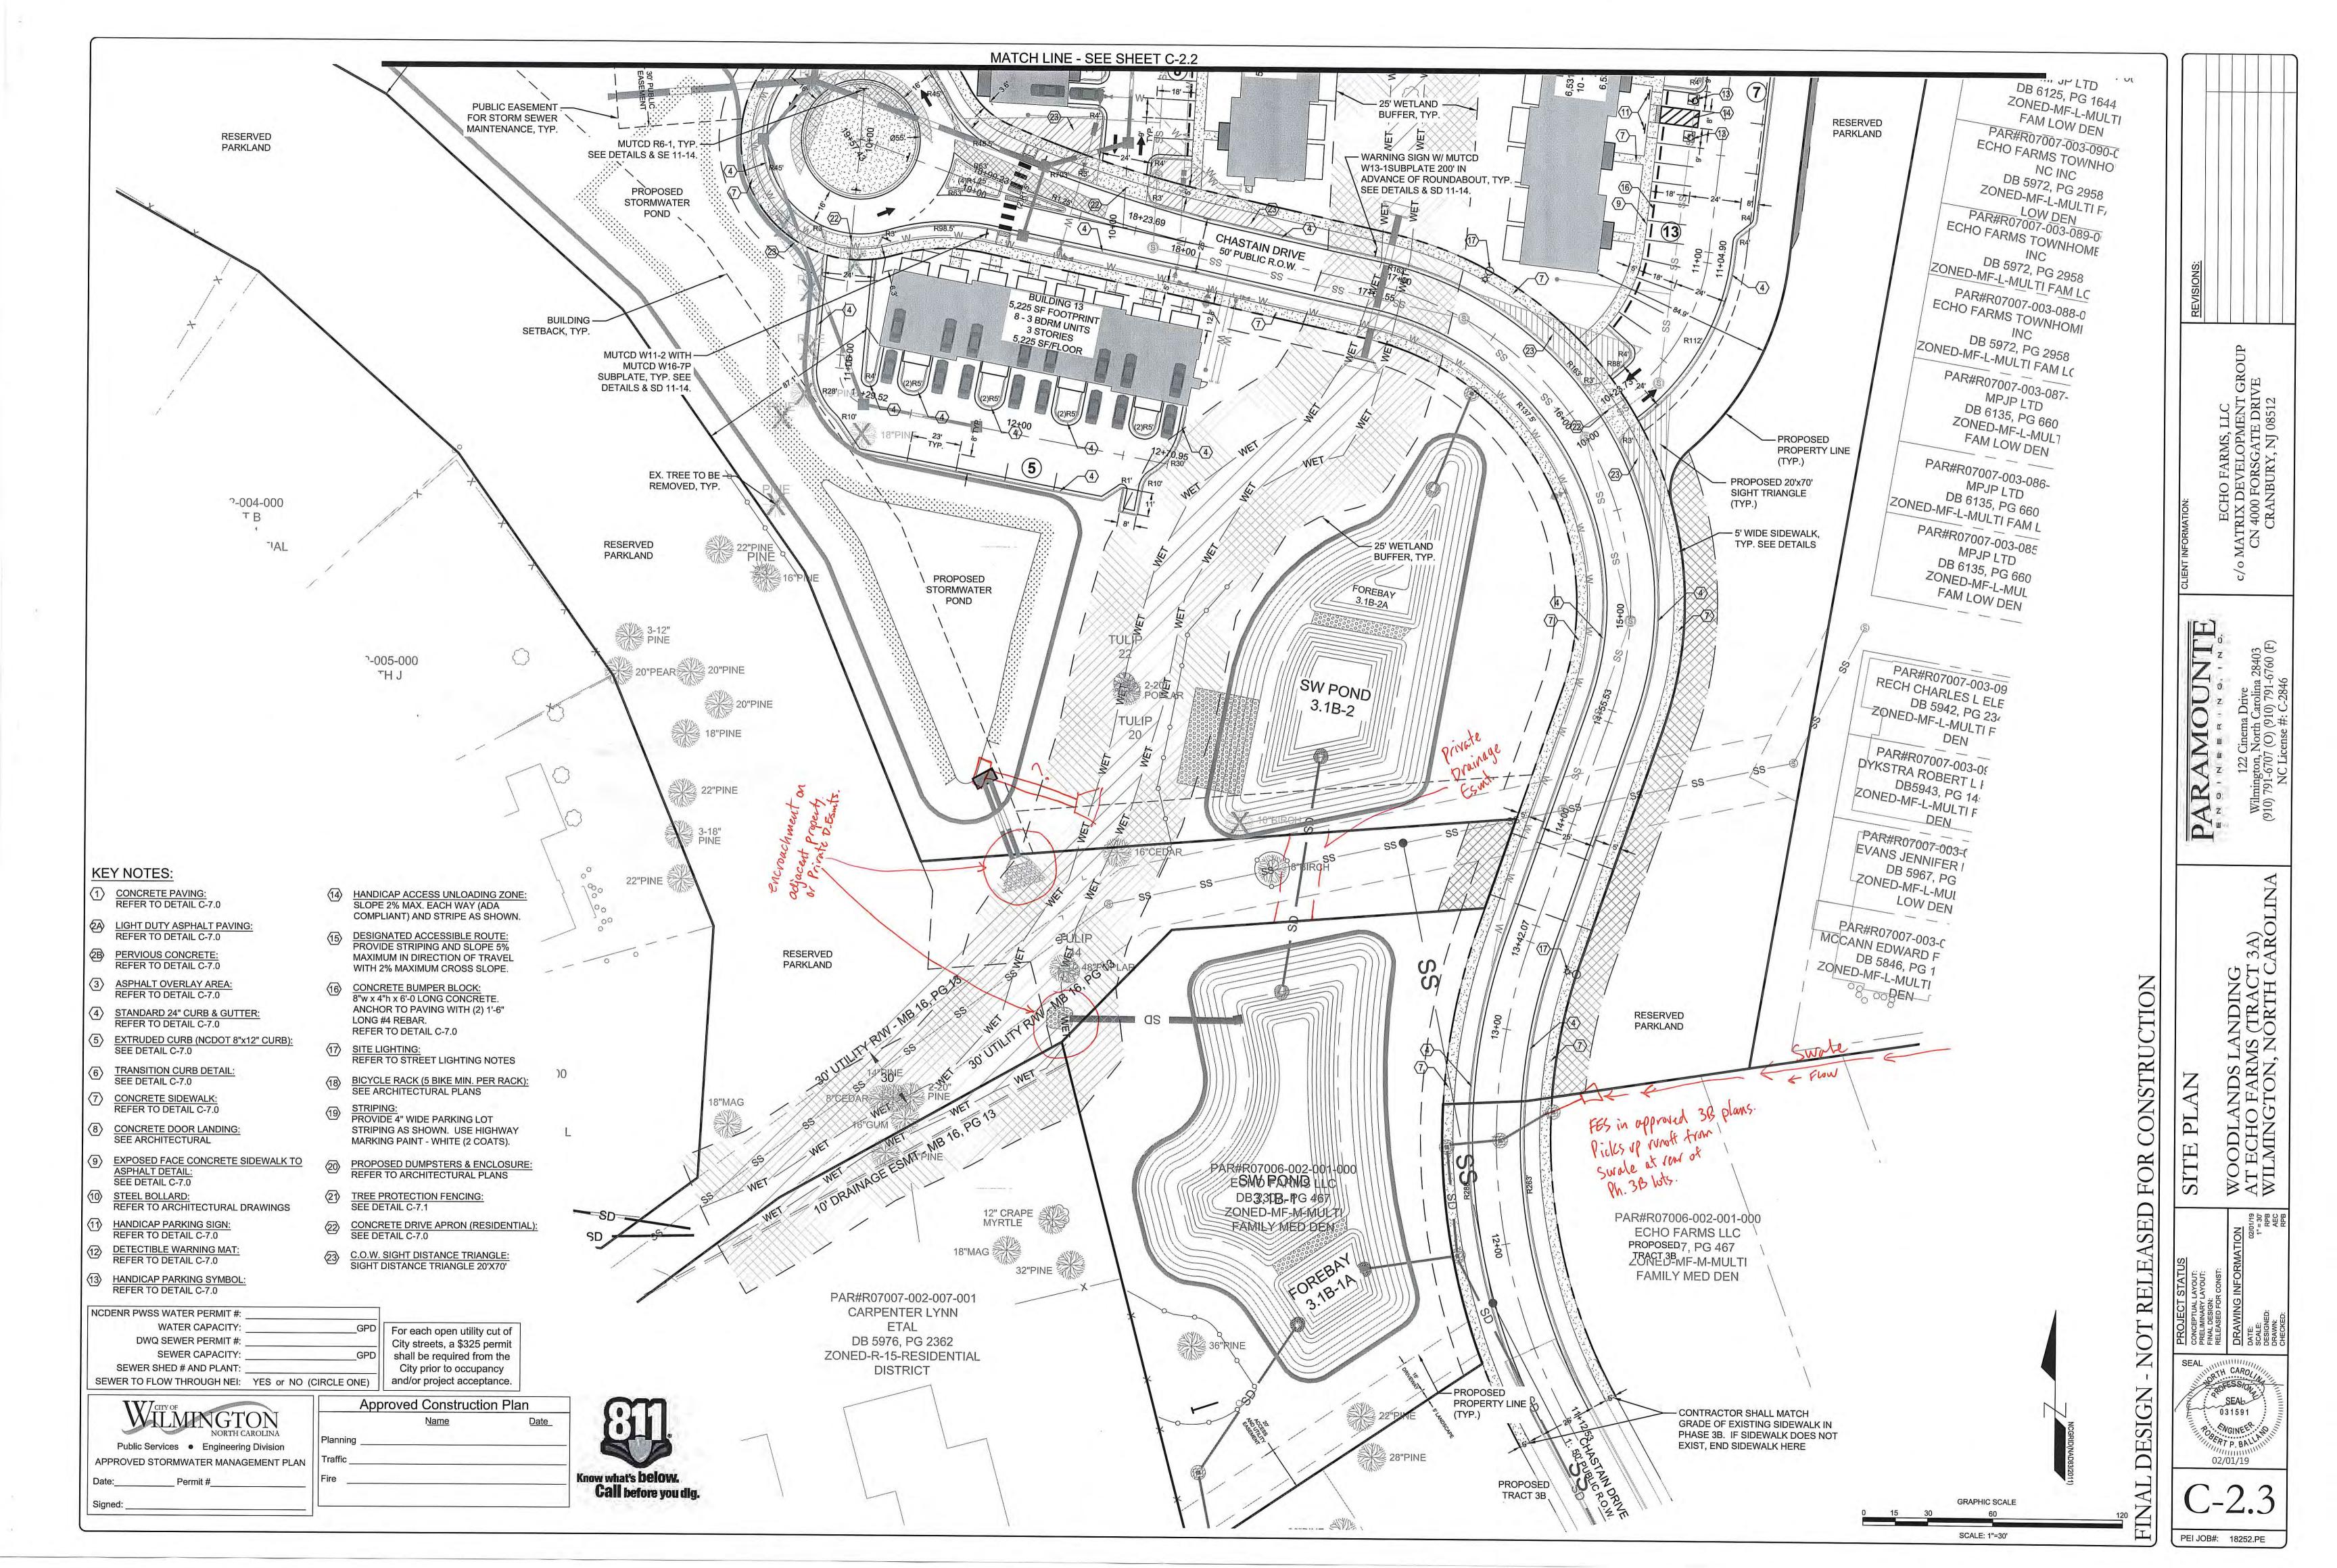



	Woodland Landings @ Ec		& Required Mitigat	tion
	Qty of Trees Caliper Calipers AND Tree Common Nam Inches* Individual Cluster	Classification	Total Cal. Inches to be Removed	%
TECHO FALL	Note: * All listed as total caliper inches for entire tree cluster or single tre diameter at breast height" Essential Site Improvements: It is anticipated that all trees will be remov			
So Start Schornenservo Securo	REG Category 1 (100% Mitigation)	GULATED & SIGNIFICANT TREES		
SITE SECTOR	1 14 14 OAK 1 15 15 OAK 1 10 10 BIRCH	hardwood hardwood hardwood	14 15 10	
SITE BEER AND IN A READ IN	1 20 MAPLE (RED MAPLE) 1 12 12 1 17 17	hardwood ornamental flowering ornamental flowering	20 12 17	
APPLETON WAY	1 21 21 CYPRESS 1 24 24 CYPRESS	ornamental flowering conifer	21 24	
	1 28 28 CYPRESS	conifer 	28 Total Category 1 Significa ees To Be Removed with	
	Category 2 (75% Mitigation)		1	
WEIERA SHEAD FIRE	1 26 26 GUM 1 33 33 GUM	hardwood hardwood hardwood	10 26 33	
VICINITY MAP SCALE: 1" = 1,000'	1 21 21 CEDAR 1 20 20 PECAN	conifer hardwood	21 20 Tota	al Cat
Kr selbe Ly decree and resonant		Total Category 2 Regulated Tre		
Le cront				5
JO NO LS WO			1	1
SWF SWF				1
Appletick Way				1
HAN I I				
SOILS MAP SCALE: 1" = 500' NORTH			1	1
1. PREPARER OF THE PLAN:	PARAMOUNTE ENGINEERING, INC.			
	122 CINEMA DRIVE WILMINGTON, NC 28403			
2. APPLICANT NAME:	MATRIX DEVELOPMENT GROUP CN 400 FORSGATE DRIVE CRANBURY, NJ 00512			11:1152
3. SITE ADDRESS:	4114 ECHO FARMS BOULEVARD WILMINGTON, NC 28401			11
4. PROPERTY OWNER:	ECHO FARMS, LLC 3 CENTRE DRIVE MONROE TWP., NJ 08831			1 1 (
5. DEVELOPER:	SAME AS PROPERTY OWNER		~	•••
6. PROPERTY BOUNDARY:	SEE PLAN			/
7. ZONING:	MF-M & O&I-1		-	
8. ADJACENT PROPERTY INFORMATION (OWNER AND ZONING):	SEE PLAN			7
9. VICINITY MAP:	SEE MAP ABOVE		7	
	SEE PLAN			A. C.
11. 100 YEAR FLOOD PLAIN BOUNDARY:	SUBJECT PARCEL LIES WITHIN FLOOD ZONE AE (EL 9) AS INDICATED BY FEMA FLOOD ZONE MAP NUMBER 3720312500K BEARING AN EFFECTIVE DATE OF AUGUST 28, 2018.			100-174
12. LOCATION OF EXISTING DITCHES, CREEKS, AND STREAMS:	SEE PLAN		184.18 J	
13. SOILS:	ONSLOW LOAMY FINE SAND (On) JOHNSTON SOILS (JO) CRAVEN FINE SANDY LOAM (Cr) (SEE SOILS MAP ABOVE)		/ //	/ /
14. CAMA AEC & ASSOCIATED SETBACKS:	N/A		¥.	10
15. CAMA LAND CLASSIFICATION:	URBAN /CONSERVATION AREA		1 T	1 de la
16. CONSERVATION RESOURCES:	SWAMP FOREST		1	
17. LOCAL, STATE, OR FEDERAL HISTORIC OR ARCHAEOLOGICAL SITE:	N/A			
18. LOCATION OF CEMETERIES, BURIAL SITES, OR BURIAL GROUNDS:	N/A			
19. SQUARE FOOTAGE OF FORESTED AREA, HABITAT, AND DOMINANT SPECIES:	N/A			
20. SECTION 404 WETLANDS AND SECTION 10 WATERS:	N/A			
21. PROTECTED SPECIES OR HABITAT:	N/A			
	A REAL PROPERTY OF A REA			

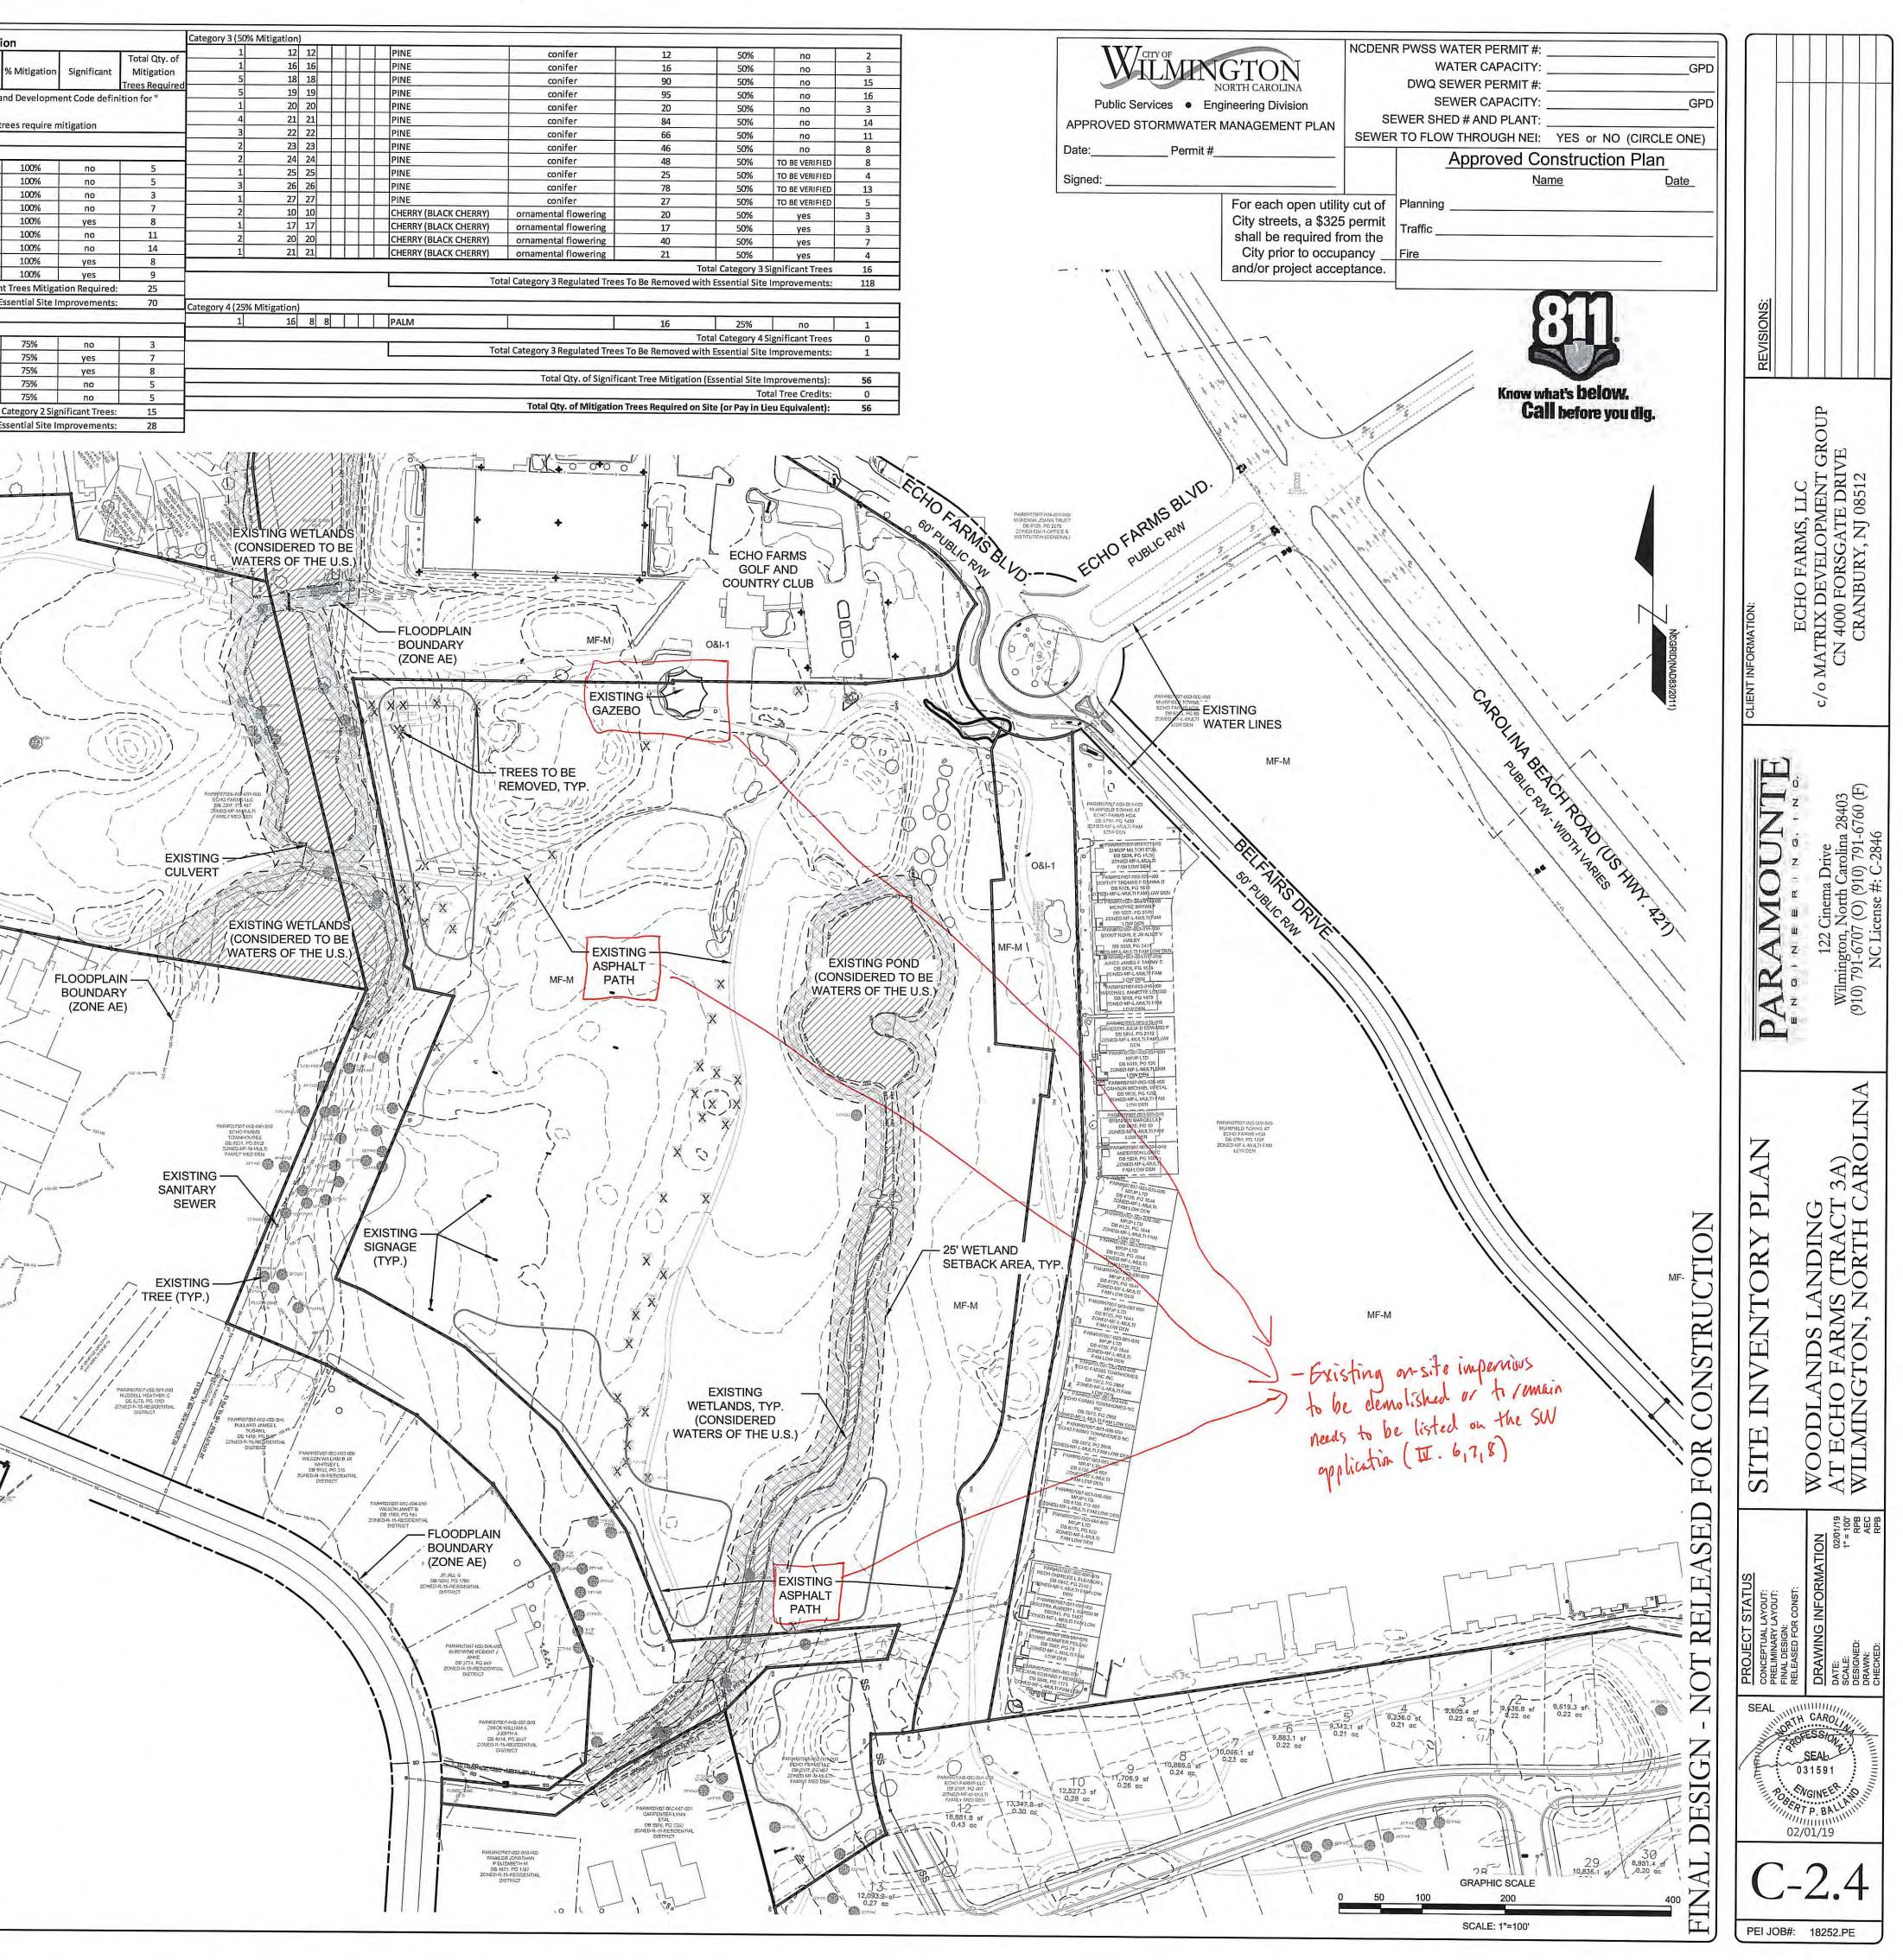


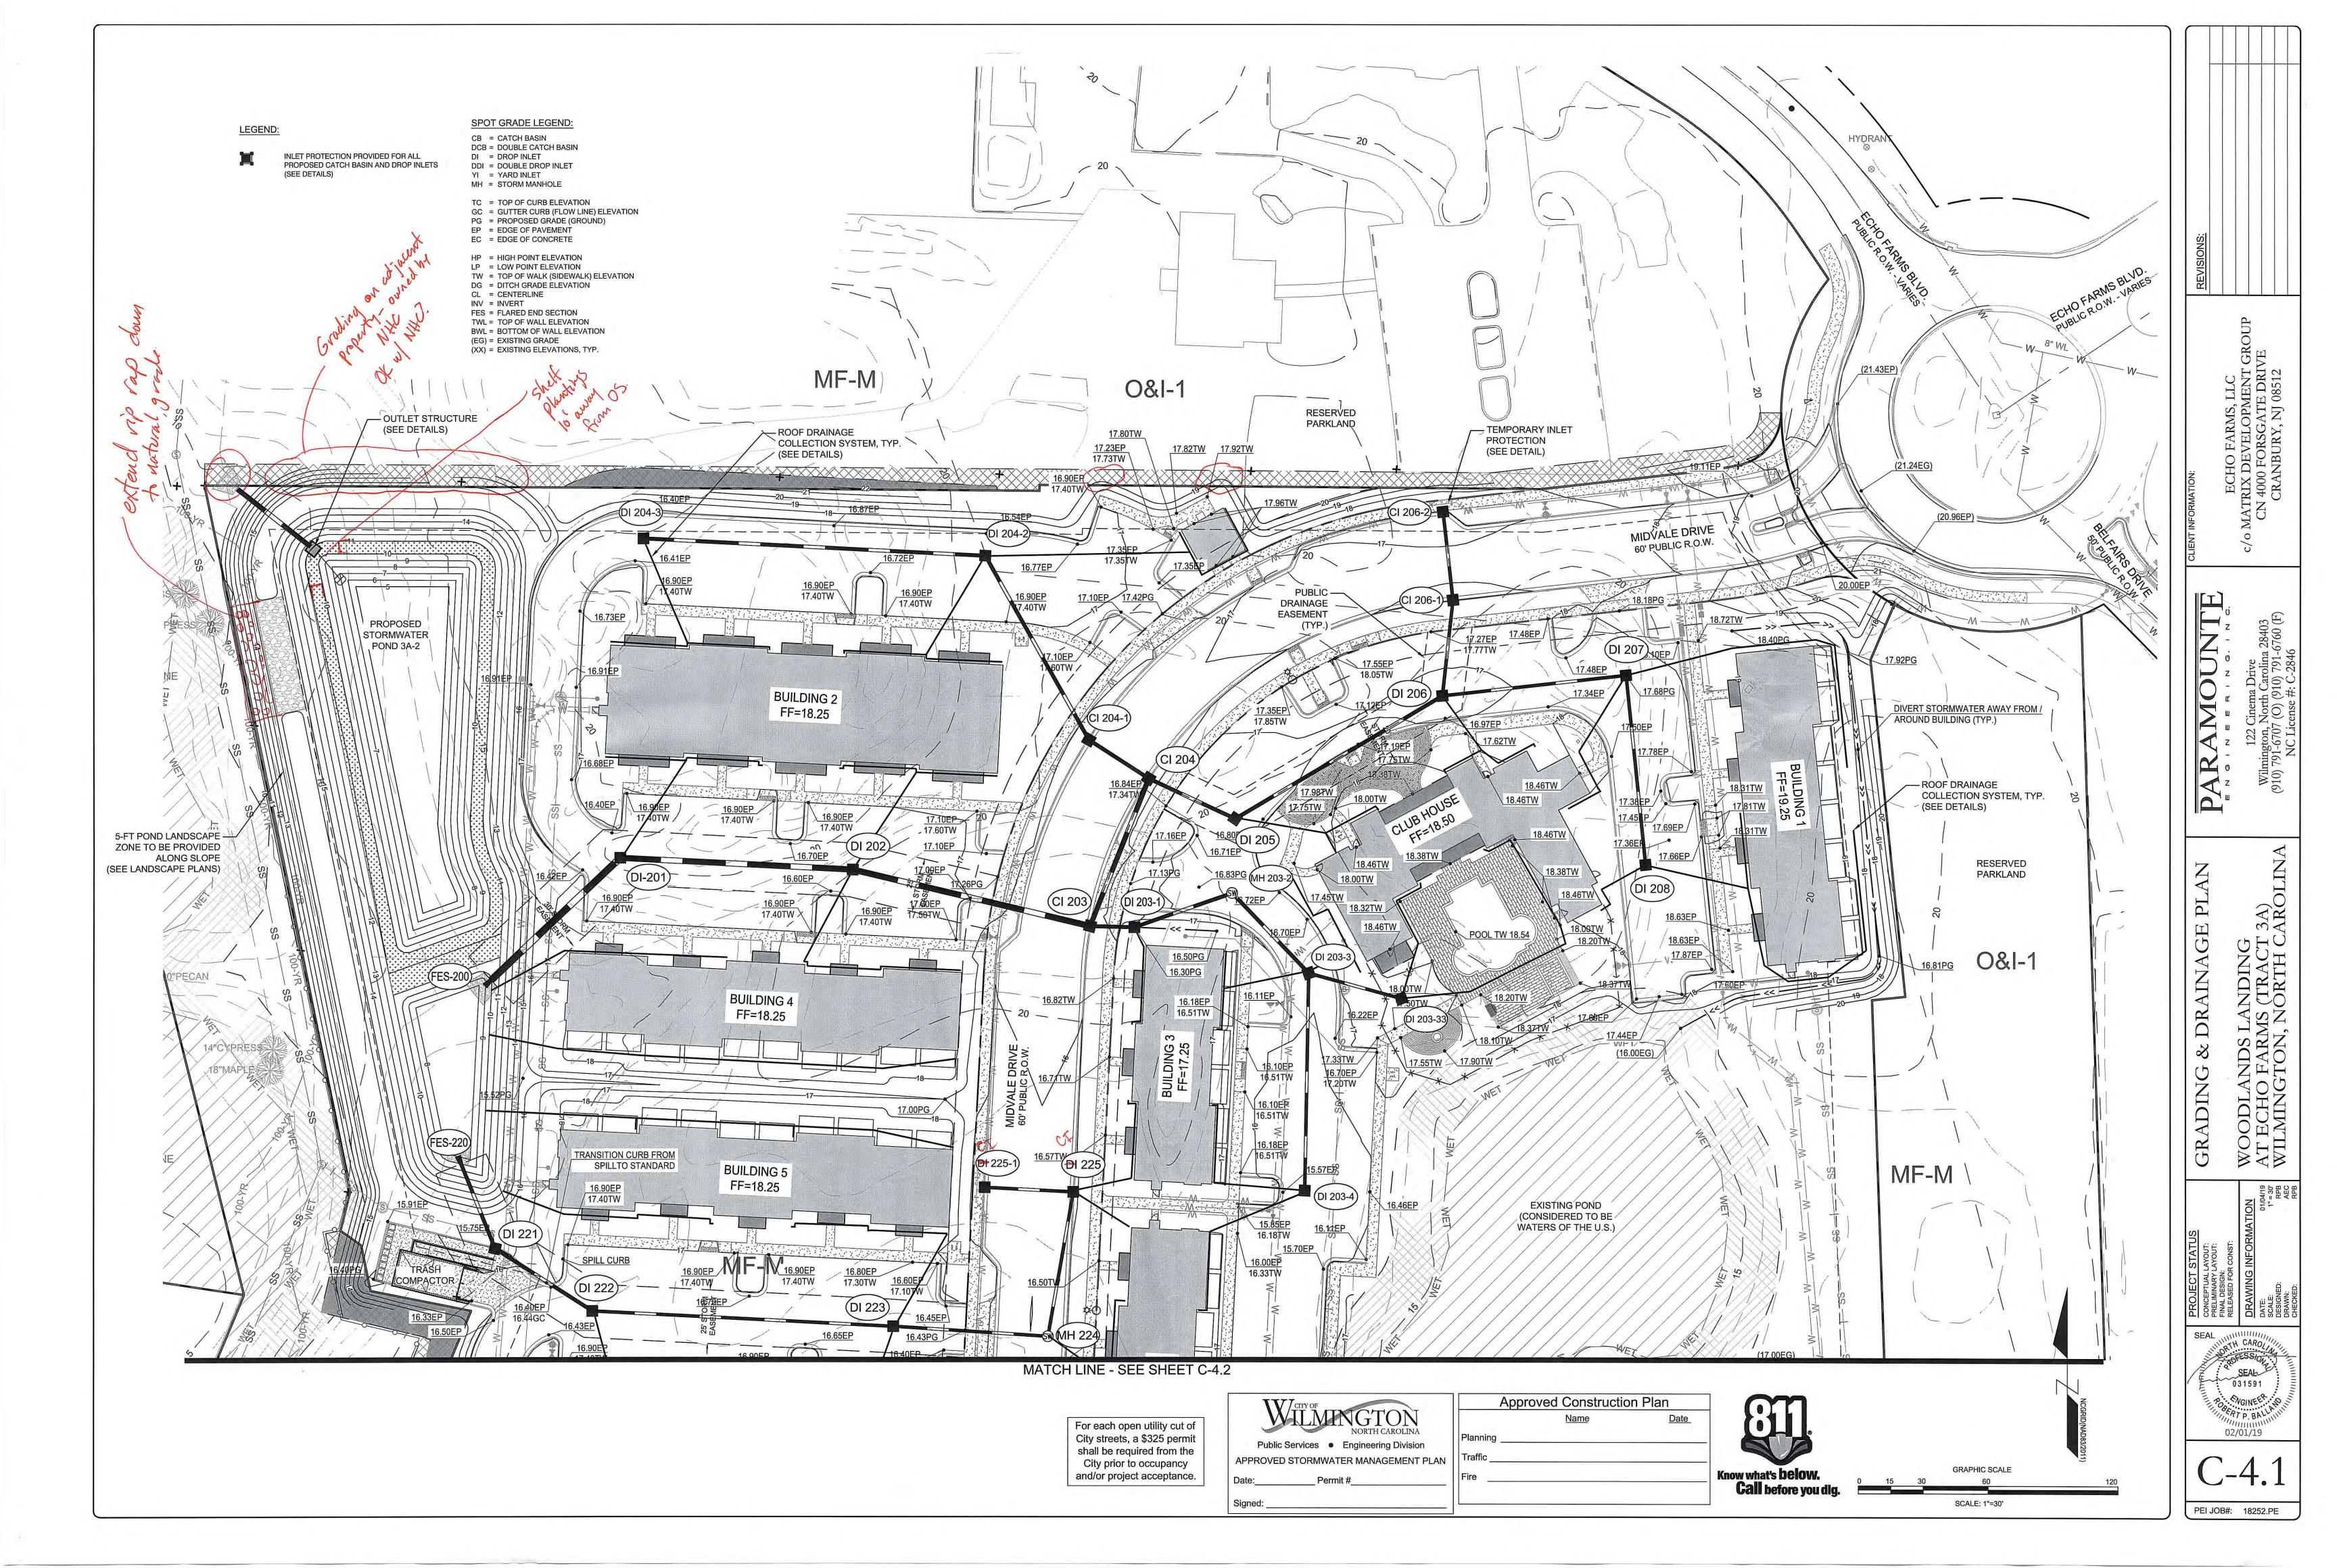


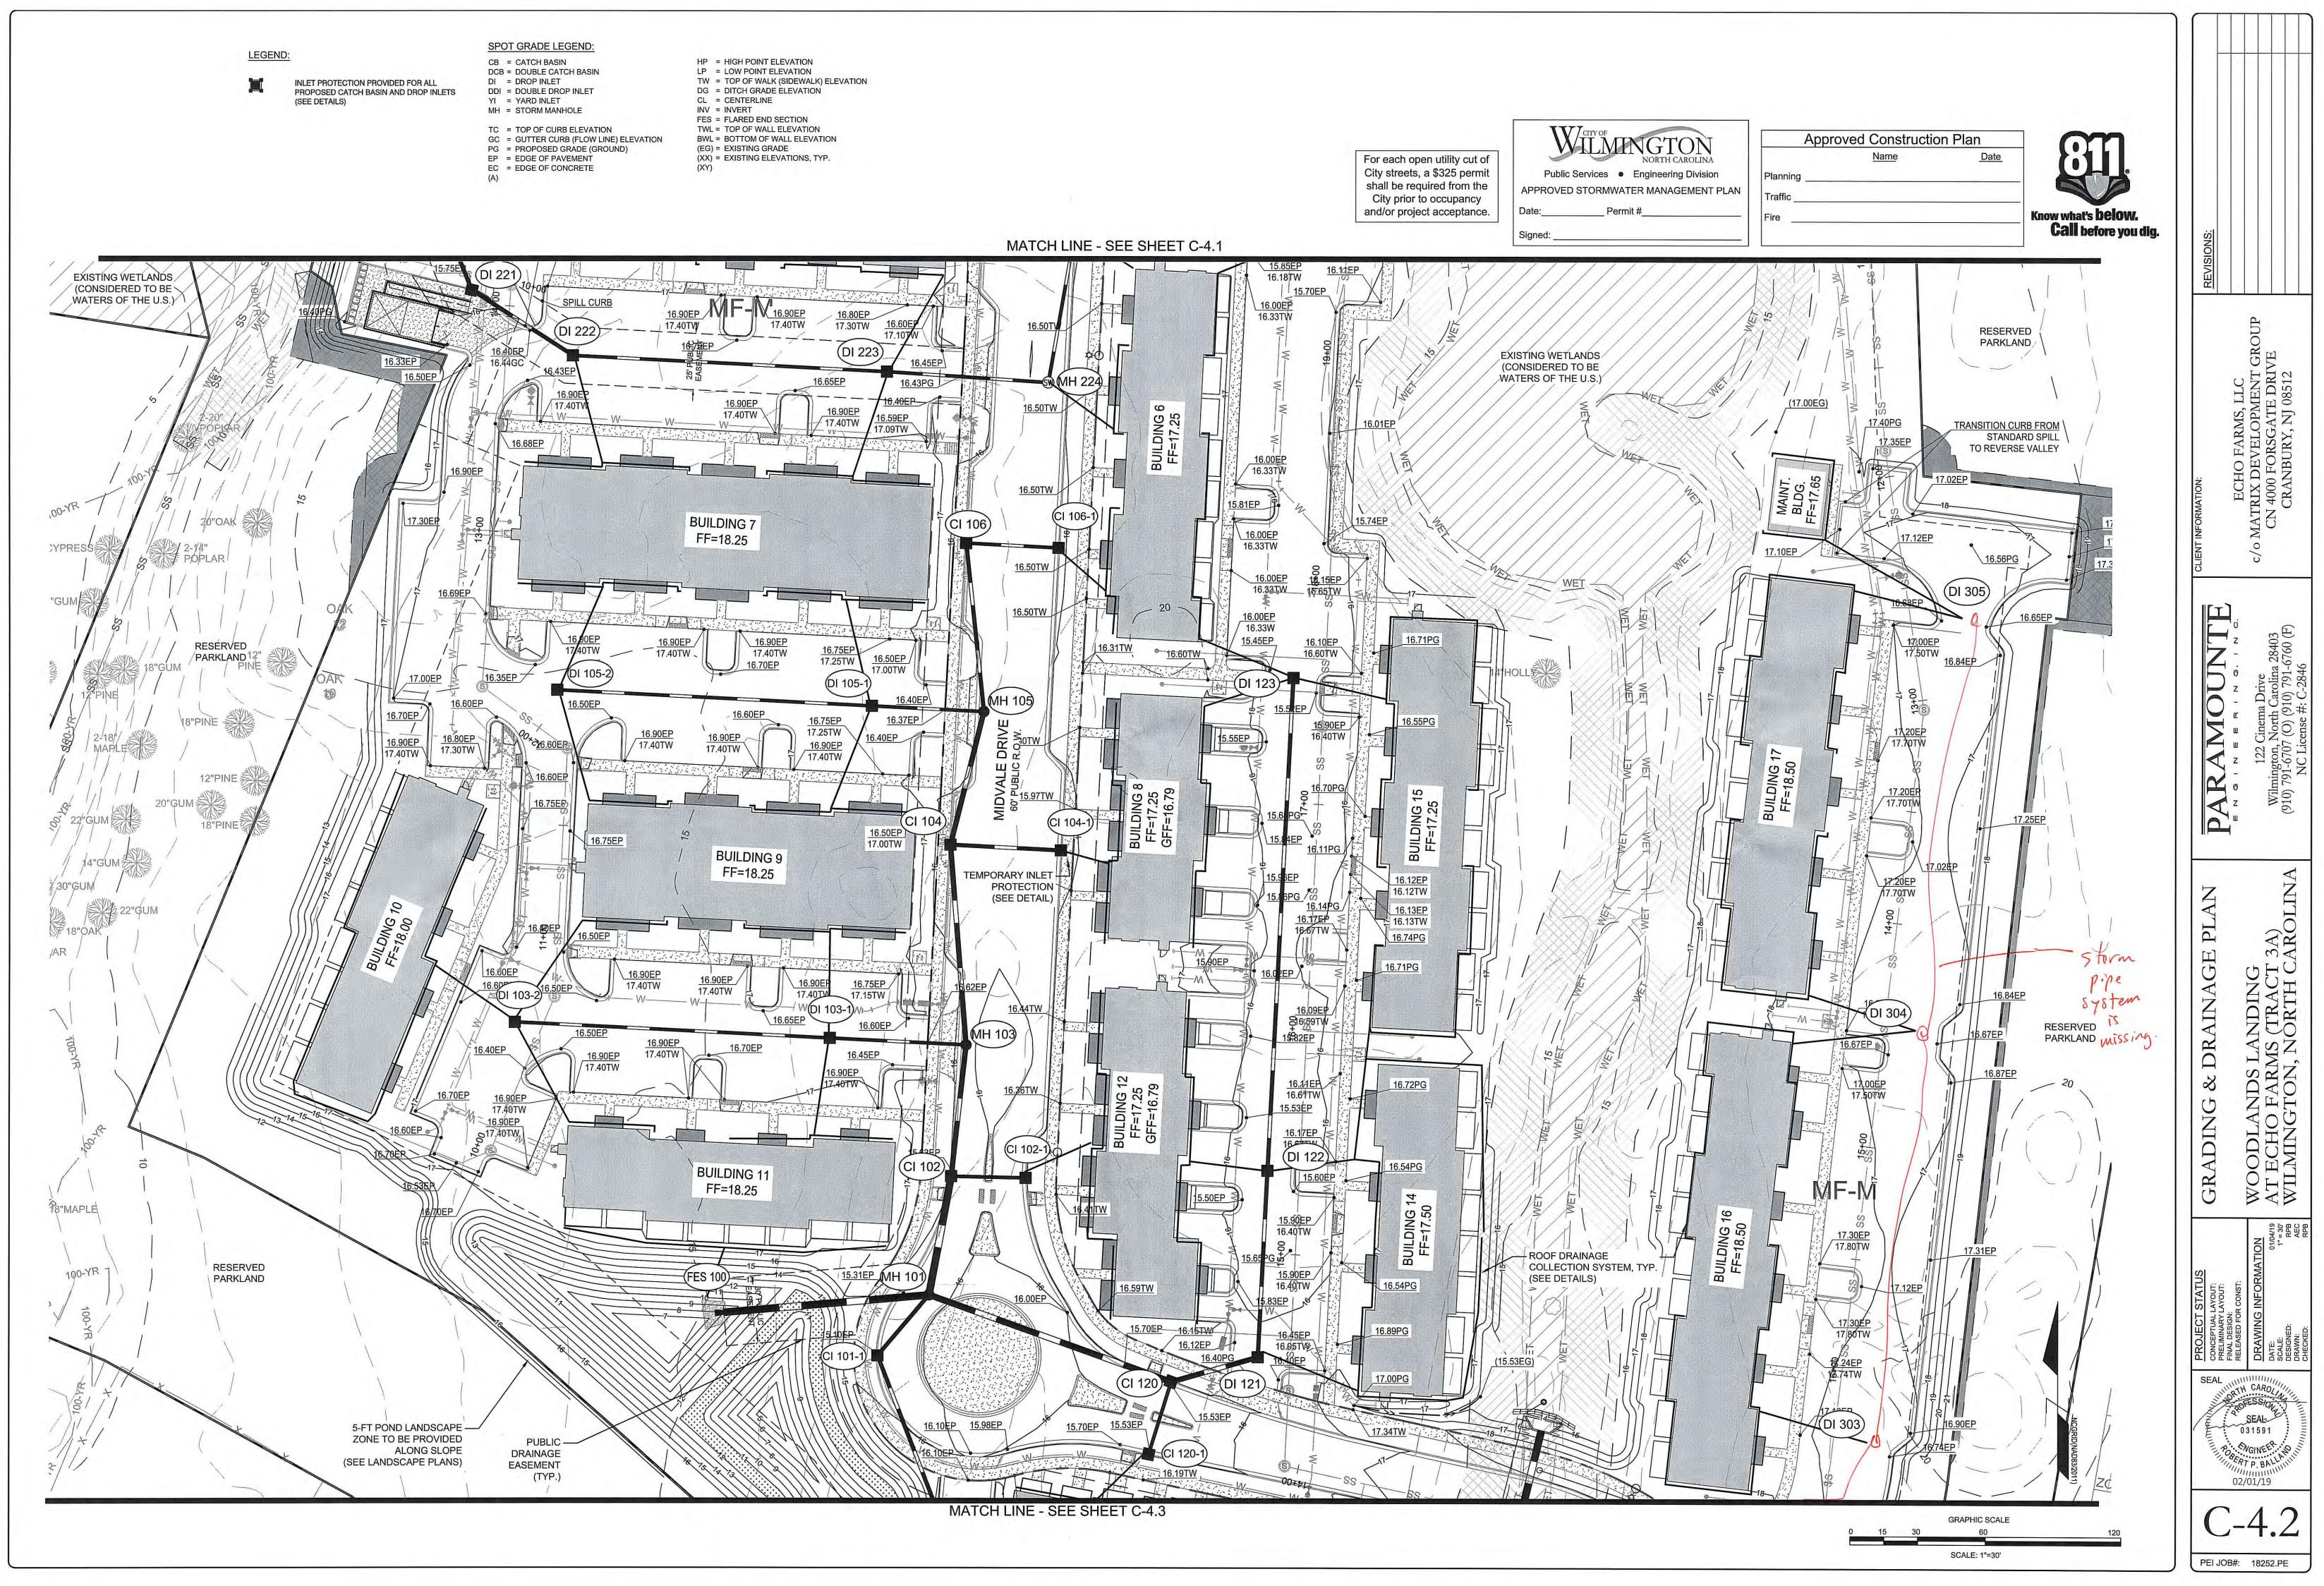


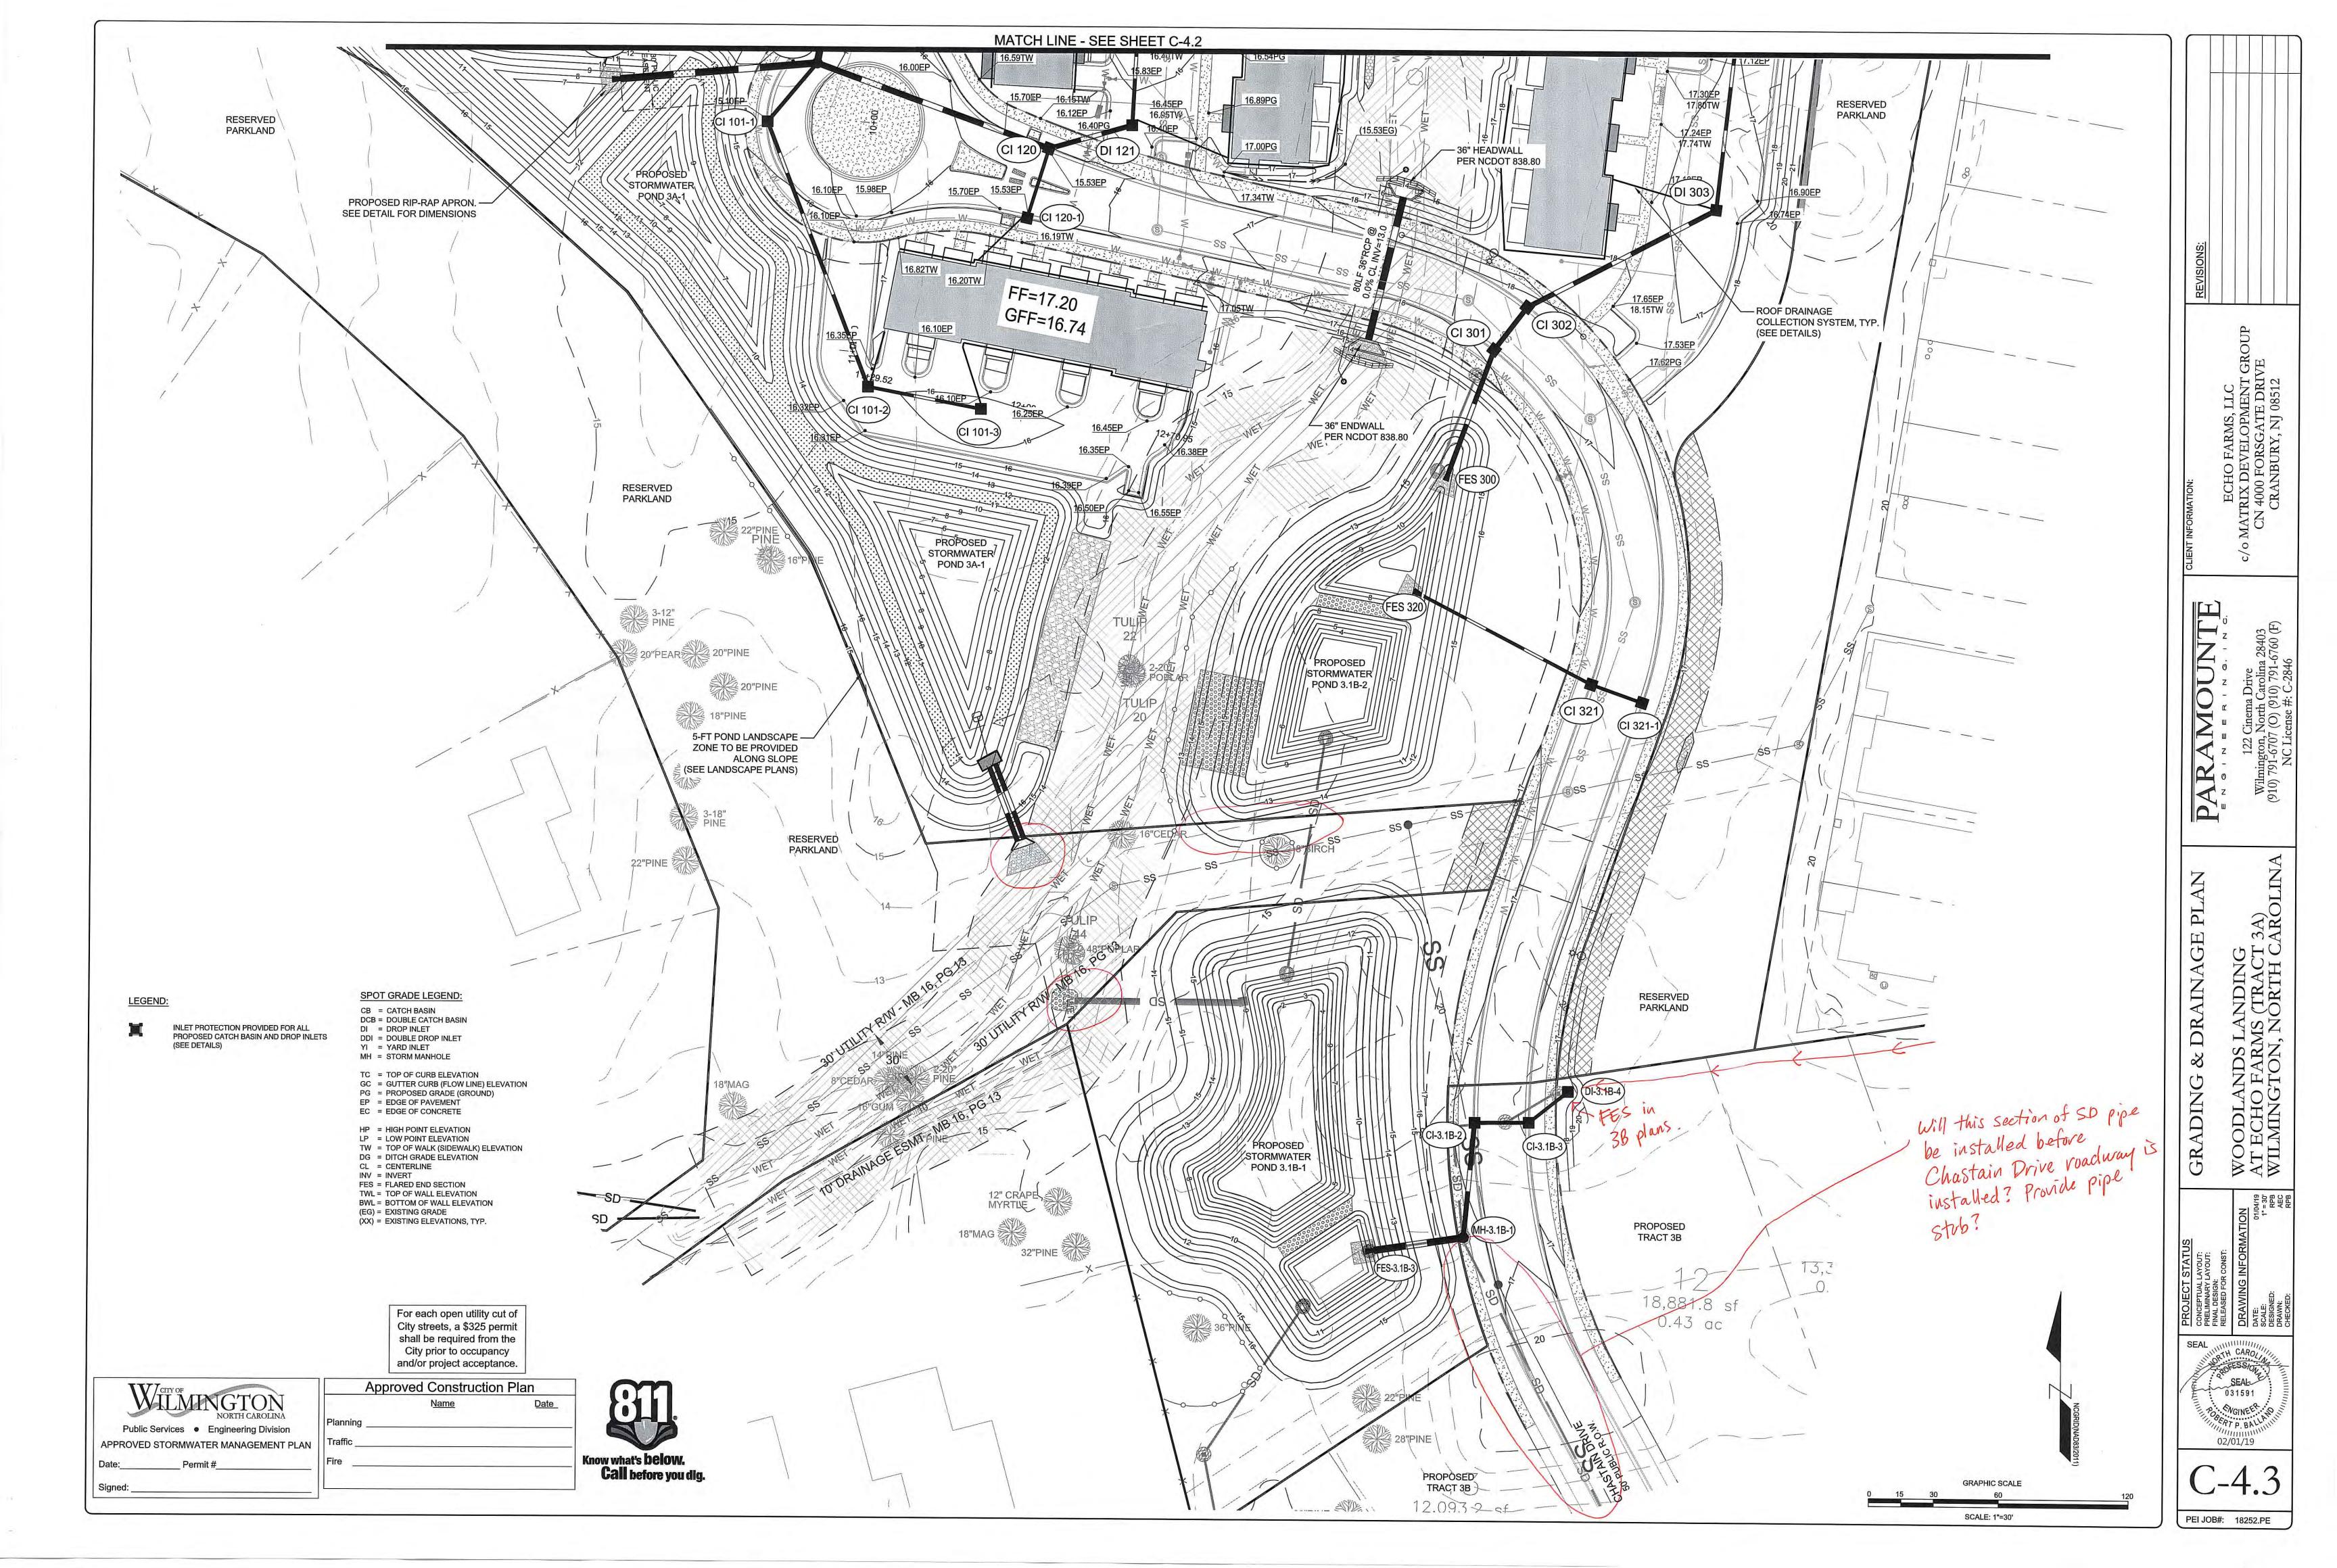


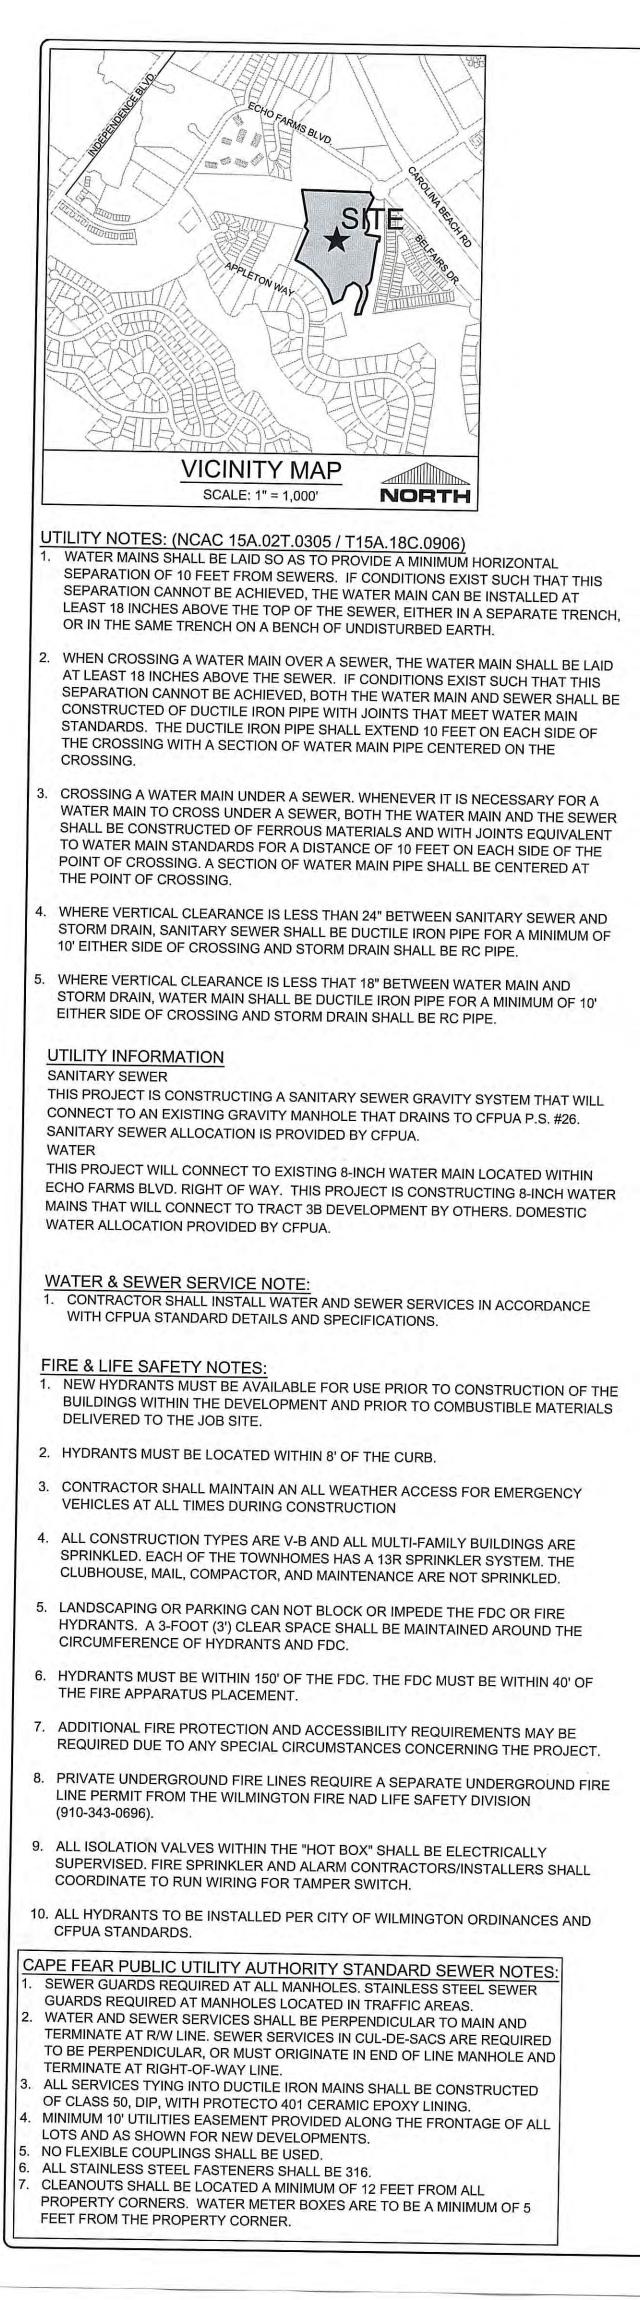


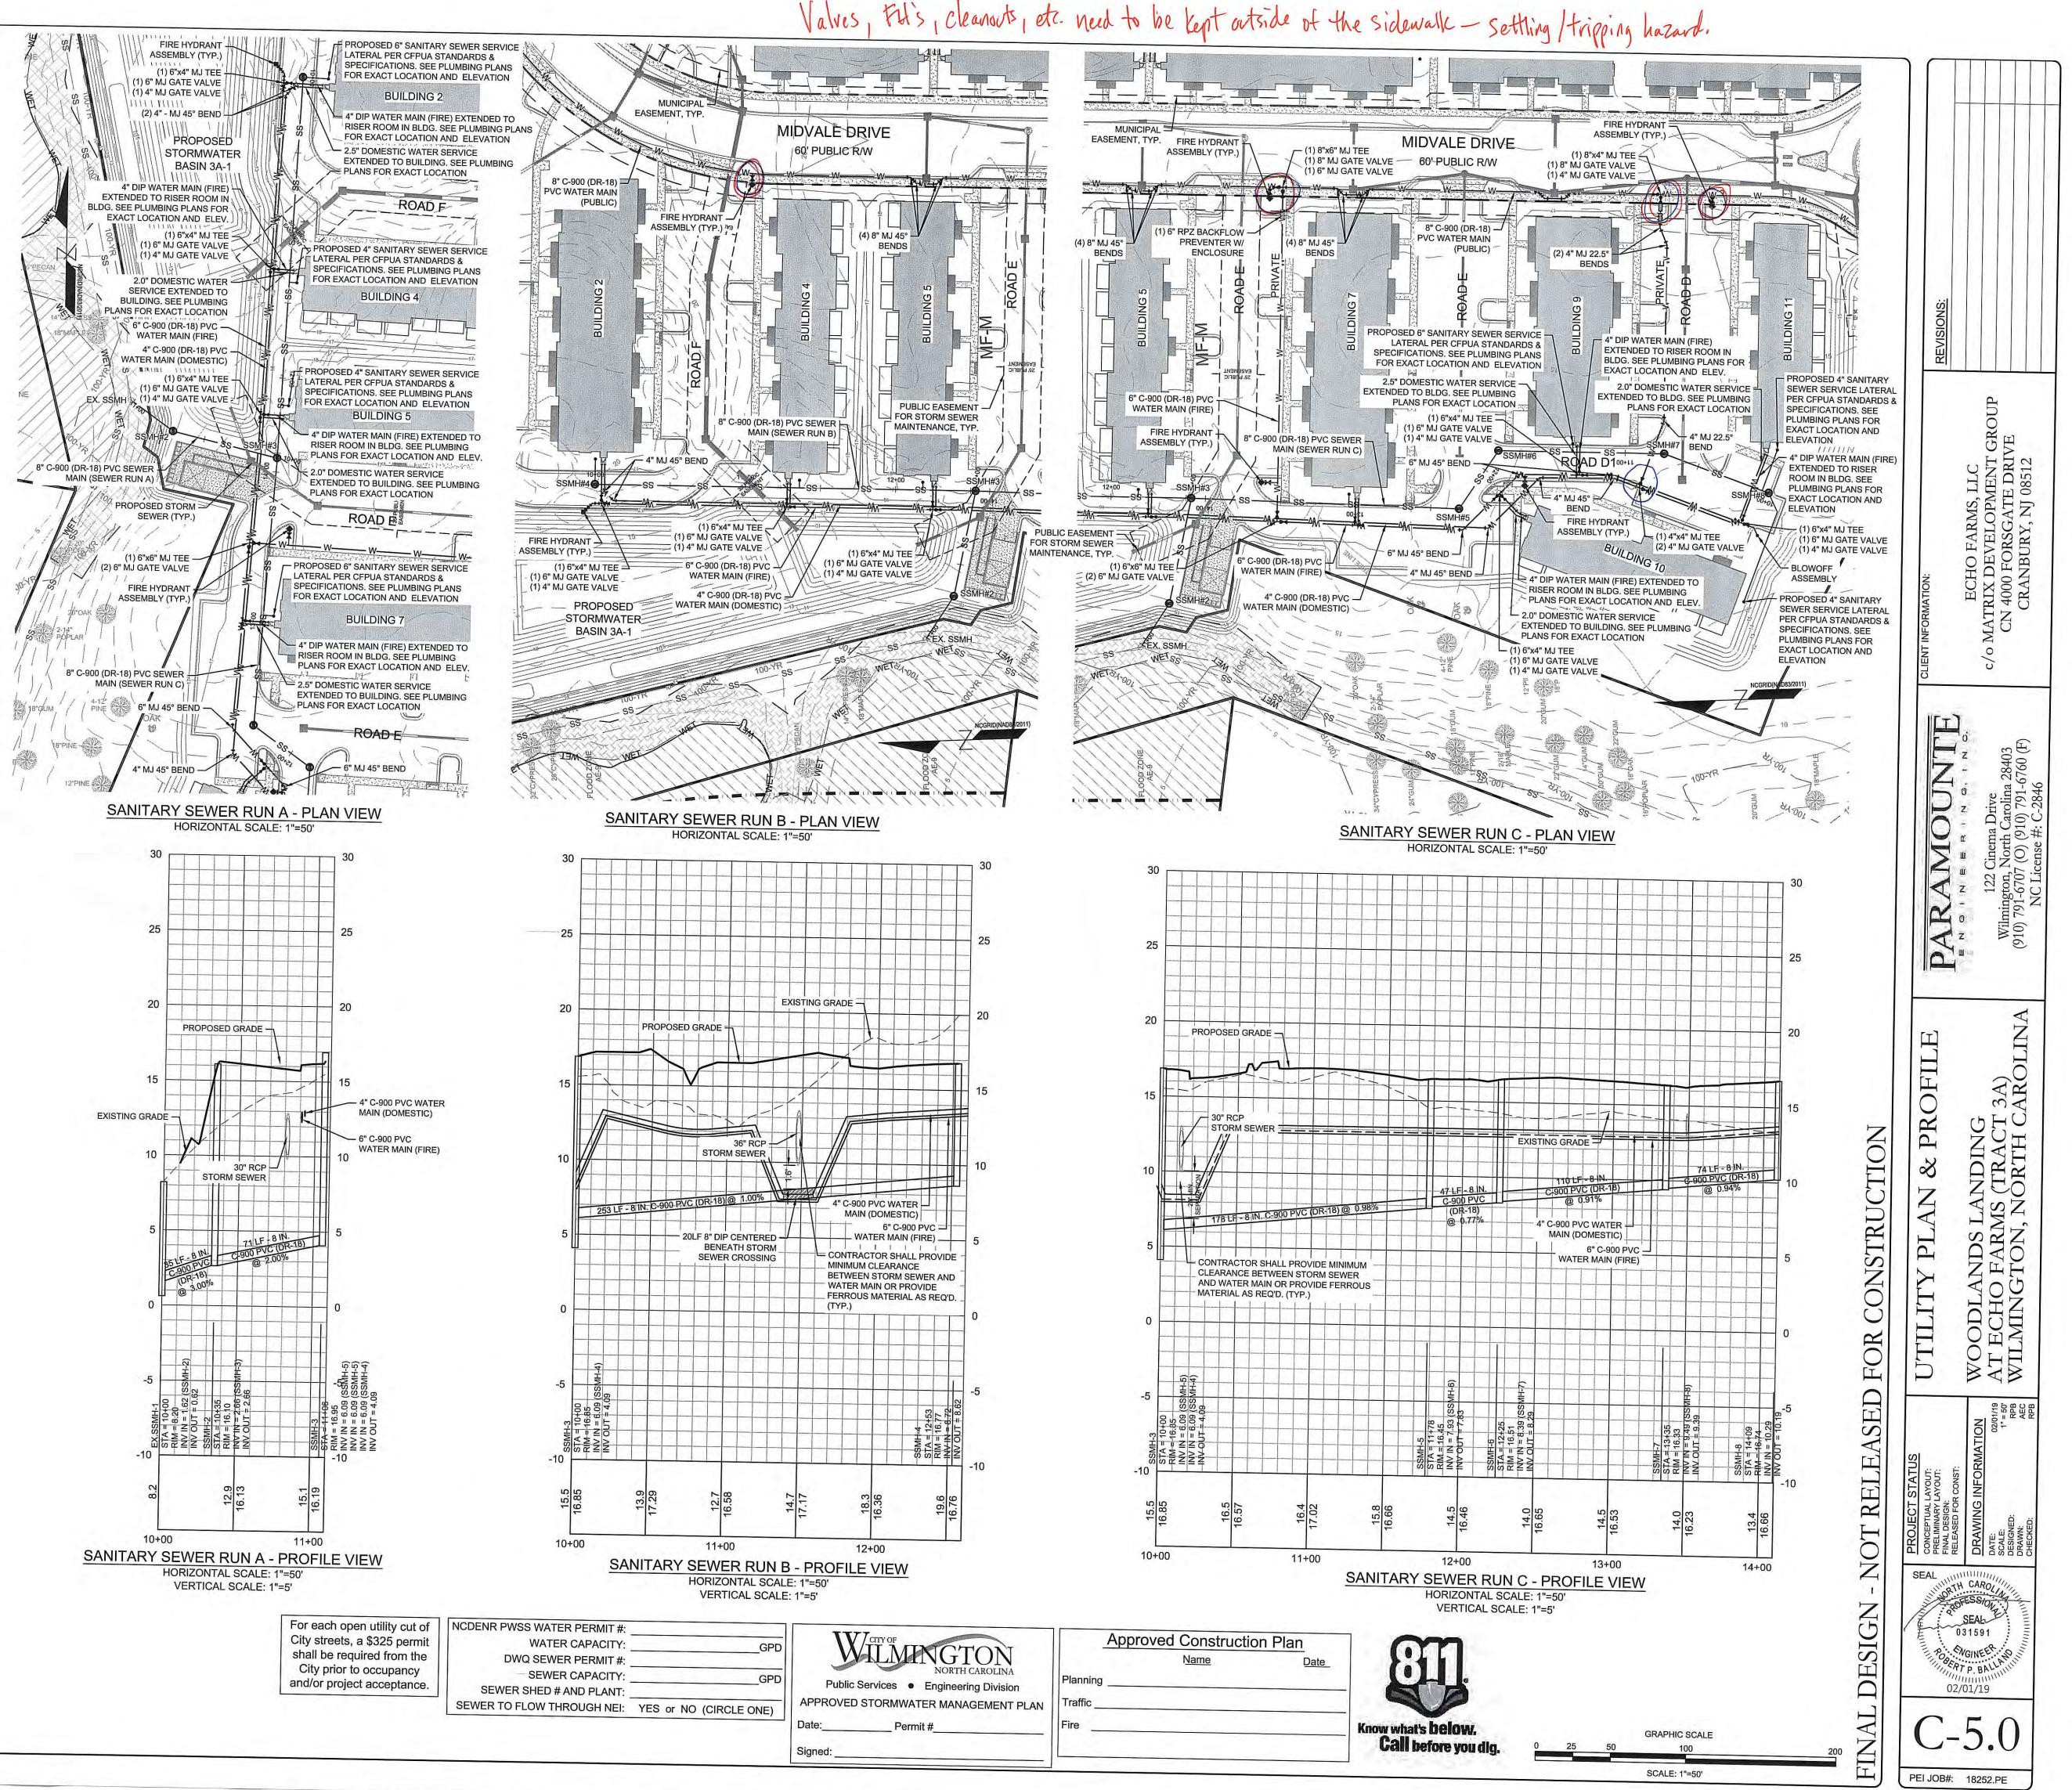


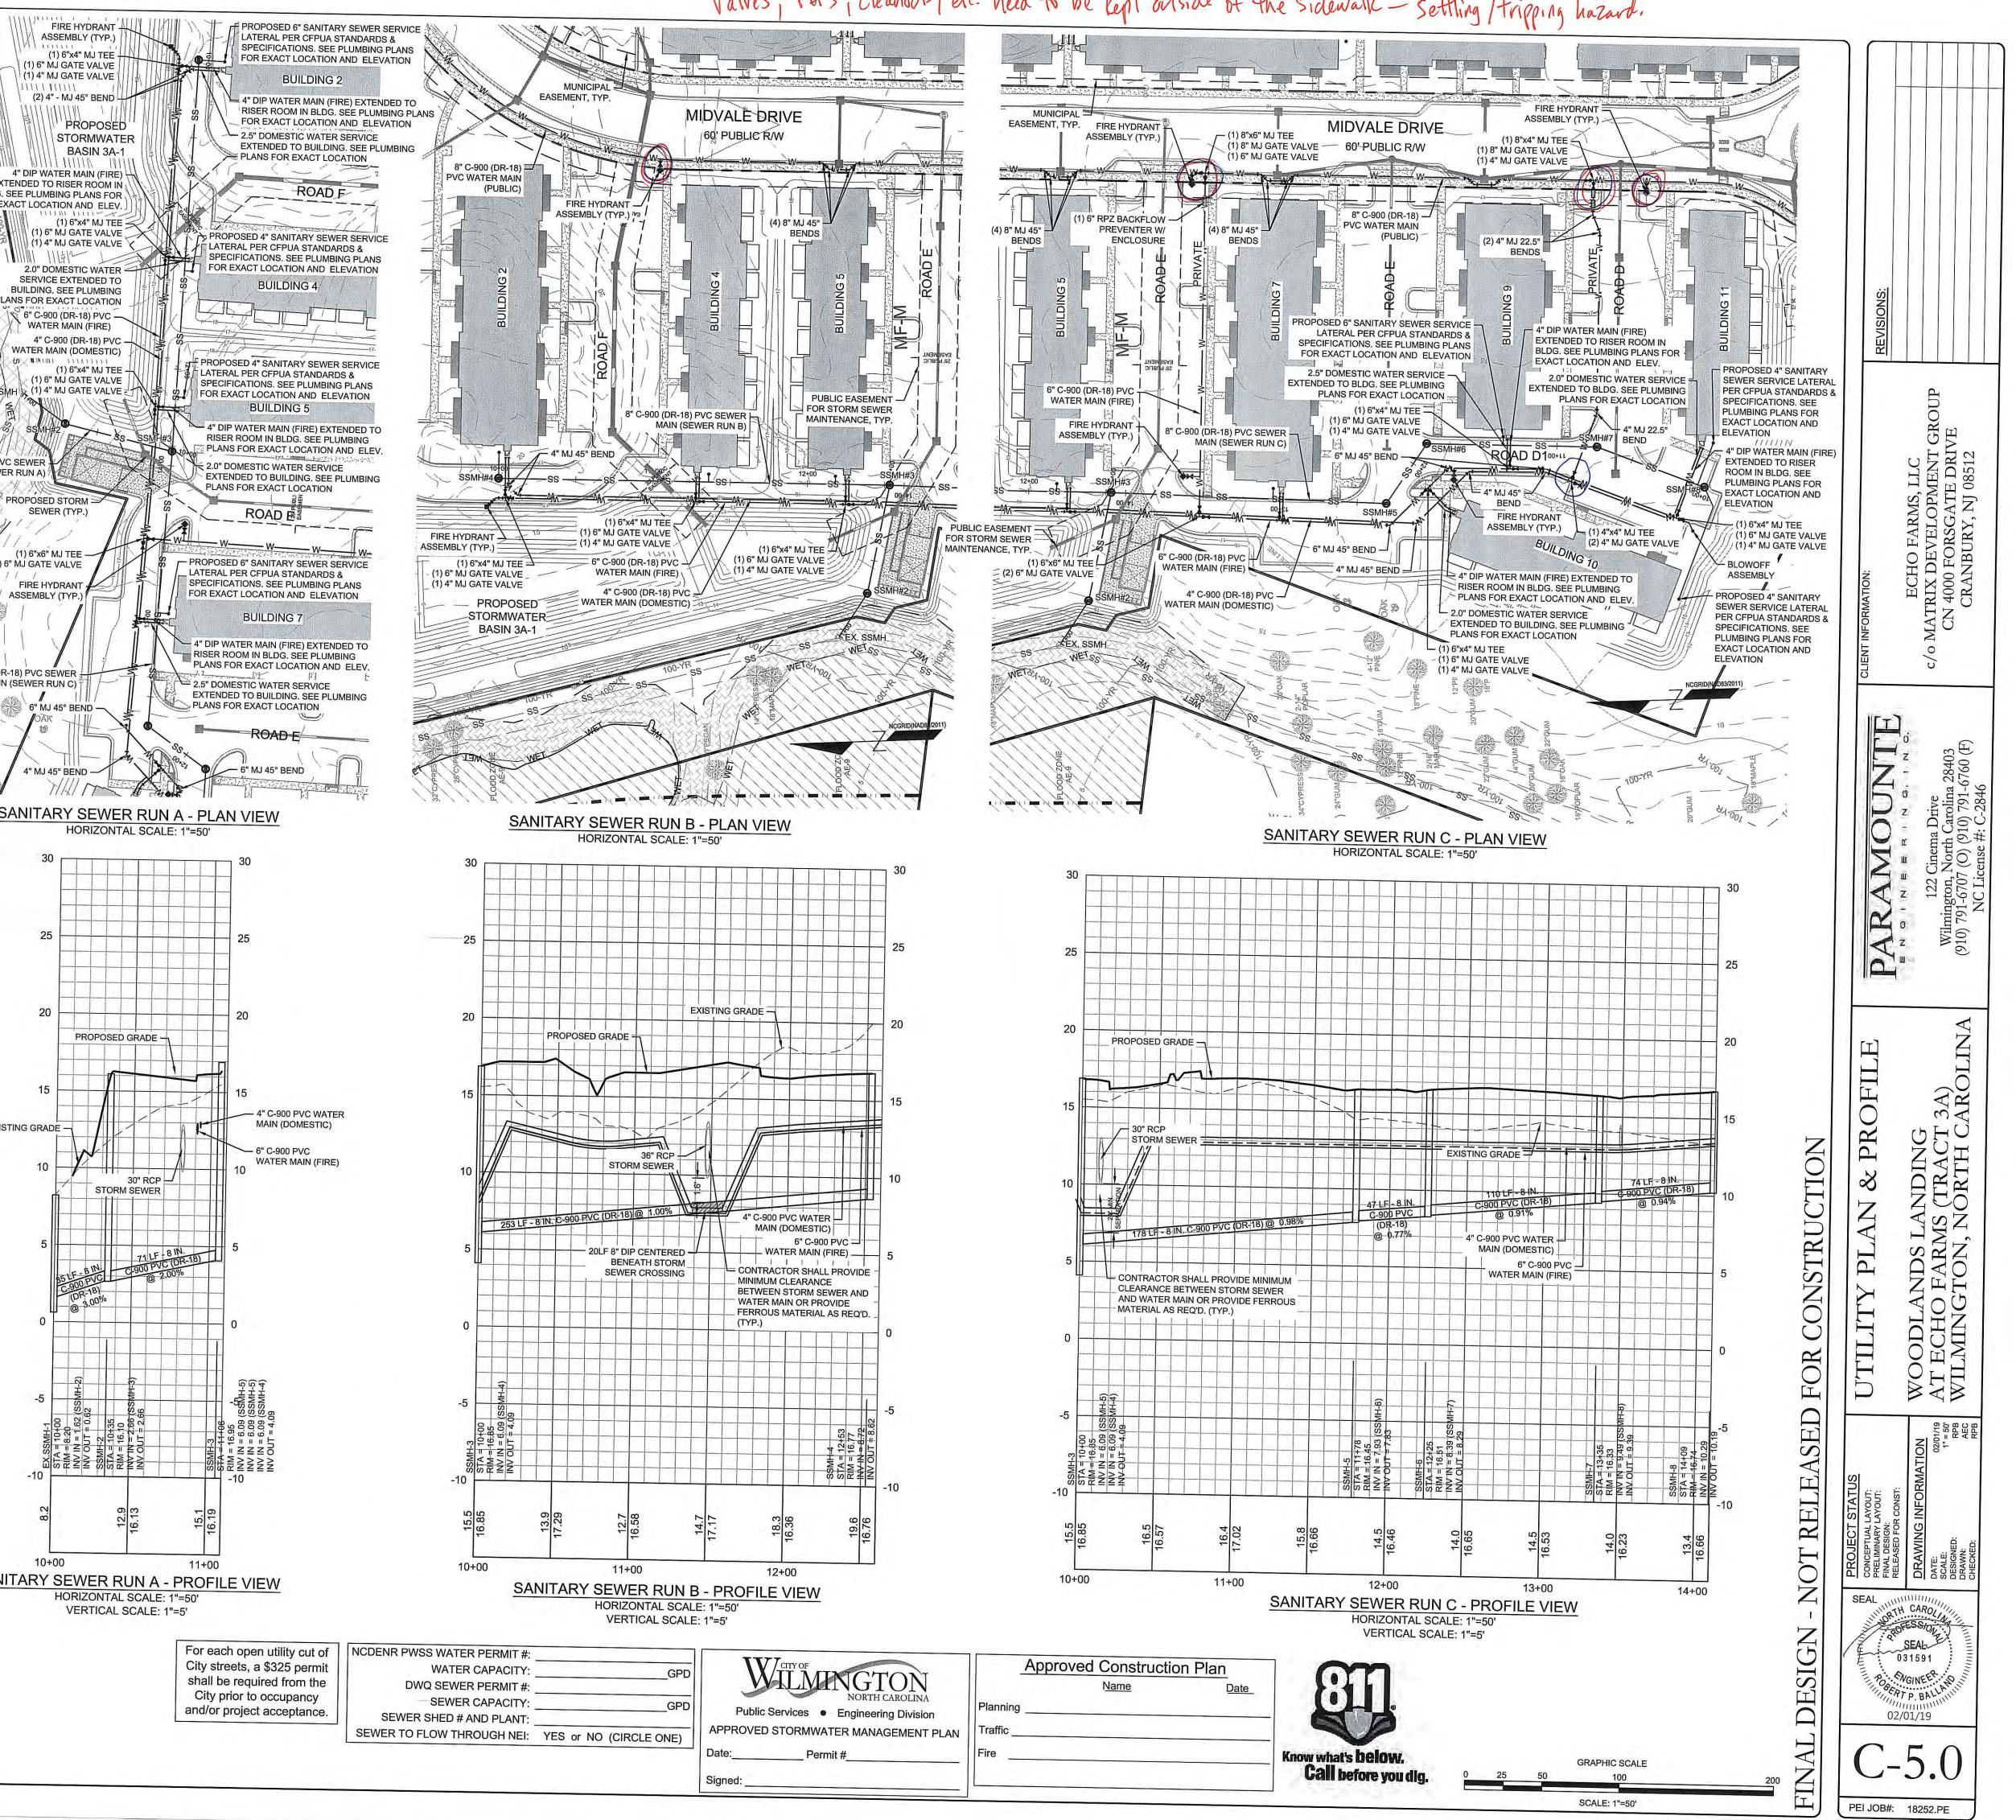


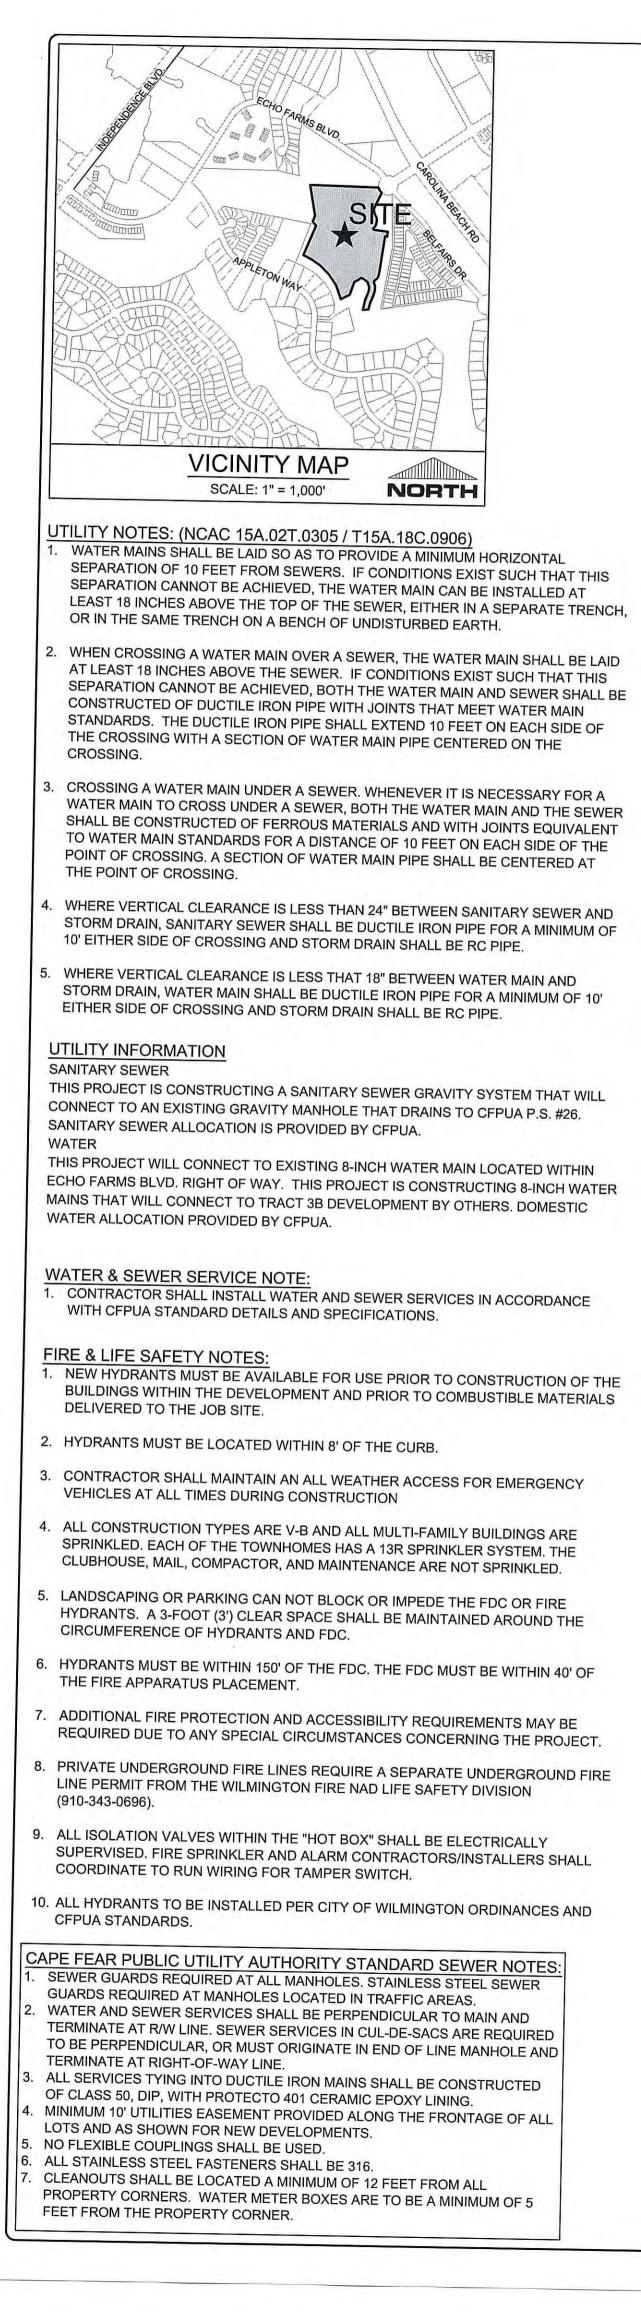

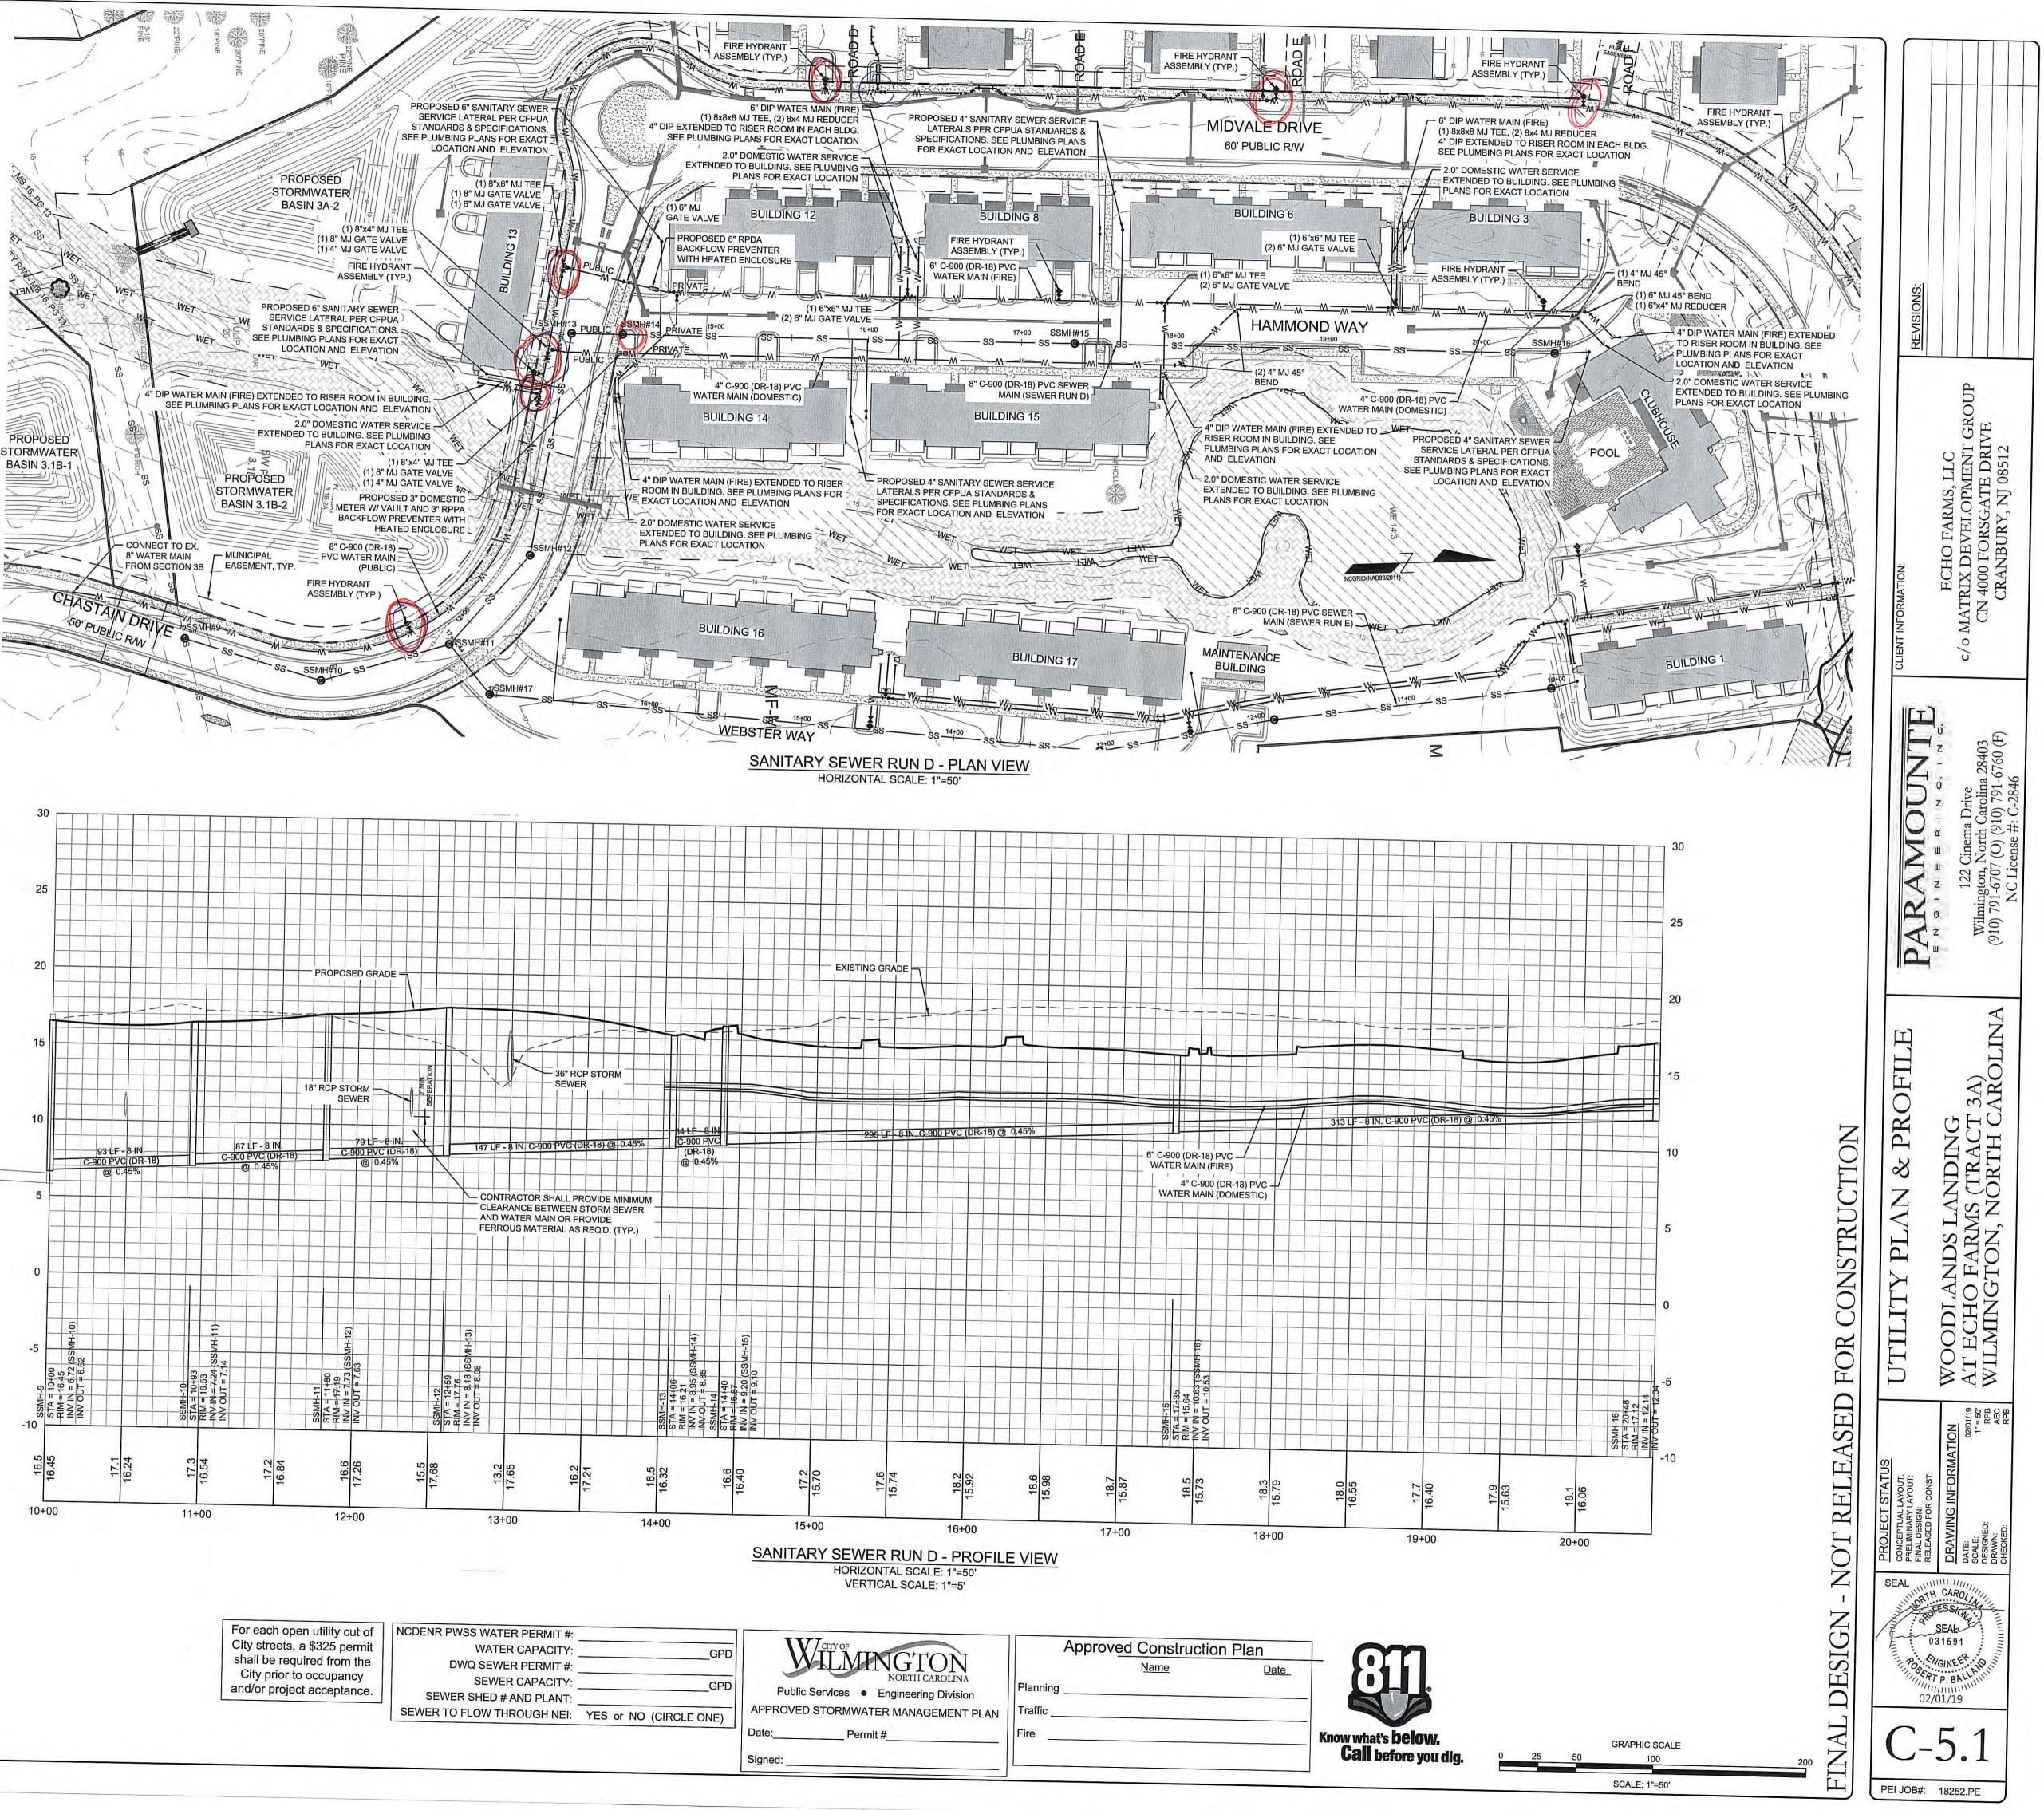

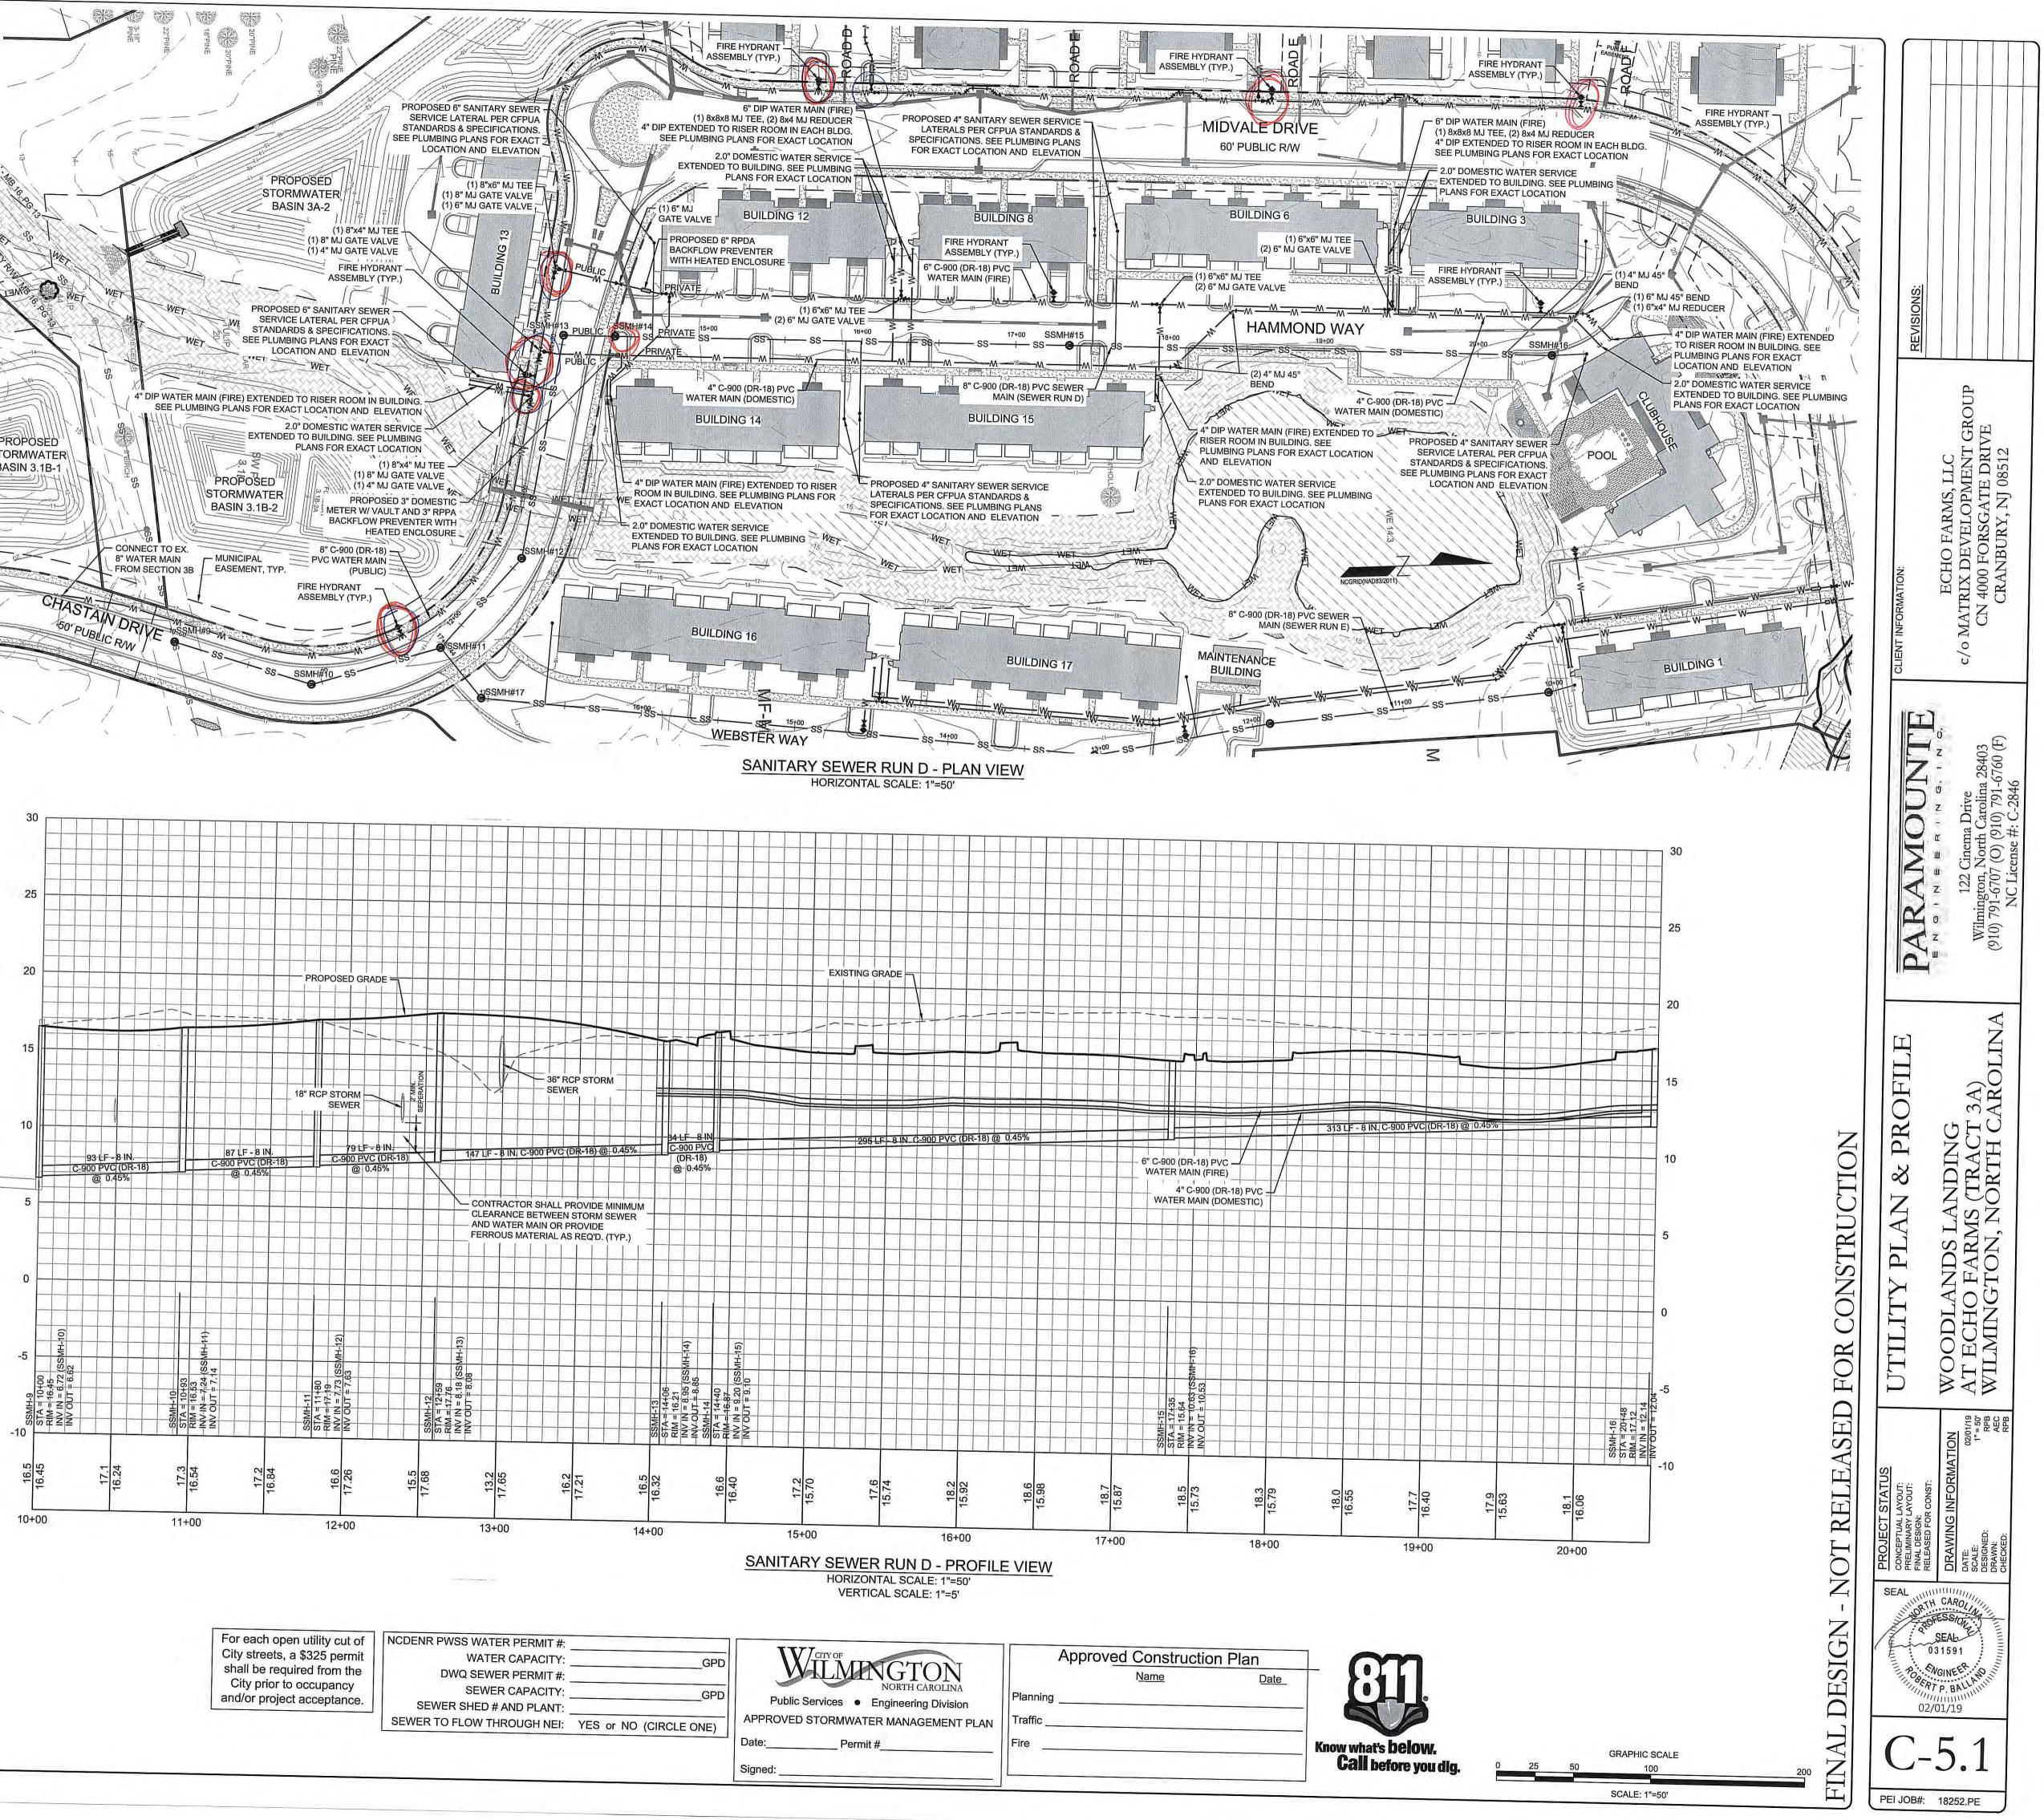

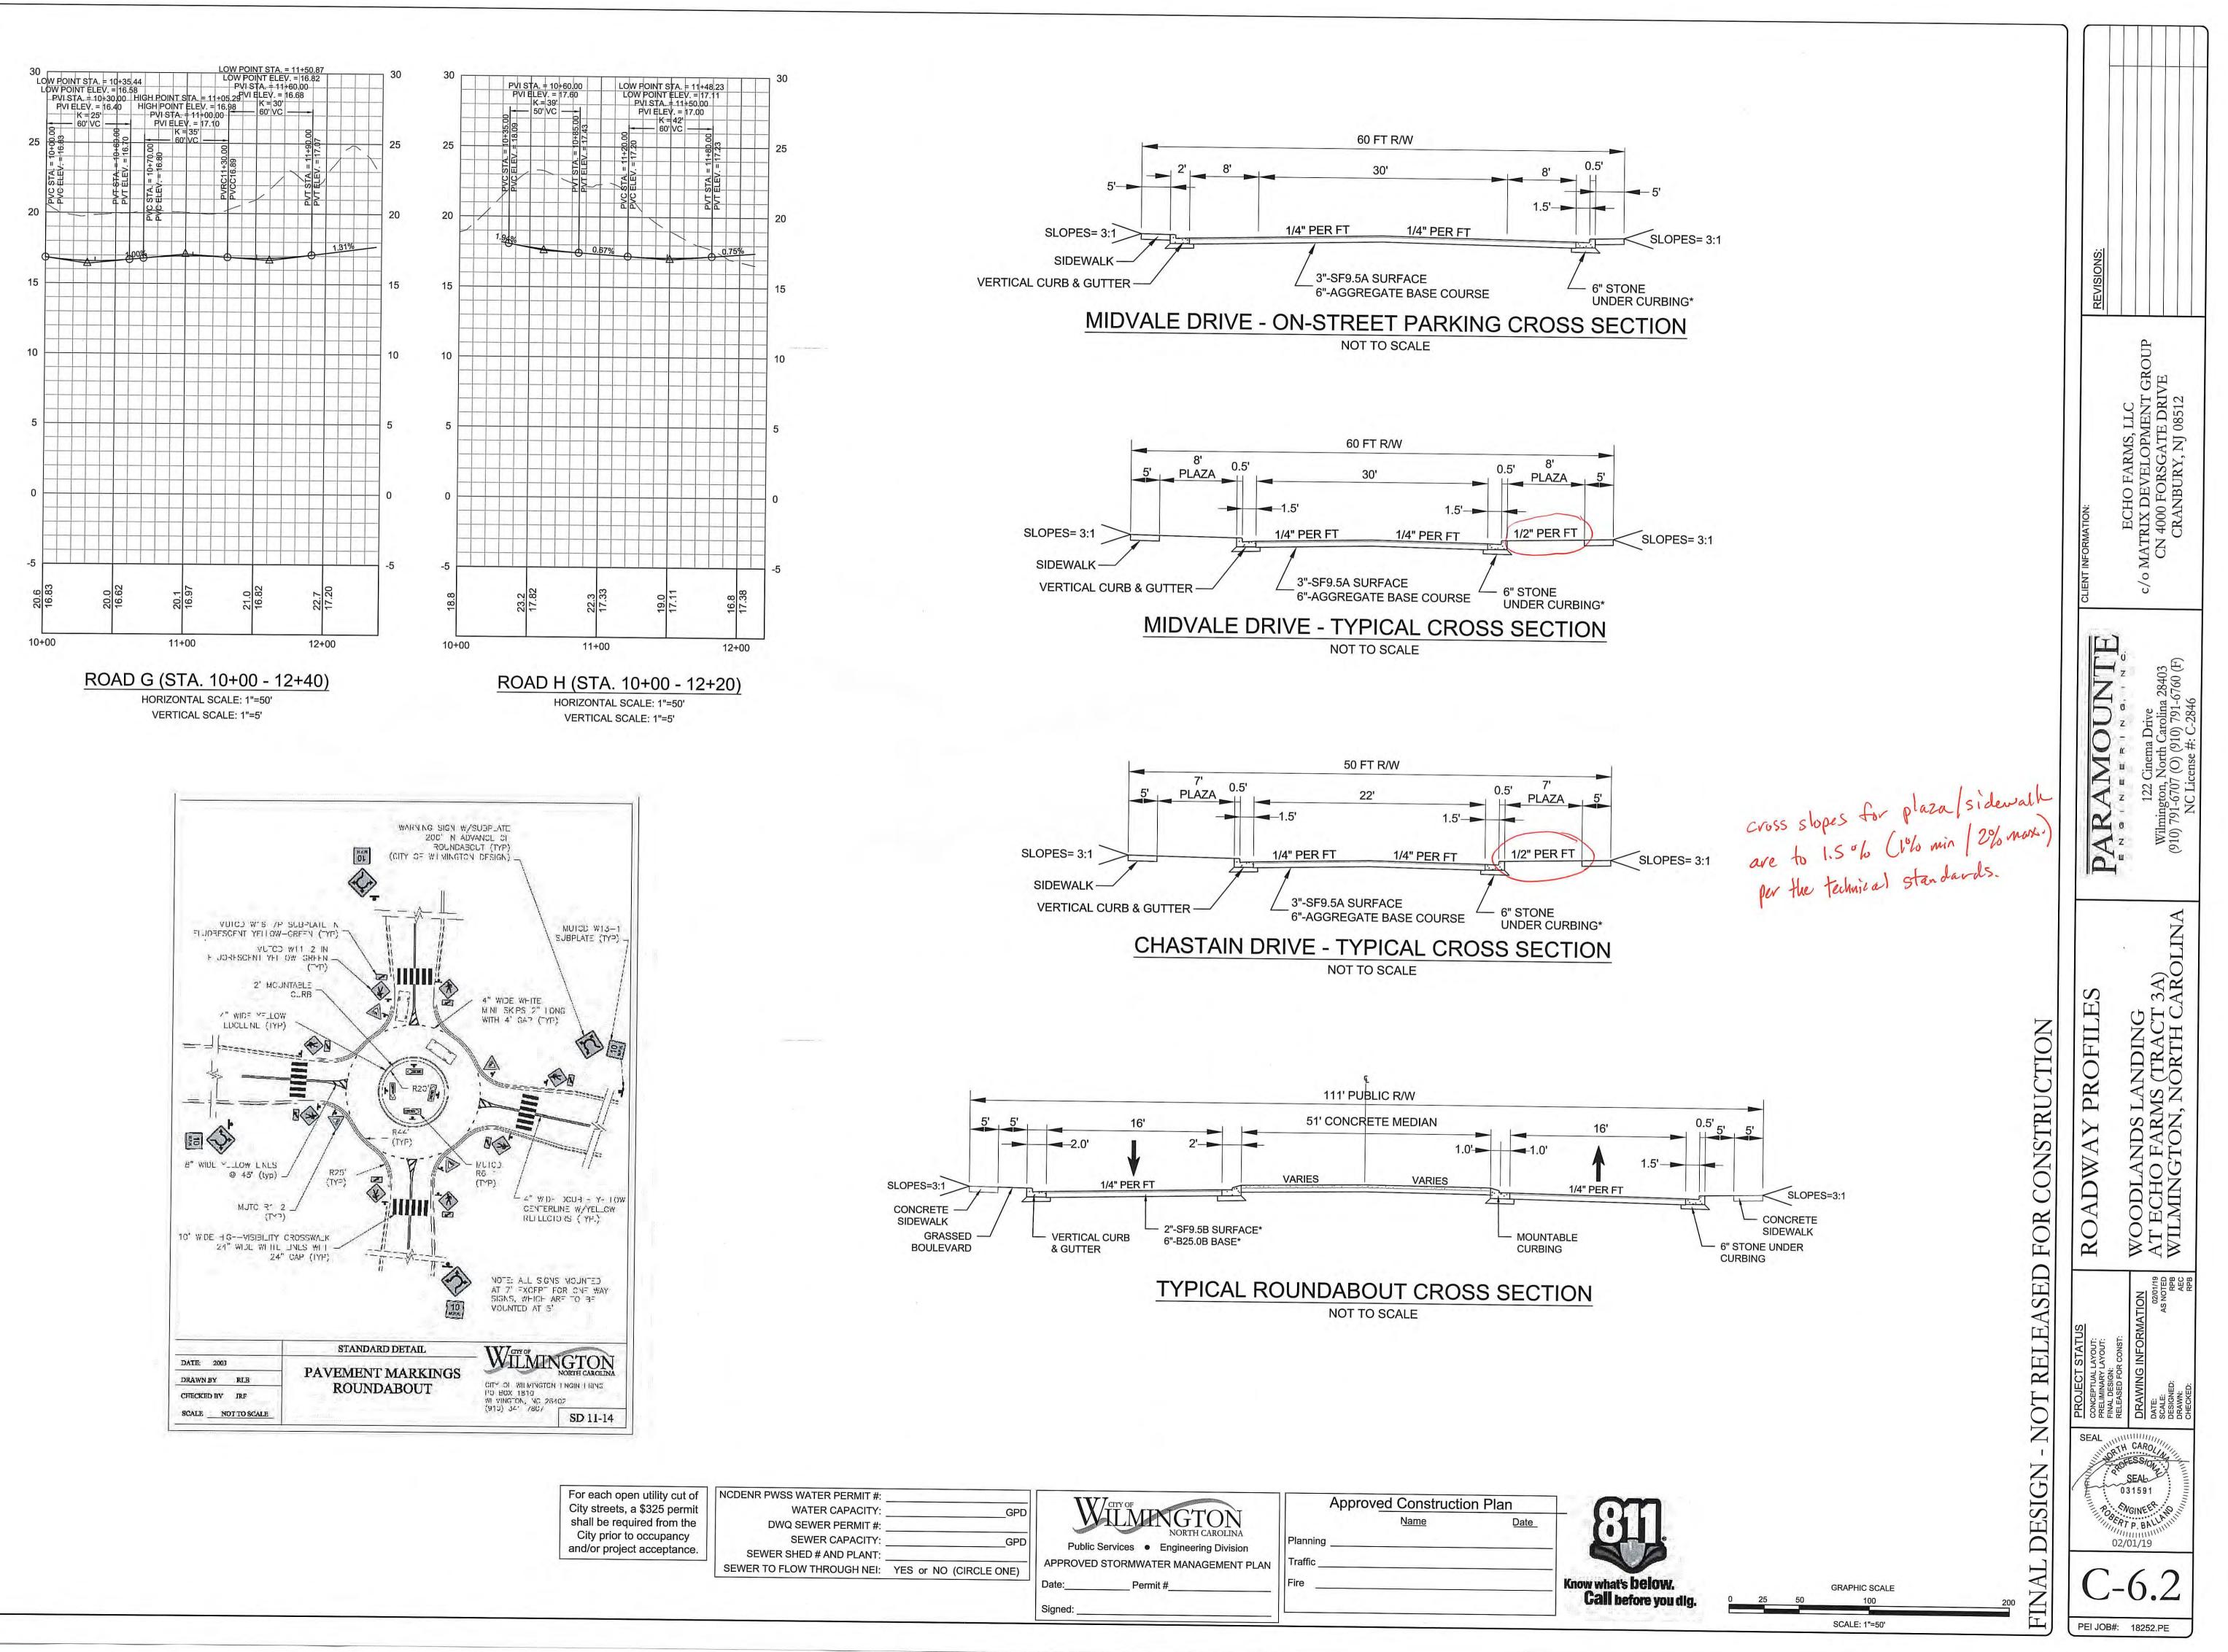

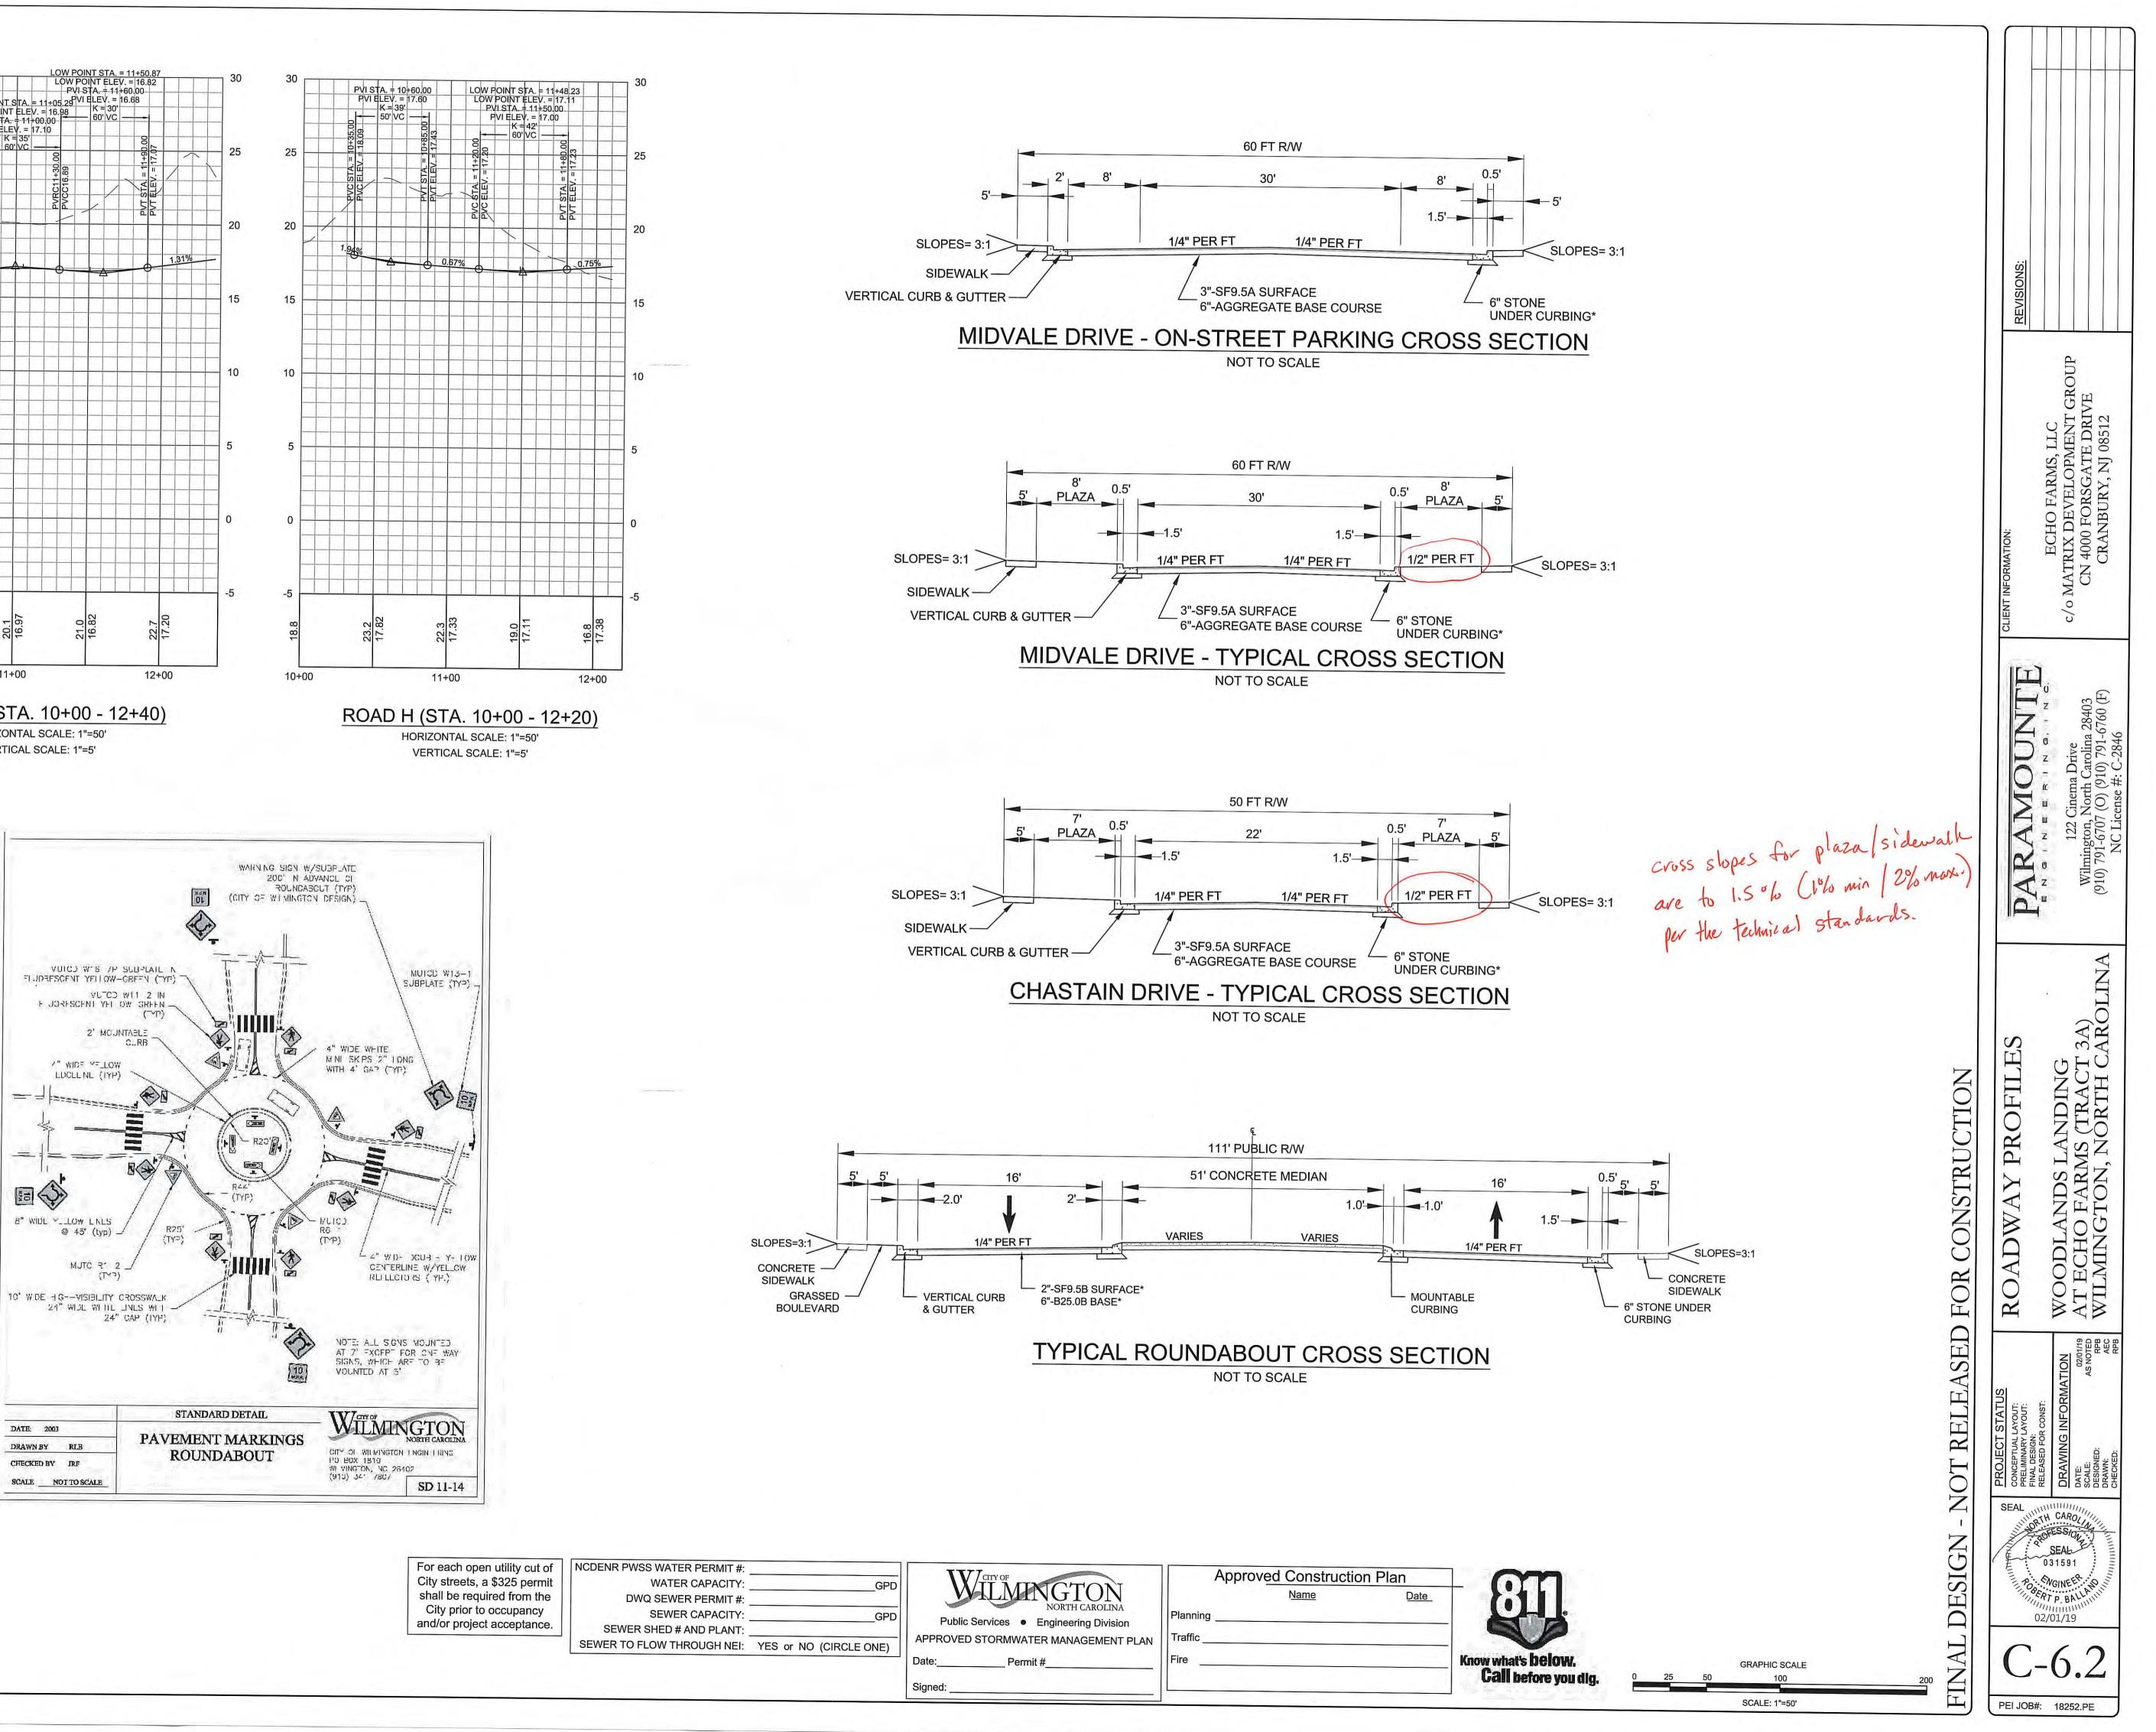

For each open utility cut of	NCDENR PWSS WATER PERMIT #:		TT77	Δρητουος
City streets, a \$325 permit	WATER CAPACITY:	GPD	VII MINGTON	Approved
shall be required from the	DWQ SEWER PERMIT #:		VILIVIINGIOIN NORTH CAROLINA	
City prior to occupancy and/or project acceptance.	SEWER CAPACITY:	GPD	Public Services Engineering Division	Planning
and/or project acceptance.	SEWER SHED # AND PLANT:		APPROVED STORMWATER MANAGEMENT PLAN	Traffic
	SEWER TO FLOW THROUGH NEI:	YES or NO (CIRCLE ONE)	A TROVED STORMWATER MANAGEMENT PLAN	
			Date: Permit #	Fire

PLANT SPECIES, A MINIMUM OF (3) DIVERSE SPECIES, SEE TABLE.

PER 200 SF OF SHELF AREA SHALL BE PLANTED.

