

**LEGEND**

- = REBAR & CAP
- = POWER POLE
- = SANITARY SEWER MANHOLE
- = WETLAND
- = OVERHEAD ELECTRIC LINE
- = CITY OF WILMINGTON CONSERVATION RESOURCE SETBACK LINE
- = SANITARY SEWER MAIN
- = MEAN HIGH WATER
- = AREA OF ENVIRONMENTAL CONCERN
- = 100-YEAR FLOODPLAIN (PRELIMINARY)
- = 100-YEAR FLOODPLAIN (EFFECTIVE)
- = COASTAL MARSH LINE
- = 35' CONSERVATION RESOURCE VEGETATED BUFFER
- = TREE PROTECTION FENCE
- = LIMITS OF DISTURBANCE
- = SILT FENCE
- = TEMPORARY DIVERSION DITCH
- = CAMA CLASSIFICATION BOUNDARY

**TREE LEGEND**

- = CEDAR
- = GUM
- = HOLLY
- = OAK
- = MAPLE
- = PINE
- = TREE TO BE REMOVED

**Approved Construction Plan**

Name \_\_\_\_\_ Date \_\_\_\_\_

Planning \_\_\_\_\_

Traffic \_\_\_\_\_

Fire \_\_\_\_\_

For each open utility cut of City streets, a \$325 permit shall be required from the City prior to occupancy and/or project acceptance.

1 inch

**CITY OF WILMINGTON**  
NORTH CAROLINA

Public Services • Engineering Division


**APPROVED STORMWATER MANAGEMENT PLAN**

Date: \_\_\_\_\_ Permit # \_\_\_\_\_


Signed: \_\_\_\_\_

CONSERVATION RESOURCE	RES	COMM
POCOSIN	25'	50'
SAVANNAH	25'	50'
BRACKISH/SALT MARSH	75'	100'

REFERENCE: LDC 18-341 (d) 5h

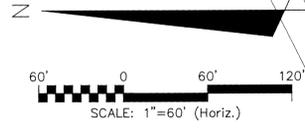


REVNO.	DESCRIPTIONS	DATE
2	SITE PLAN AND STORM DRAINAGE REVISIONS	07/19/2016
1	CFPLA COMMENTS	04/17/2016
0	ISSUED FOR CONSTRUCTION	03/17/2016

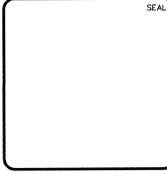

**MCKIM & CREED**

243 North Front Street  
Wilmington, North Carolina 28401  
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**RIVERLIGHTS MARINA VILLAGE  
PHASE 1B**

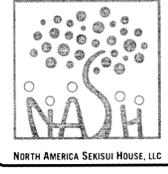**TREE REMOVAL PLAN**


DATE: 17MAR16  
MCE PROJ. # 2735-0124  
DRAWN: ALM  
DESIGNED: NIL  
CHECKED: KCB  
PROJ. MGR: NIL

SCALE  
HORIZONTAL: 1"=60'  
VERTICAL: N/A

MAC FILE NUMBER  
**CX-102**  
DRAWING NUMBER  
**5**

STATUS: **FINAL DESIGN**  
ISSUED FOR CONSTRUCTION

REVISION  
**2**

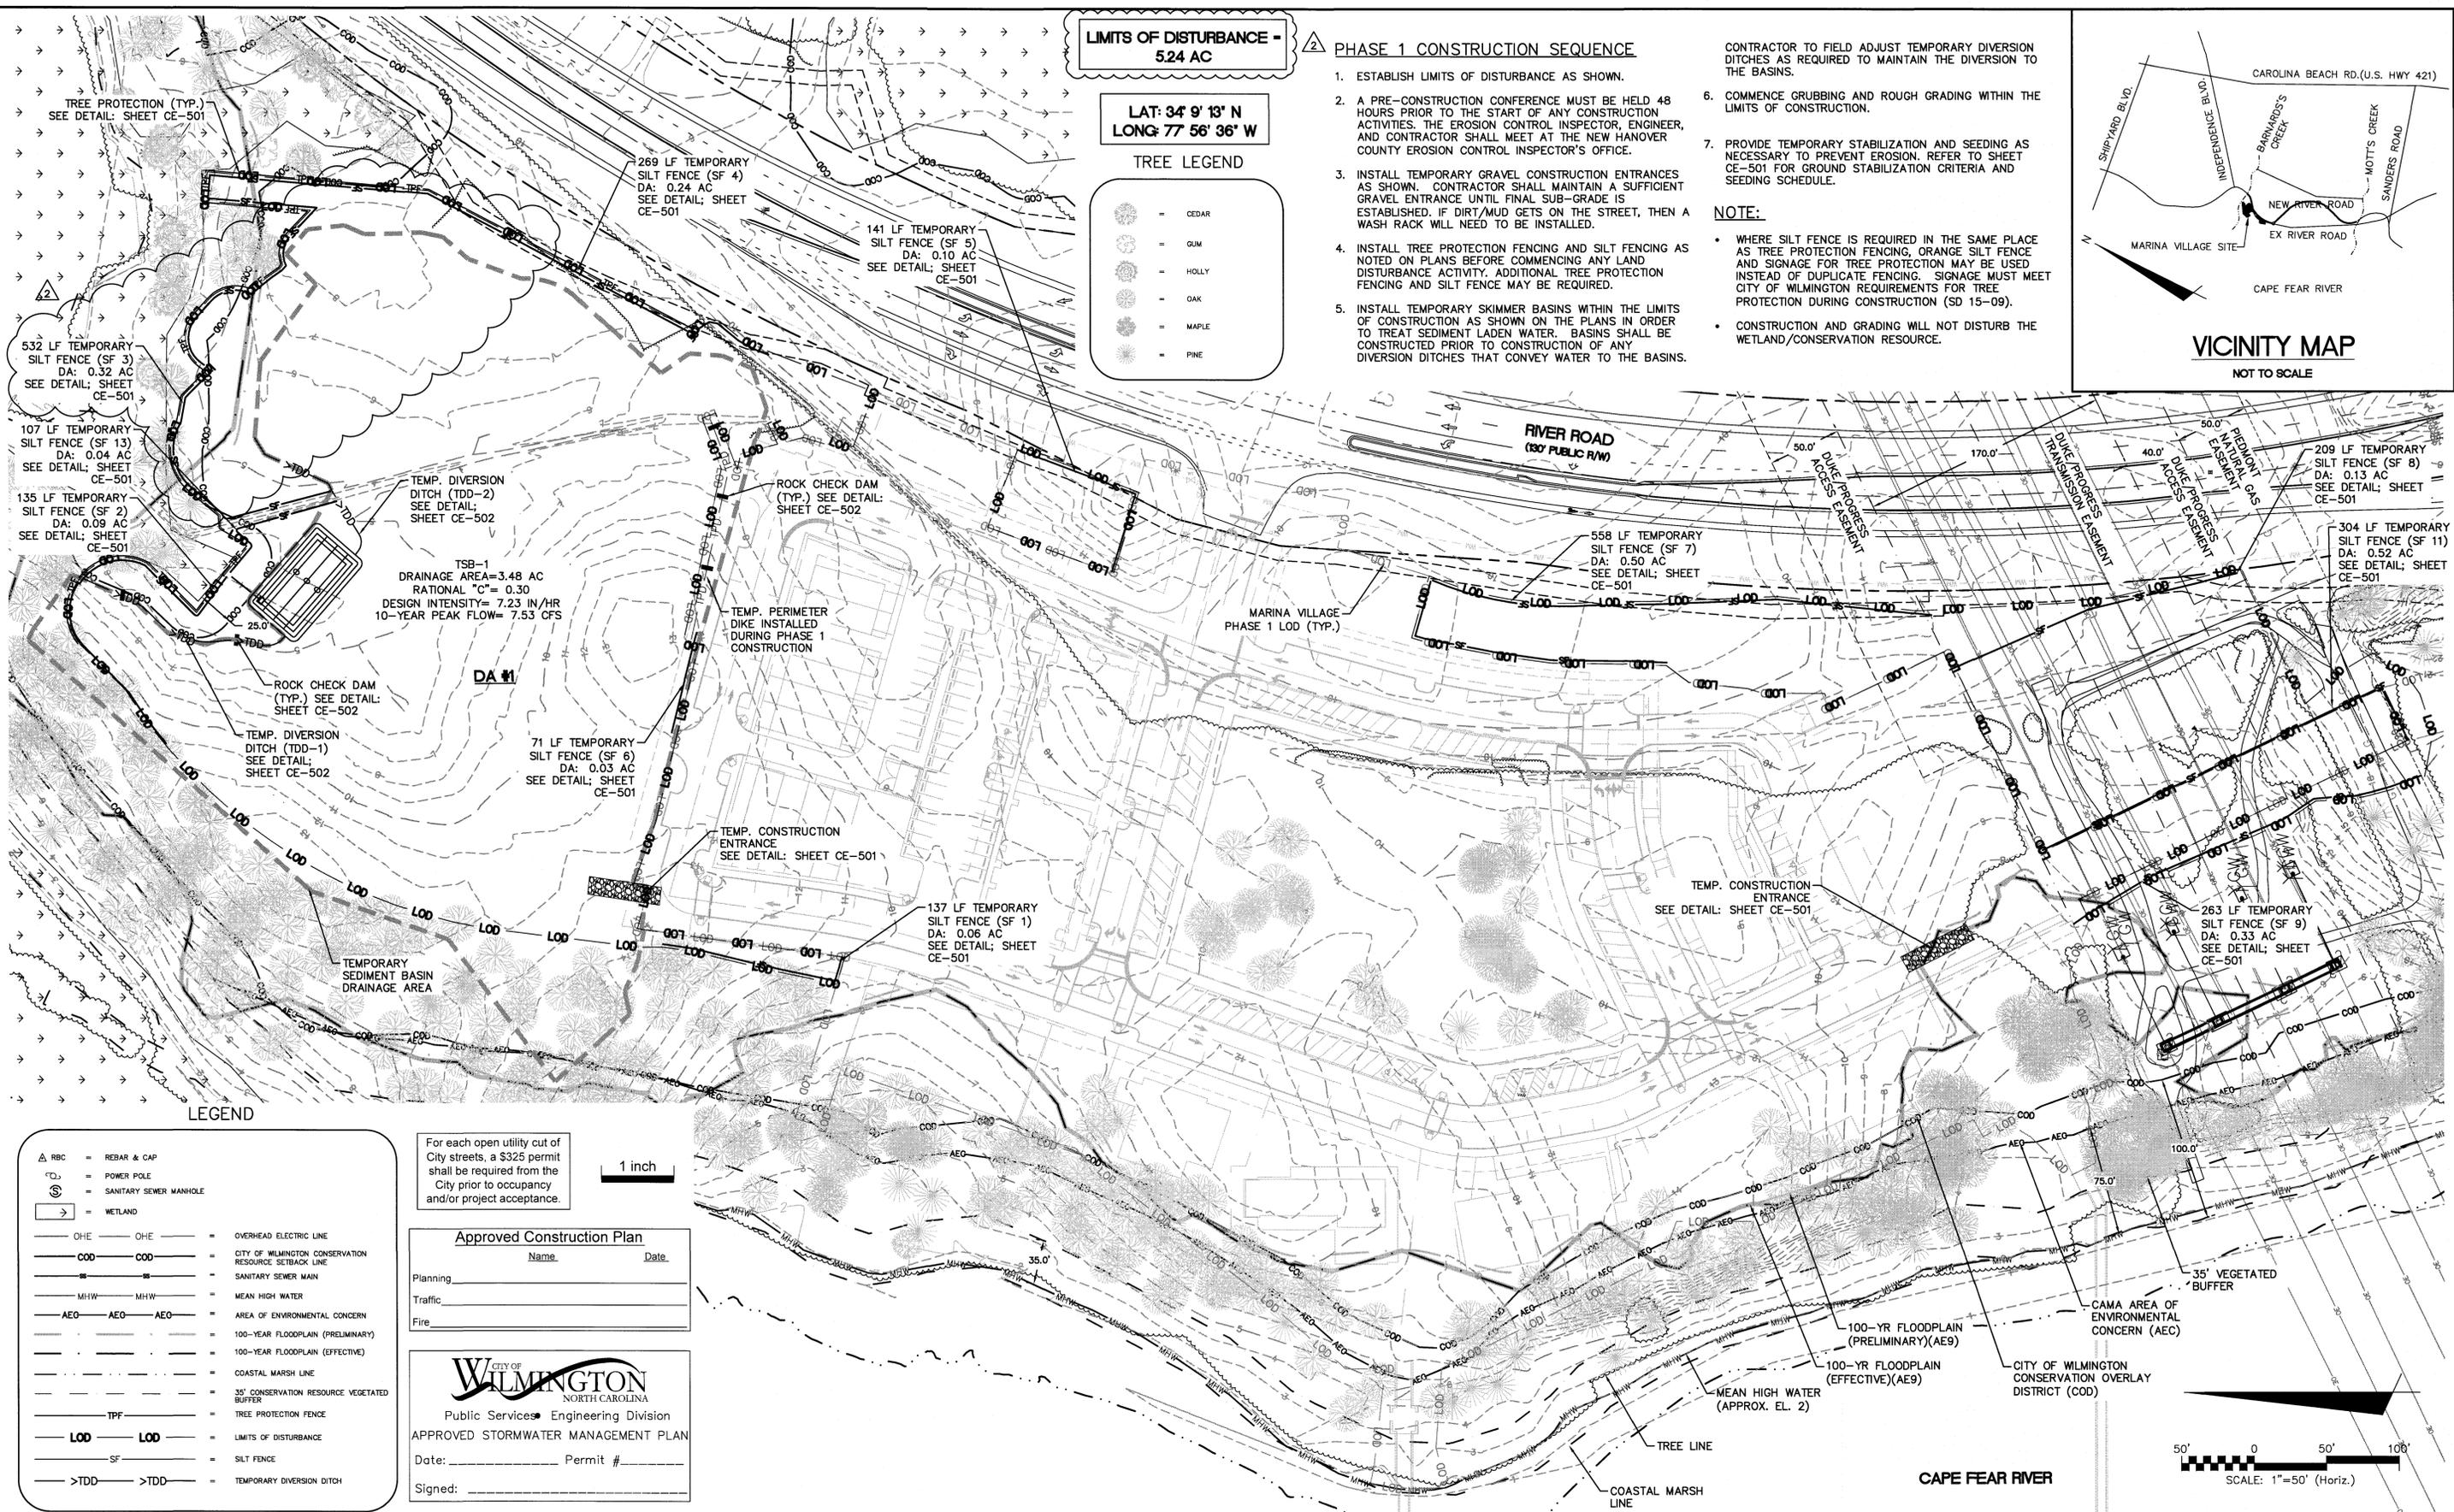

**LIMITS OF DISTURBANCE - 524 AC**

**LAT: 34° 9' 13" N  
LONG: 77° 56' 36" W**

**TREE LEGEND**

- CEDAR
- GUM
- HOLLY
- OAK
- MAPLE
- PINE


**PHASE 1 CONSTRUCTION SEQUENCE**

1. ESTABLISH LIMITS OF DISTURBANCE AS SHOWN.
2. A PRE-CONSTRUCTION CONFERENCE MUST BE HELD 48 HOURS PRIOR TO THE START OF ANY CONSTRUCTION ACTIVITIES. THE EROSION CONTROL INSPECTOR, ENGINEER, AND CONTRACTOR SHALL MEET AT THE NEW HANOVER COUNTY EROSION CONTROL INSPECTOR'S OFFICE.
3. INSTALL TEMPORARY GRAVEL CONSTRUCTION ENTRANCES AS SHOWN. CONTRACTOR SHALL MAINTAIN A SUFFICIENT GRAVEL ENTRANCE UNTIL FINAL SUB-GRADE IS ESTABLISHED. IF DIRTY/MUD GETS ON THE STREET, THEN A WASH RACK WILL BE INSTALLED.
4. INSTALL TREE PROTECTION FENCING AND SILT FENCING AS NOTED ON PLANS BEFORE COMMENCING ANY LAND DISTURBANCE ACTIVITY. ADDITIONAL TREE PROTECTION FENCING AND SILT FENCE MAY BE REQUIRED.
5. INSTALL TEMPORARY SKIMMER BASINS WITHIN THE LIMITS OF CONSTRUCTION AS SHOWN ON THE PLANS IN ORDER TO TREAT SEDIMENT LADEN WATER. BASINS SHALL BE CONSTRUCTED PRIOR TO CONSTRUCTION OF ANY DIVERSION DITCHES THAT CONVEY WATER TO THE BASINS.

6. COMMENCE GRUBBING AND ROUGH GRADING WITHIN THE LIMITS OF CONSTRUCTION.
7. PROVIDE TEMPORARY STABILIZATION AND SEEDING AS NECESSARY TO PREVENT EROSION. REFER TO SHEET CE-501 FOR GROUND STABILIZATION CRITERIA AND SEEDING SCHEDULE.

**NOTE:**

- WHERE SILT FENCE IS REQUIRED IN THE SAME PLACE AS TREE PROTECTION FENCING, ORANGE SILT FENCE AND SIGNAGE FOR TREE PROTECTION MAY BE USED INSTEAD OF DUPLICATE FENCING. SIGNAGE MUST MEET CITY OF WILMINGTON REQUIREMENTS FOR TREE PROTECTION DURING CONSTRUCTION (SD 15-09).
- CONSTRUCTION AND GRADING WILL NOT DISTURB THE WETLAND/CONSERVATION RESOURCE.

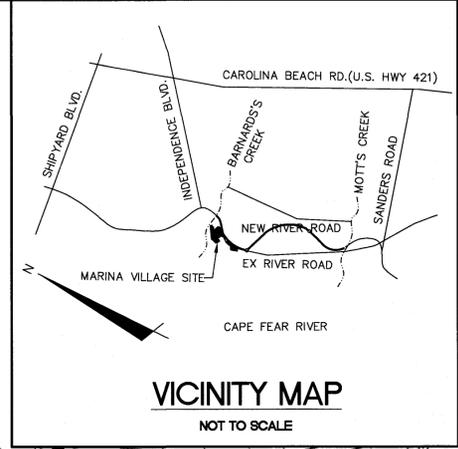

**LEGEND**

	= REBAR & CAP
	= POWER POLE
	= SANITARY SEWER MANHOLE
	= WETLAND
	= OVERHEAD ELECTRIC LINE
	= CITY OF WILMINGTON CONSERVATION RESOURCE STRUCK LINE
	= SANITARY SEWER MAIN
	= MEAN HIGH WATER
	= AREA OF ENVIRONMENTAL CONCERN
	= 100-YEAR FLOODPLAIN (PRELIMINARY)
	= 100-YEAR FLOODPLAIN (EFFECTIVE)
	= COASTAL MARSH LINE
	= 35' CONSERVATION RESOURCE VEGETATED BUFFER
	= TREE PROTECTION FENCE
	= LIMITS OF DISTURBANCE
	= SILT FENCE
	= TEMPORARY DIVERSION DITCH

For each open utility cut of City streets, a \$325 permit shall be required from the City prior to occupancy and/or project acceptance.

1 inch

**Approved Construction Plan**

Name: \_\_\_\_\_ Date: \_\_\_\_\_

Planning: \_\_\_\_\_

Traffic: \_\_\_\_\_


Fire: \_\_\_\_\_

**CITY OF WILMINGTON**  
NORTH CAROLINA  
Public Services Engineering Division  
APPROVED STORMWATER MANAGEMENT PLAN

Date: \_\_\_\_\_ Permit # \_\_\_\_\_

Signed: \_\_\_\_\_

REV. NO.	DESCRIPTIONS	DATE
2	SITE PLAN AND STORM DRAINAGE REVISIONS	07/19/2016
1	OFFICE COMMENTS	04/11/2016
0	ISSUED FOR CONSTRUCTION	03/17/2016

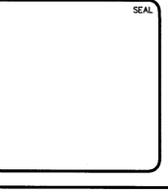

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**RIVERLIGHTS**

NORTH AMERICA SENSUS HOUSE, LLC

**RIVERLIGHTS MARINA VILLAGE  
PHASE 1B  
PHASE 1 SEDIMENT & EROSION CONTROL PLAN**

DATE: 17MAR16	SCALE: 1"=50'	M&C FILE NUMBER: CE-101
M&C PROJ. #: 2735-0124	HORIZONTAL: 1"=50'	DRAWING NUMBER: 6
DRAWN: ALM	VERTICAL: N/A	
DESIGNED: NAL		
CHECKED: KCB		
PROJ. MGR.: NAL		
STATUS: FINAL DESIGN ISSUED FOR CONSTRUCTION		REVISION: 2

S:\27350124 Marina Village\Drawings\Phase 1B\CE-101.dwg, 7/19/2016 4:51:53 PM, A.Meridional



**CONSTRUCTION SEQUENCE:**

**PHASE 2 CONSTRUCTION SEQUENCE**

1. BEGIN PHASE 2 SEDIMENT AND EROSION CONTROL UPON COMPLETION OF CLEARING AND GRUBBING OPERATIONS, ROUGH GRADING OF THE SITE AND INSTALLATION OF THE STORM WATER COLLECTION SYSTEM.
2. MAINTAIN MEASURES FROM PHASE 1 AS SHOWN IN THIS PHASE 2 SEDIMENT AND EROSION CONTROL DRAWING.
3. REMOVE MEASURES FROM PHASE 1 AS SHOWN. THIS INCLUDES TEMPORARY SEDIMENT BASINS AND TEMPORARY DIVERSIONS. STABILIZE THESE AREAS ACCORDING TO THE STABILIZATION MEASURES REQUIRED HEREIN.
4. INSTALL INLET PROTECTION AS SHOWN IN THE PHASE 2 PLAN AND CONSTRUCTION DETAILS.
5. COMPLETE CONSTRUCTION OF THE PROPOSED IMPROVEMENTS.
6. UPON COMPLETION OF CONSTRUCTION, ESTABLISH PERMANENT GROUND COVER AND OVERALL SITE STABILIZATION.
7. REMOVE THE SEDIMENT AND EROSION CONTROL MEASURES.

**LIMITS OF DISTURBANCE - 524 AC**

**LAT: 34° 9' 13" N  
LONG: 77° 56' 36" W**

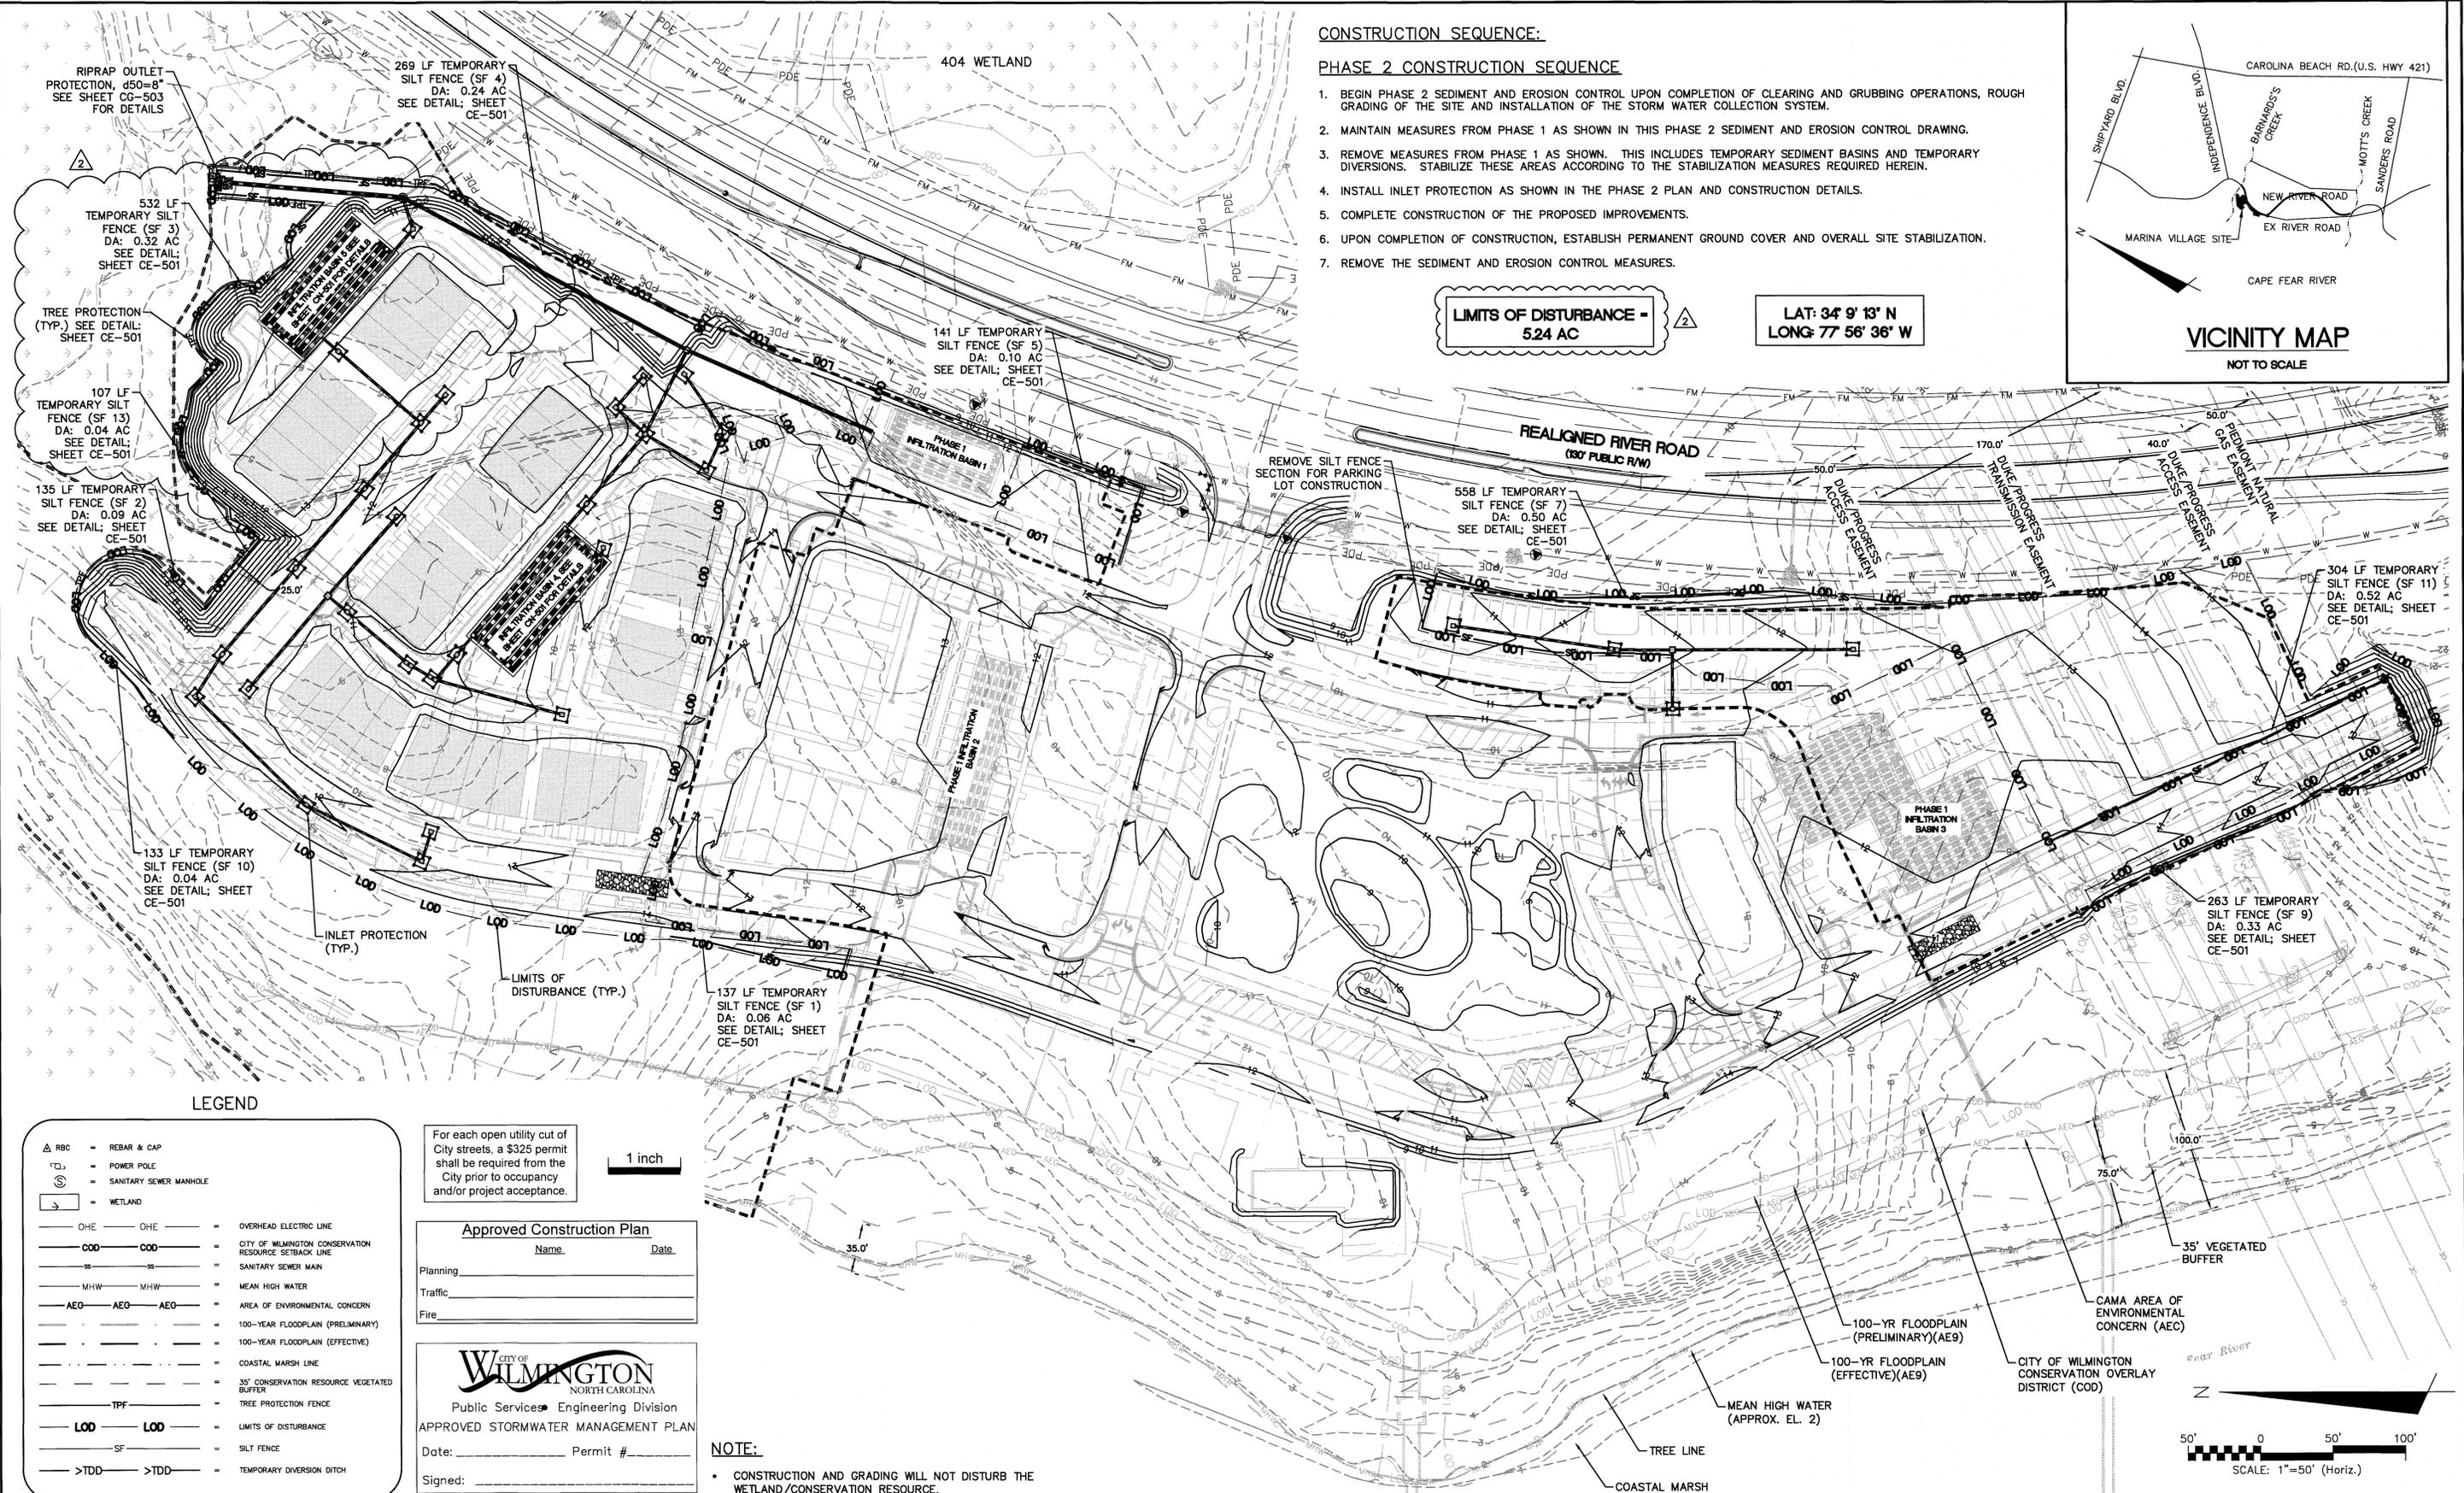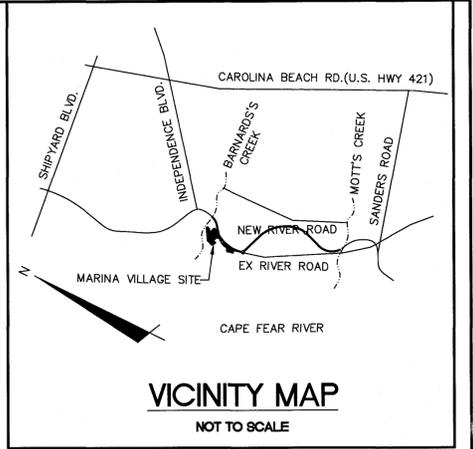

**LEGEND**

	REBAR & CAP
	POWER POLE
	SANITARY SEWER MANHOLE
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	LIMITS OF DISTURBANCE
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	TEMPORARY DIVERSION DITCH

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**Approved Construction Plan**

Name: \_\_\_\_\_ Date: \_\_\_\_\_

Planning: \_\_\_\_\_

Traffic: \_\_\_\_\_

Fire: \_\_\_\_\_

Public Services Engineering Division  
APPROVED STORMWATER MANAGEMENT PLAN


Date: \_\_\_\_\_ Permit #: \_\_\_\_\_

Signed: \_\_\_\_\_

**NOTE:**

- CONSTRUCTION AND GRADING WILL NOT DISTURB THE WETLAND/CONSERVATION RESOURCE.

REV. NO.	DESCRIPTIONS	DATE
1	ISSUED FOR CONSTRUCTION	03/17/2016
2	SITE PLAN AND STORM DRAINAGE REVISIONS	07/19/2016
3	ISSUED FOR CONSTRUCTION	09/11/2016
4	ISSUED FOR CONSTRUCTION	03/17/2016

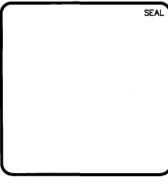

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NORTH AMERICA SEIKISUI HOUSE, LLC

**RIVERLIGHTS MARINA VILLAGE  
PHASE 1B  
PHASE 2 SEDIMENT &  
EROSION CONTROL  
PLAN**

DATE: 17MAR16	SCALE: 1"=50'	MAC FILE NUMBER: CE-102
MCE PROJ. # 2735-0124	HORIZONTAL: 1"=50'	DRAWING NUMBER: 7
DRAWN: ALM	VERTICAL: N/A	REVISION: 0
DESIGNED: NUL		
CHECKED: KGBE		
PROJ. MGR: NUL		
STATUS: FINAL DESIGN		ISSUED FOR CONSTRUCTION

S:\2735\0124 Marina Village\08 Drawings\Phase 1B\CE-102.dwg, 7/19/2016 4:52:22 PM, AMendhall

**NOTE:**

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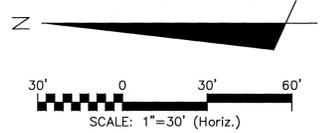
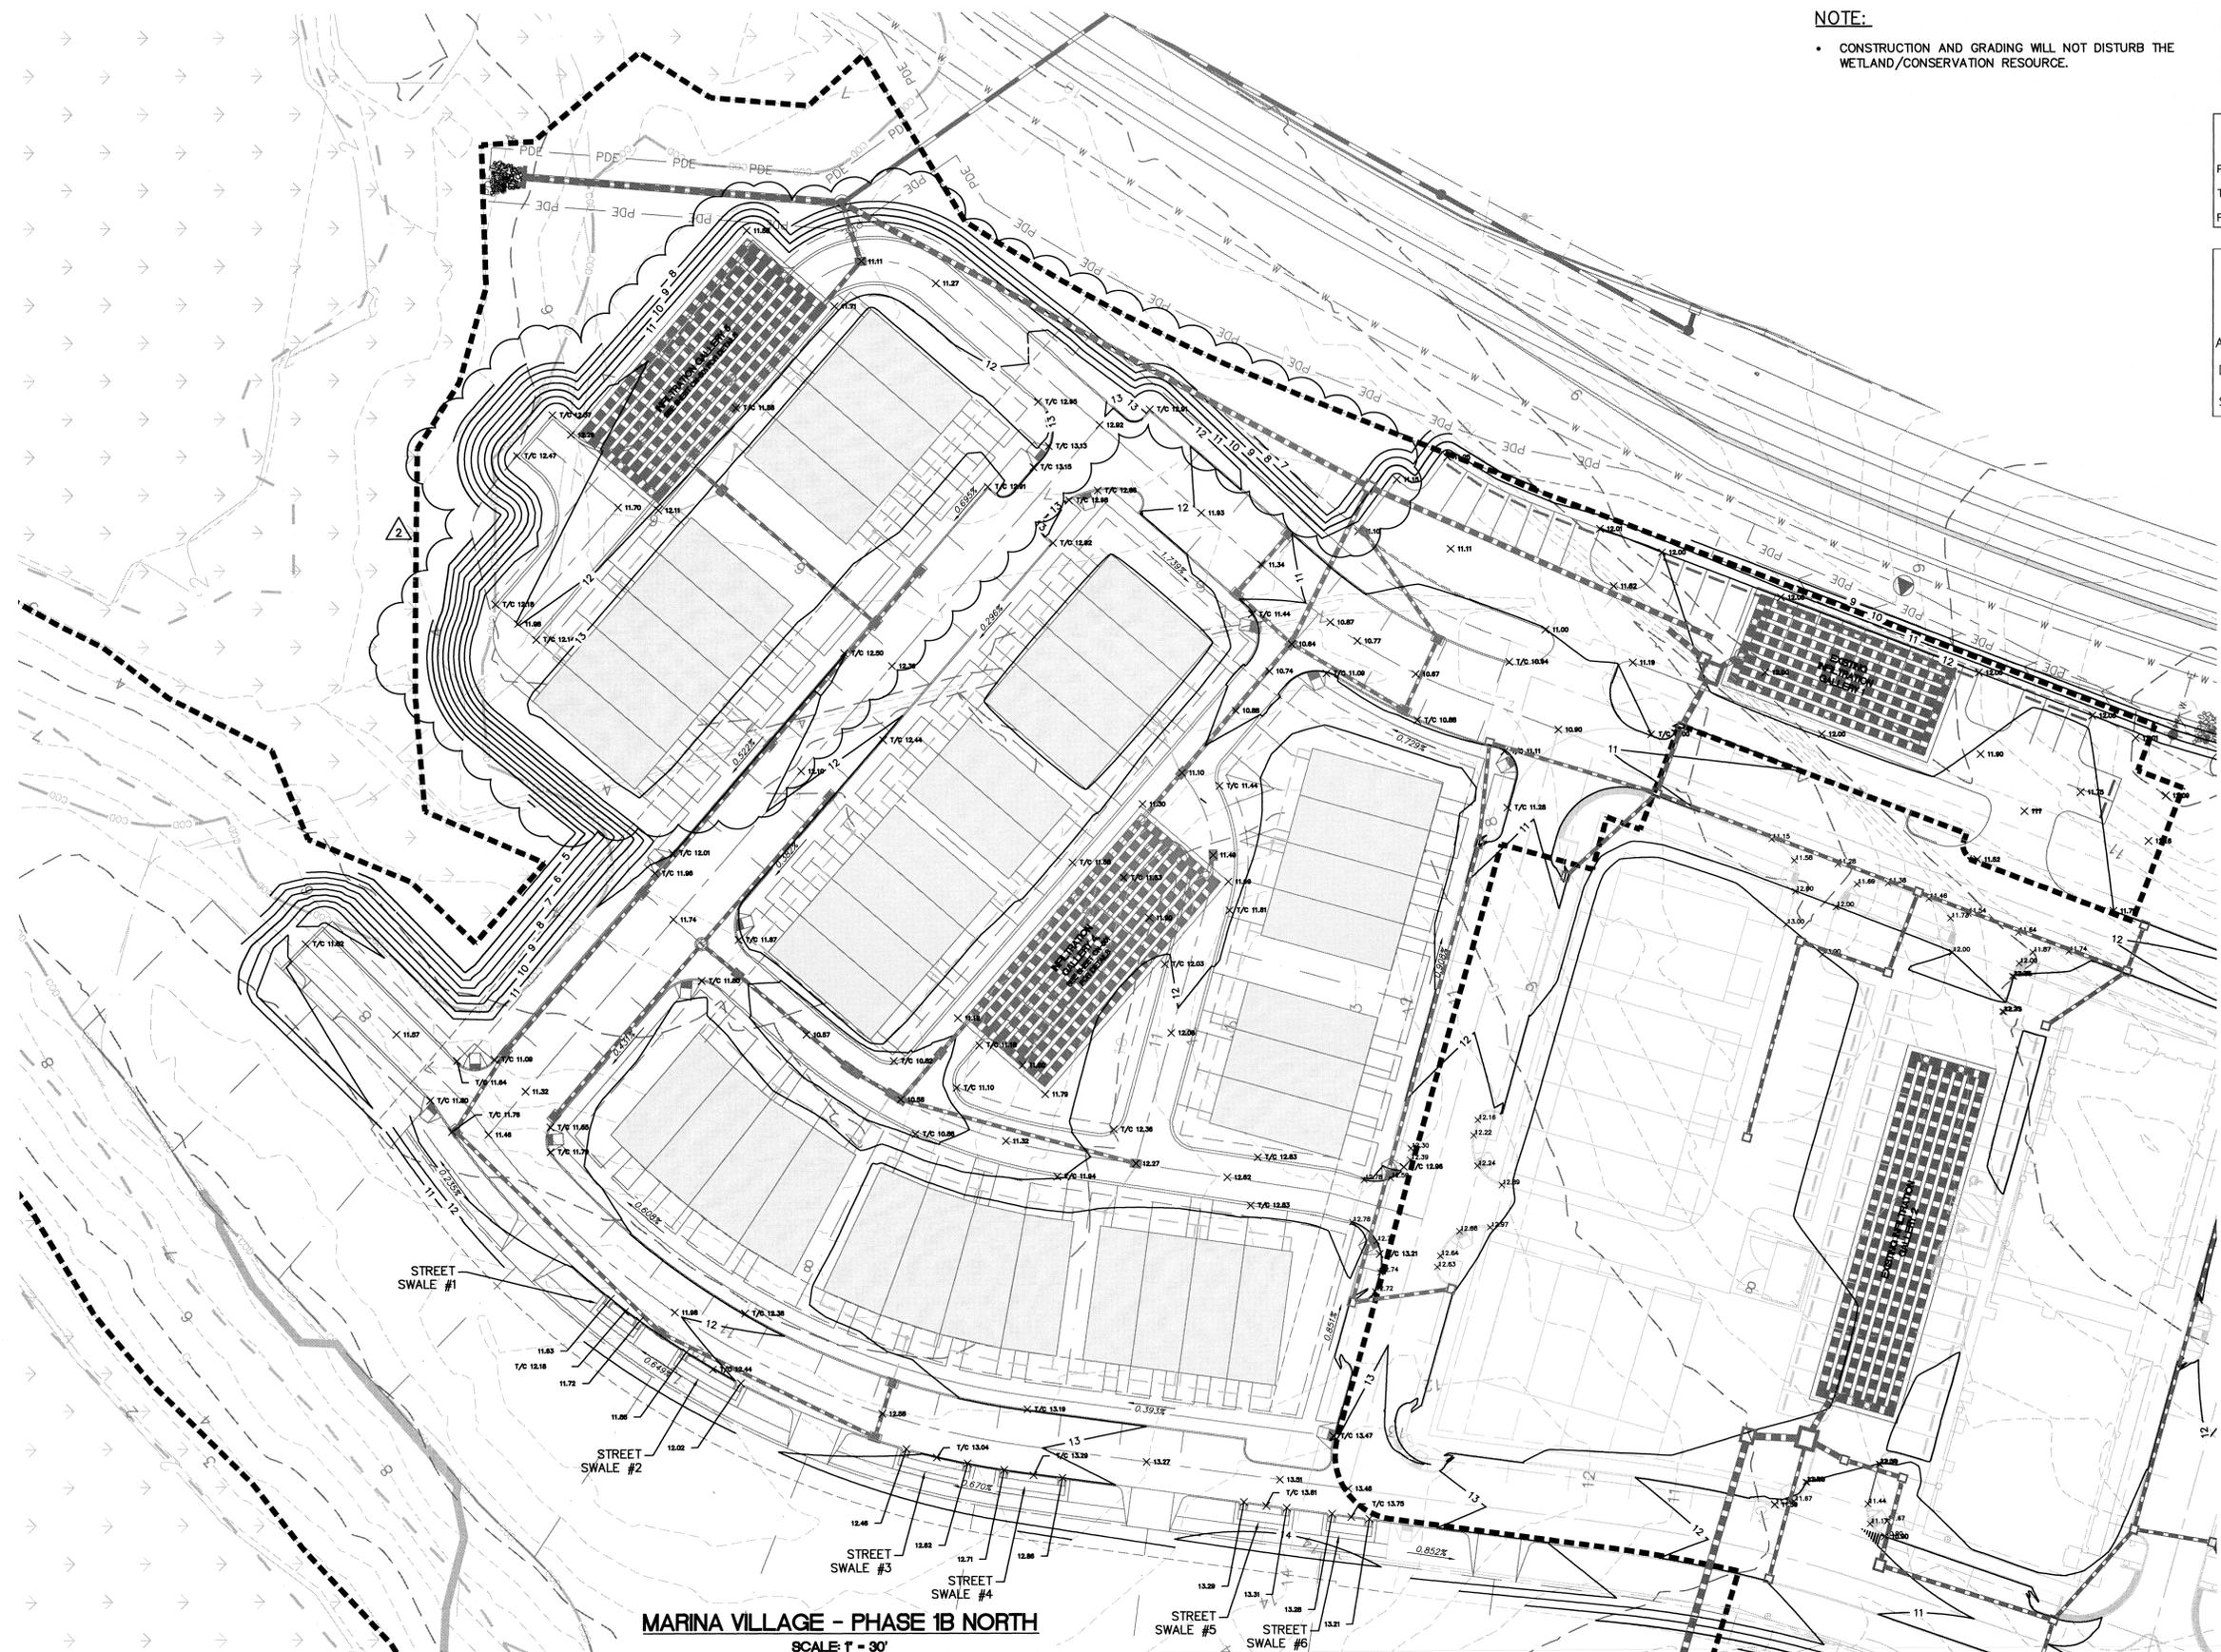
1 inch

**Approved Construction Plan**

Name	Date
Planning	
Traffic	
Fire	




Public Services Engineering Division  
**APPROVED STORMWATER MANAGEMENT PLAN**  
 Date: \_\_\_\_\_ Permit # \_\_\_\_\_  
 Signed: \_\_\_\_\_



**MARINA VILLAGE - PHASE 1B NORTH**  
 SCALE: 1" = 30'

REV. NO.	DESCRIPTIONS / REVISIONS	DATE
2	SITE PLAN AND STORM DRAINAGE REVISIONS	07/19/2016
1	CFPIA COMMENTS	04/11/2016
0	ISSUED FOR CONSTRUCTION	03/17/2016

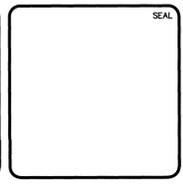

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**RIVERLIGHTS**  
 NORTH AMERICA SEKISUI HOUSE, LLC

**RIVERLIGHTS MARINA VILLAGE  
 PHASE 1B**  
**GRADING PLAN NORTH**

DATE: 17MAR16	SCALE: 1"=30'	MAC FILE NUMBER: CG-101
MCE PROJ. # 2735-0124	HORIZONTAL: 1"=30'	DRAWING NUMBER: 8
DRAWN: ALM	VERTICAL: N/A	
DESIGNED: NAL		
CHECKED: KCBE		
PROJ. MGR.: NAL		
STATUS: FINAL DESIGN		REVISION: 2
ISSUED FOR CONSTRUCTION		

**MATERIALS AND STANDARDS NOTES:**

- ALL CATCH BASINS ARE NCDOT STD 840.01
- ALL DROP INLETS IN TRAFFIC AREAS ARE NCDOT STD 840.35, ALL DROP INLETS IN LANDSCAPE AREAS ARE CITY OF WILMINGTON STD 2-02 & 14-04.
- ALL STORM DRAINAGE PIPING TO BE CLASS III RCP, UNLESS OTHERWISE NOTED.



STRUCTURE TABLE - STRM - 14-15		STRUCTURE TABLE - STRM - 14-15		STRUCTURE TABLE - STRM - 14-15		STRUCTURE TABLE - STRM - 14-15	
STR. NAME	DETAILS	STR. NAME	DETAILS	STR. NAME	DETAILS	STR. NAME	DETAILS
CB-401	RIM = 12.33 SUMP = 9.85 INV OUT = 9.85W	CB-417	RIM = 10.39 SUMP = 7.54 INV IN = 7.54SE INV OUT = 7.54NE	DI-412A	RIM = 10.48 SUMP = 7.23 INV IN = 7.23NE INV OUT = 7.23SW	DI-424	RIM = 12.50 SUMP = 6.03 INV IN = 7.03SW INV OUT = 7.03NE
CB-402	RIM = 12.39 SUMP = 9.74 INV IN = 9.74E INV OUT = 9.74NE	CB-418	RIM = 10.37 SUMP = 7.66 INV IN = 7.66NE INV OUT = 7.66NW	DI-413	RIM = 10.58 SUMP = 7.16 INV IN = 7.16NE INV OUT = 7.16SE	EW-4	RIM = 7.00 INV IN = 3.89S
CB-403	RIM = 11.80 SUMP = 9.30 INV IN = 9.30SW INV OUT = 9.30NE	CB-419	RIM = 11.06 SUMP = 7.48 INV IN = 7.48SE INV OUT = 7.48SW	DI-413A	RIM = 10.55 SUMP = 7.16 INV IN = 7.16NE INV OUT = 7.16SW	I-4A	RIM = 11.07 SUMP = 7.00 INV IN = 7.00NW
CB-404	RIM = 11.28 SUMP = 8.76 INV IN = 8.76SW INV OUT = 8.76SE	CB-420	RIM = 11.04 SUMP = 7.63 INV OUT = 7.63NW	DI-414	RIM = 12.27 SUMP = 7.61 INV OUT = 7.61N	I-4B	RIM = 11.58 SUMP = 7.00 INV IN = 7.00E
CB-405	RIM = 11.04 SUMP = 8.13 INV IN = 8.13NW INV OUT = 8.13SE	CB-424	RIM = 12.22 SUMP = 7.29 INV OUT = 7.29NW	DI-415	RIM = 11.49 SUMP = 6.08 INV OUT = 7.08W	I-4C	RIM = 11.25 SUMP = 7.00 INV IN = 7.00SE
CB-405A	RIM = 11.03 SUMP = 8.02 INV OUT = 8.02SE	DI-407	RIM = 11.11 SUMP = 6.04 INV OUT = 6.04E INV OUT = 7.10NW	DI-416	RIM = 10.64 SUMP = 6.34 INV IN = 7.34NE INV IN = 7.34SW INV OUT = 7.34SE	I-5A	RIM = 11.81 SUMP = 7.00 INV IN = 7.00SW
CB-406	RIM = 11.43 SUMP = 7.74 INV IN = 7.74NW INV OUT = 7.74SE	DI-408	RIM = 12.09 SUMP = 7.20 INV IN = 7.20NW INV IN = 7.20NE INV OUT = 7.20NE	DI-421	RIM = 11.10 SUMP = 6.09 INV IN = 7.09SE INV OUT = 7.09NW	JB-407A	RIM = 9.85 SUMP = 4.46 INV IN = 4.46SW INV OUT = 4.46N
CB-409	RIM = 11.80 SUMP = 7.38 INV IN = 7.38NW INV OUT = 7.38SE	DI-411	RIM = 11.11 SUMP = 7.50 INV IN = 7.50NE INV OUT = 7.50SW	DI-422	RIM = 11.10 SUMP = 6.85 INV OUT = 7.85SW	JB-416A	RIM = 9.56 SUMP = 7.00 INV IN = 7.00NW INV IN = 7.00SW INV OUT = 7.00NE
CB-410	RIM = 11.82 SUMP = 7.95 INV OUT = 7.95NW	DI-412	RIM = 10.48 SUMP = 7.23 INV IN = 7.23NE INV OUT = 7.23SW	DI-423	RIM = 10.91 SUMP = 6.07 INV IN = 7.07NW INV OUT = 7.07SE		

STRUCTURE TABLE - STRM - 13B		STRUCTURE TABLE - STRM - 14-15	
STR. NAME	DETAILS	STR. NAME	DETAILS
DI-501	RIM = 12.11 SUMP = 7.57 INV OUT = 8.57N	SDMH-2	RIM = 10.92 SUMP = 6.95 INV IN = 7.95N INV IN = 7.95S INV OUT = 7.95W
DI-502	RIM = 10.75 SUMP = 7.14 INV IN = 8.14N INV OUT = 8.14S	SDMH-1	RIM = 11.46 SUMP = 7.59 INV IN = 7.59SE INV IN = 7.59NW INV OUT = 7.59SW
DI-502A	RIM = 10.75 SUMP = 7.14 INV IN = 8.14N INV OUT = 8.14S		
DI-503	RIM = 10.86 SUMP = 7.54 INV OUT = 8.54S		
EX. CB-318	RIM = 10.48 SUMP = 7.76 INV IN = 7.76E		

STORM DRAINAGE PIPE DATA TABLE - STRM - 14-15							
FROM	TO	LENGTH	SIZE	PIPE TYPE	SLOPE	UPSTREAM INVERT	DOWNSTREAM INVERT
SDMH-1	DI-411	17.50'	15"	RCP	0.51%	7.59'	7.50'
JB-416A	JB-407A	222.59'	24"	RCP	1.14%	7.00'	4.46'
JB-407A	EW-4	118.34'	30"	RCP	0.48%	4.46'	3.89'
DI-424	I-5A	15.00'	15"	CAP	0.22%	7.03'	7.00'
DI-423	I-4A	16.00'	15"	CAP	0.42%	7.07'	7.00'
DI-422	CB-418	48.51'	15"	CL IV RCP	0.40%	7.85'	7.66'
DI-421	I-4C	21.30'	18"	CAP	0.40%	7.09'	7.00'
DI-416	JB-416A	64.81'	18"	DUAL 18" RCP	0.52%	7.34'	7.00'
DI-416	DI-421	62.85'	18"	RCP	0.40%	7.34'	7.09'
DI-415	I-4B	6.39'	15"	CAP	1.25%	7.08'	7.00'
DI-414	DI-413	90.58'	15"	RCP	0.50%	7.61'	7.16'
DI-413A	DI-413	4.01'	15"	RCP	0.00%	7.16'	7.16'
DI-413	DI-423	22.64'	15"	RCP	0.42%	7.16'	7.07'
DI-412A	DI-413A	15.31'	15"	RCP	0.46%	7.23'	7.16'
DI-412	DI-412A	3.97'	15"	RCP	0.00%	7.23'	7.23'
DI-411	DI-412	53.12'	15"	RCP	0.51%	7.50'	7.23'
DI-408	DI-424	75.34'	15"	RCP	0.22%	7.20'	7.03'
DI-407	JB-407A	22.85'	18"	RCP	2.54%	6.04'	5.46'
DI-407	I-5B	20.91'	18"	CAP	0.50%	7.10'	7.00'
CB-424	DI-408	25.50'	15"	RCP	0.34%	7.29'	7.20'
CB-420	CB-419	29.30'	15"	RCP	0.50%	7.63'	7.48'

STORM DRAINAGE PIPE DATA TABLE - STRM - 14-15							
FROM	TO	LENGTH	SIZE	PIPE TYPE	SLOPE	UPSTREAM INVERT	DOWNSTREAM INVERT
CB-419	DI-416	27.40'	15"	RCP	0.50%	7.48'	7.34'
CB-418	CB-417	29.30'	15"	CL IV RCP	0.40%	7.66'	7.54'
CB-417	DI-416	48.99'	15"	CL IV RCP	0.40%	7.54'	7.34'
CB-410	SDMH-1	72.71'	15"	RCP	0.50%	7.95'	7.59'
CB-409	DI-408	59.62'	15"	RCP	0.30%	7.38'	7.20'
CB-406	CB-409	72.73'	15"	RCP	0.50%	7.74'	7.38'
CB-405A	SDMH-1	84.00'	15"	RCP	0.51%	8.02'	7.59'
CB-405	CB-406	78.03'	15"	RCP	0.50%	8.13'	7.74'
CB-404	CB-405	34.46'	15"	CL IV RCP	1.83%	8.76'	8.13'
CB-403	CB-404	106.80'	15"	CL IV RCP	0.50%	9.30'	8.76'
CB-402	CB-403	88.45'	15"	CL IV RCP	0.50%	9.74'	9.30'
CB-401	CB-402	21.30'	15"	CL IV RCP	0.50%	9.85'	9.74'
	JB-416A	139.40'	24"	RCP	0.50%	7.70'	7.00'

STORM DRAINAGE PIPE DATA TABLE - STRM - 13B							
FROM	TO	LENGTH	SIZE	PIPE TYPE	SLOPE	UPSTREAM INVERT	DOWNSTREAM INVERT
SDMH-2	EX. CB-318	40.27'	15"	RCP	0.48%	7.95'	7.76'
DI-503	DI-502A	109.99'	15"	CL IV RCP	0.36%	8.54'	8.14'
DI-502A	DI-502	4.01'	15"	CL IV RCP	0.00%	8.14'	8.14'
DI-502	SDMH-2	37.99'	15"	CL IV RCP	0.50%	8.14'	7.95'
DI-501	SDMH-2	124.80'	15"	RCP	0.50%	8.57'	7.95'

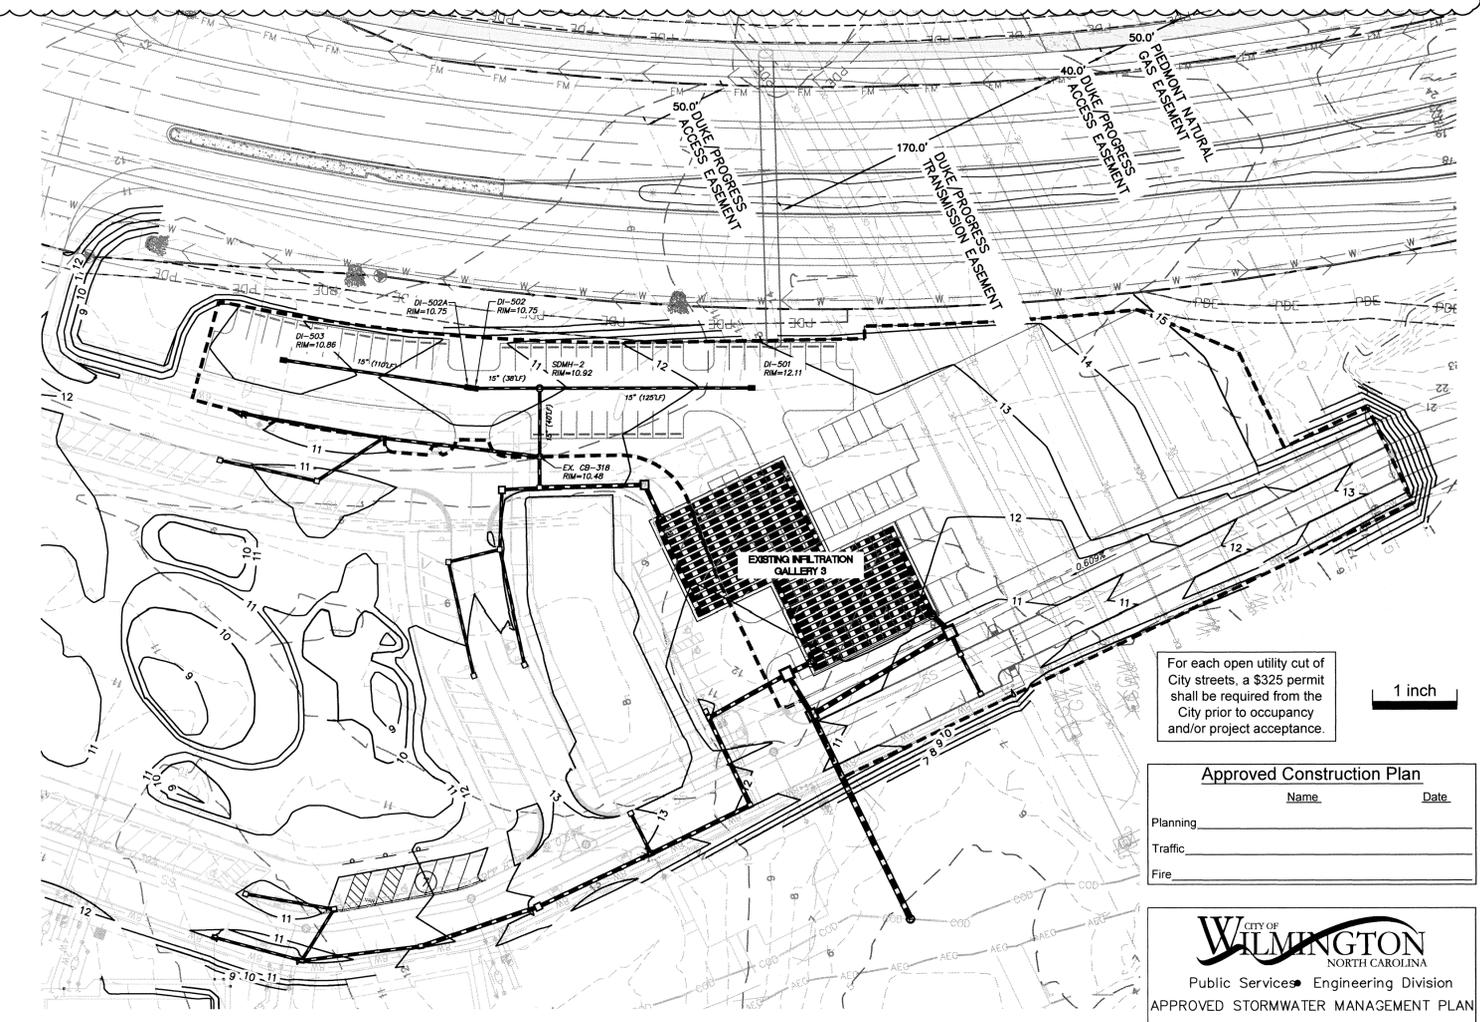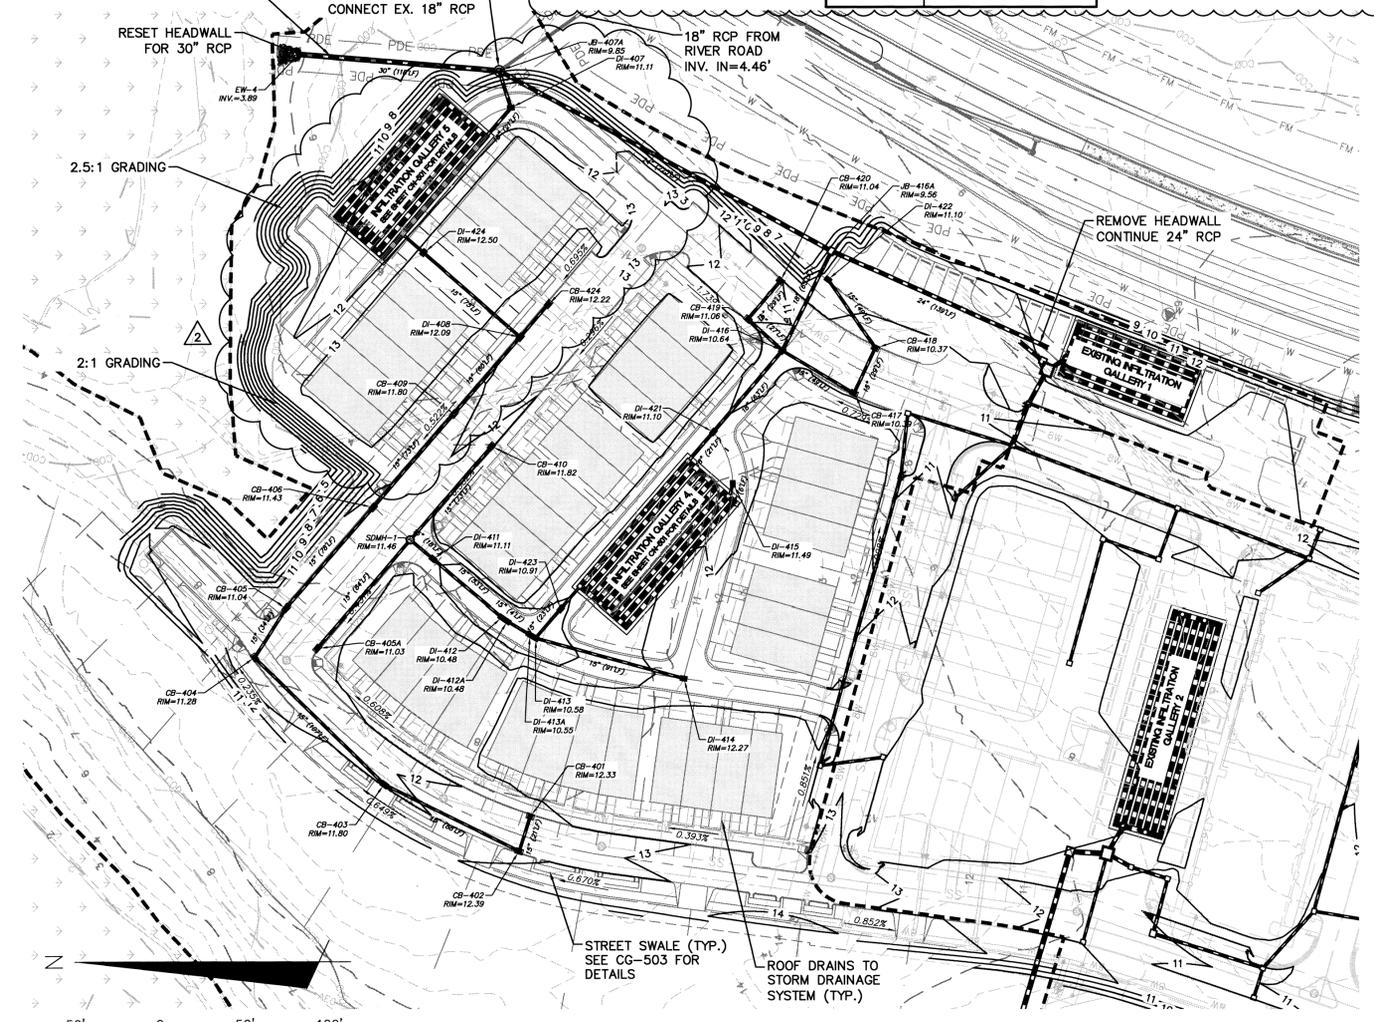

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**Approved Construction Plan**

Name: \_\_\_\_\_ Date: \_\_\_\_\_

Planning: \_\_\_\_\_

Traffic: \_\_\_\_\_



Fire: \_\_\_\_\_

**CITY OF WILMINGTON**  
NORTH CAROLINA  
Public Services Engineering Division  
APPROVED STORMWATER MANAGEMENT PLAN

Date: \_\_\_\_\_ Permit # \_\_\_\_\_

Signed: \_\_\_\_\_

REVNO.	DESCRIPTIONS	DATE
2	SITE PLAN AND STORM DRAINAGE REVISIONS	07/19/2016
1	CPLA COMMENTS	04/11/2016
0	ISSUED FOR CONSTRUCTION	03/17/2016

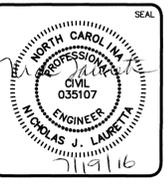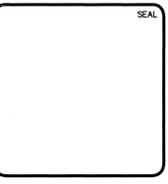

**MCKIM & CREED**

243 North Front Street  
Wilmington, North Carolina 28401  
Phone: (910)343-1048, Fax: (910)251-8282  
License: F-1222  
www.mckimcreed.com

**RIVERLIGHTS**

NORTH AMERICA SEKISUI HOUSE, LLC

**RIVERLIGHTS MARINA VILLAGE PHASE 1B**

**STORM DRAINAGE PLAN**




DATE: 17MAR16  
MCE PROJ. #: 2735-0124  
DRAWN: ALM  
DESIGNED: NJL  
CHECKED: KCBE  
PROJ. MGR.: NJL

SCALE: HORIZONTAL: 1"=50'  
VERTICAL: N/A

MAC FILE NUMBER: CG-103  
DRAWING NUMBER: 10

STATUS: FINAL DESIGN  
ISSUED FOR CONSTRUCTION

REVISION: 2

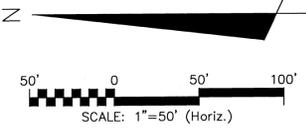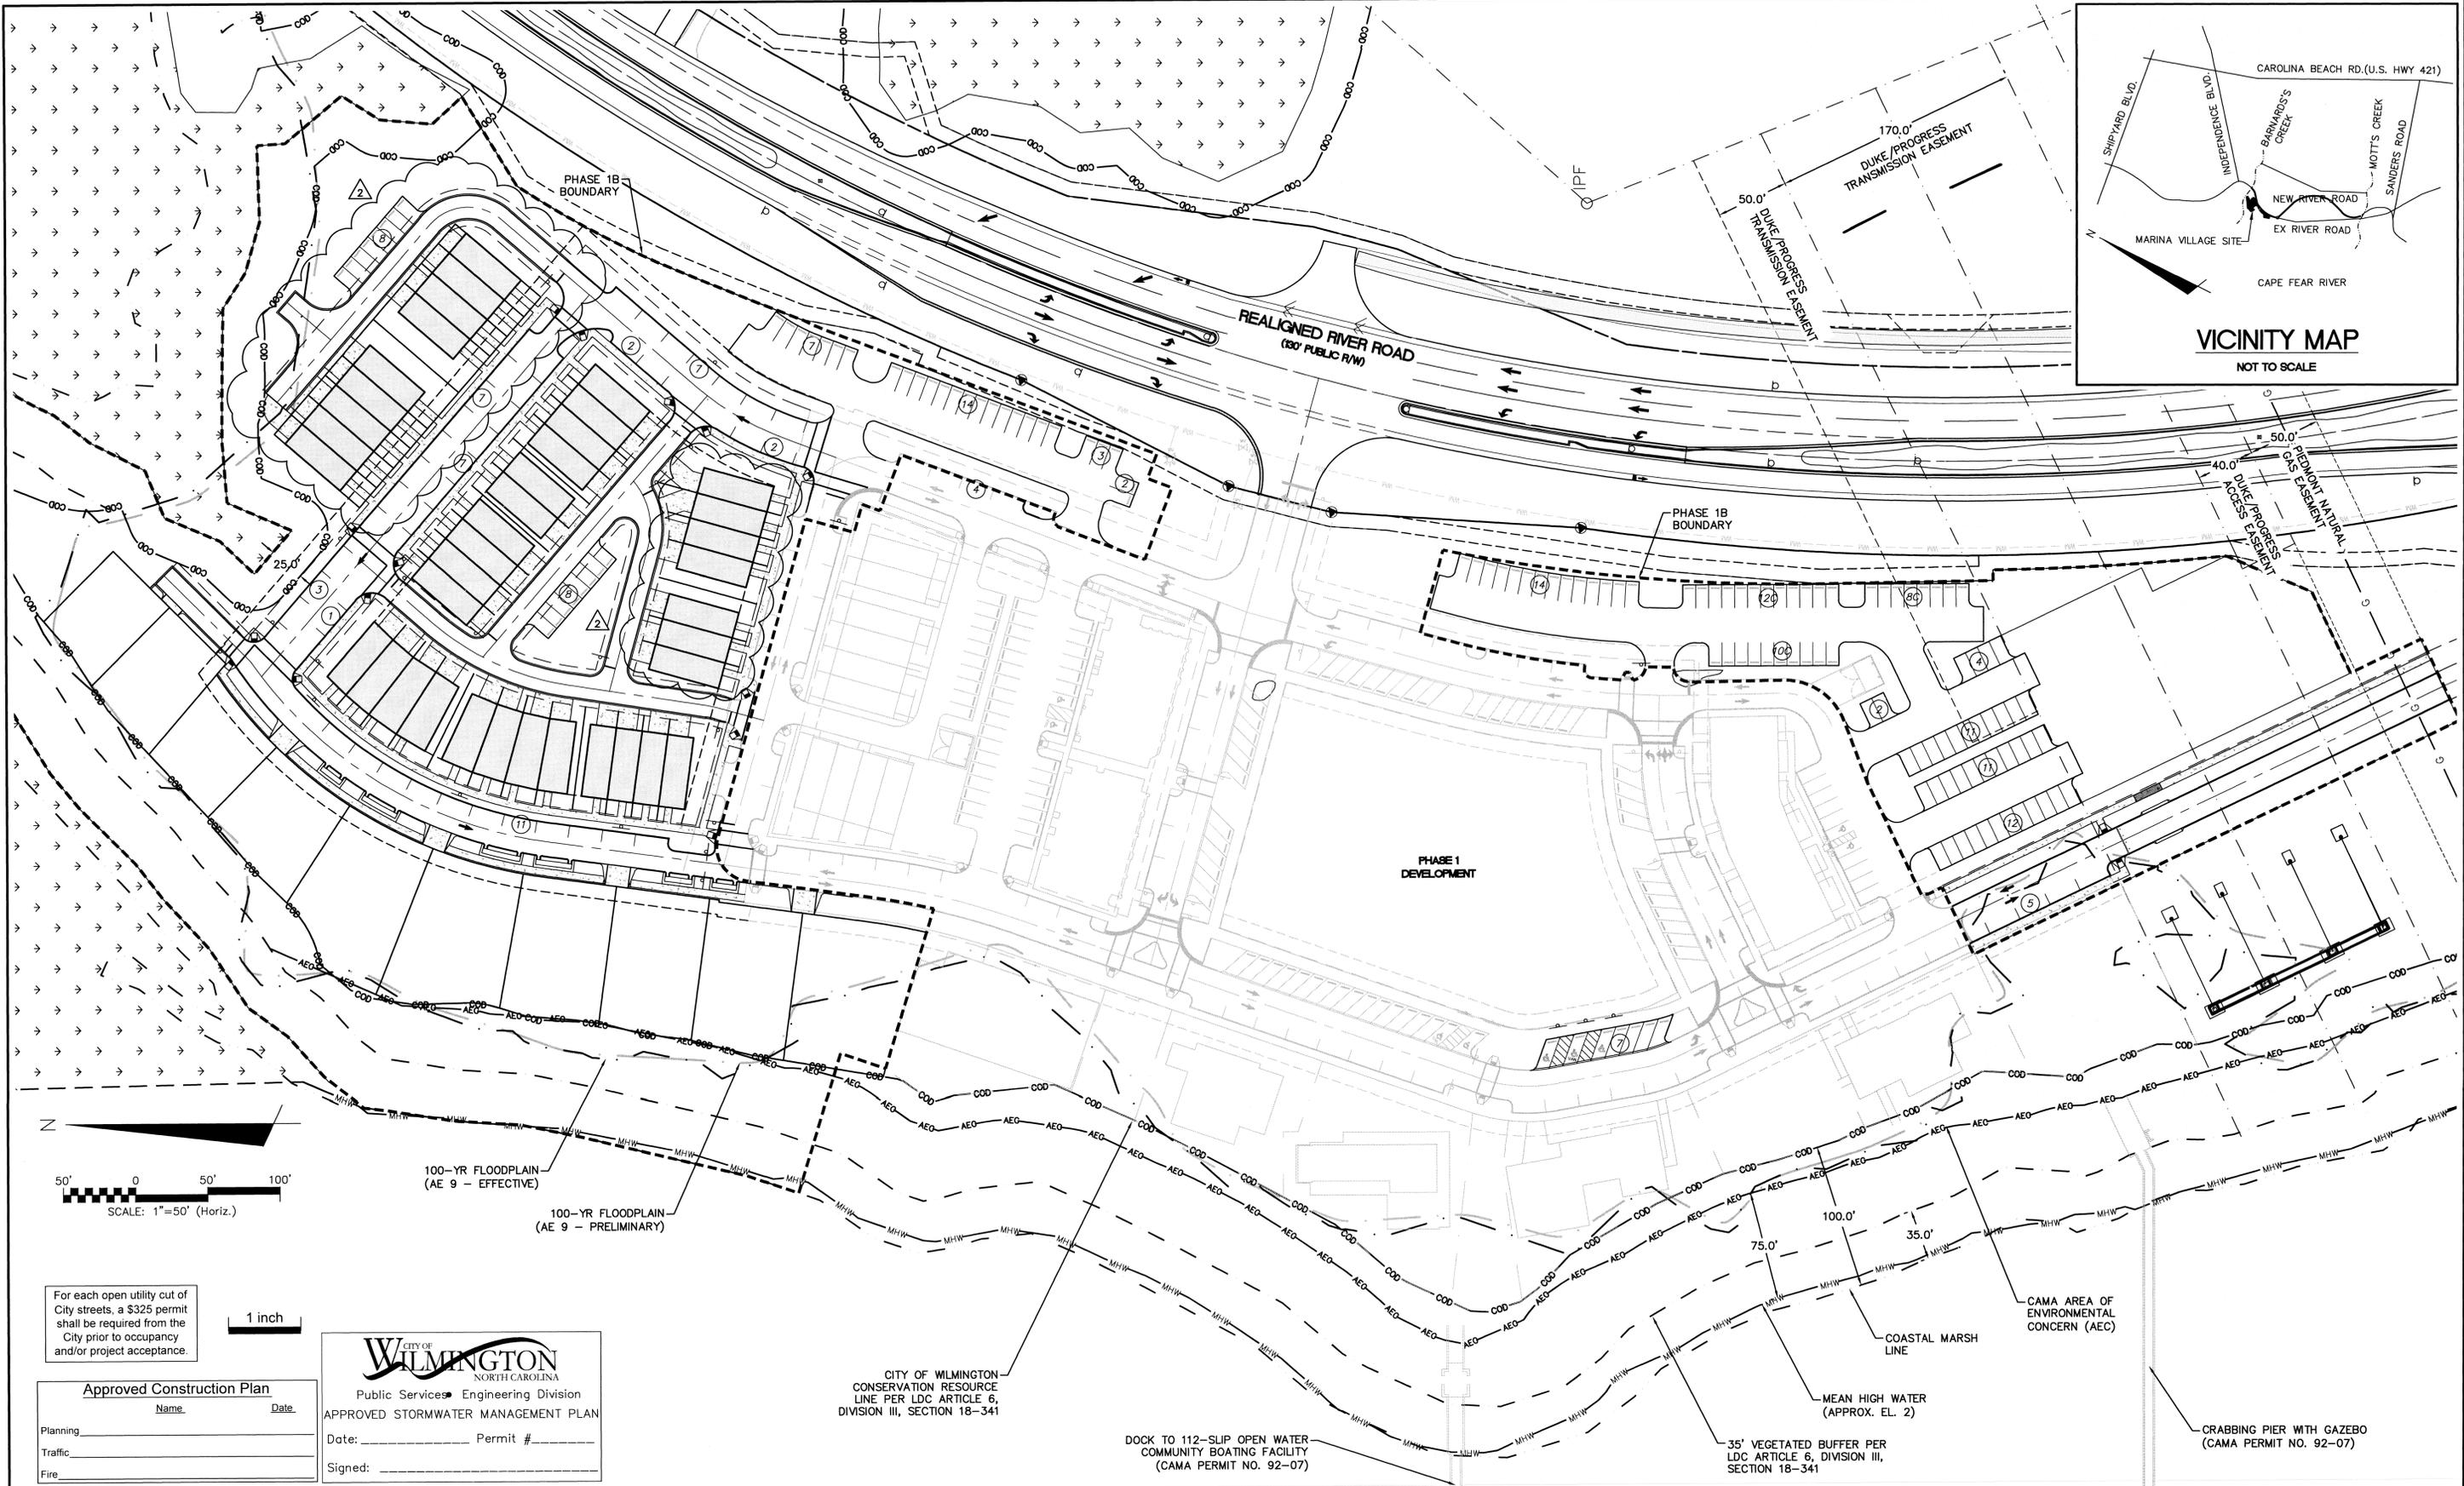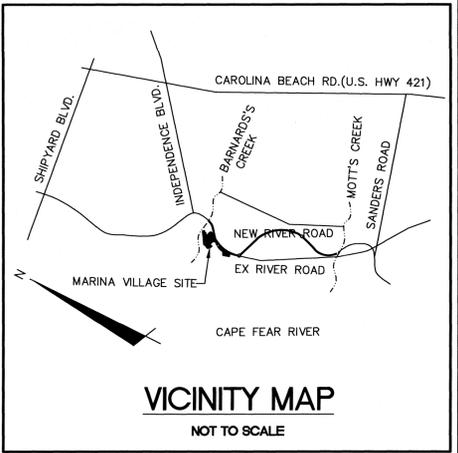

For each open utility cut of City streets, a \$325 permit shall be required from the City prior to occupancy and/or project acceptance.

1 inch

Approved Construction Plan	
Name	Date
Planning	
Traffic	
Fire	

**CITY OF WILMINGTON**  
NORTH CAROLINA  
Public Services Engineering Division  
APPROVED STORMWATER MANAGEMENT PLAN  
Date: \_\_\_\_\_ Permit # \_\_\_\_\_  
Signed: \_\_\_\_\_

CITY OF WILMINGTON  
CONSERVATION RESOURCE  
LINE PER LDC ARTICLE 6,  
DIVISION III, SECTION 18-341

DOCK TO 112-SLIP OPEN WATER  
COMMUNITY BOATING FACILITY  
(CAMA PERMIT NO. 92-07)

CAMA AREA OF ENVIRONMENTAL CONCERN (AEC)

MEAN HIGH WATER (APPROX. EL. 2)

35' VEGETATED BUFFER PER  
LDC ARTICLE 6, DIVISION III,  
SECTION 18-341

CRABBING PIER WITH GAZEBO  
(CAMA PERMIT NO. 92-07)

REV. NO.	DESCRIPTIONS	DATE
2	SITE PLAN AND STORM DRAINAGE REVISIONS	07/19/2016
1	CFPLA COMMENTS	04/11/2016
0	ISSUED FOR CONSTRUCTION	03/17/2016




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**RIVERLIGHTS**  
NORTH AMERICA SENIUS HOUSE, LLC

**RIVERLIGHTS MARINA VILLAGE  
PHASE 1B**  
**OVERALL SITE PLAN**

DATE: 17MAR16	SCALE: CS-100
MCE PROJ. # 2735-0124	HORIZONTAL: 1"=50'
DRAWN: ALM	VERTICAL: N/A
DESIGNED: NAL	REVISION: 11
CHECKED: KCB	REVISION: 2
PROJ. MGR.: NAL	STATUS: FINAL DESIGN ISSUED FOR CONSTRUCTION

S:\2735\0124 Marina Village\Drawings\Phase 1B\CS-103.dwg, 7/18/2016 5:03:23 PM, A:\mehall

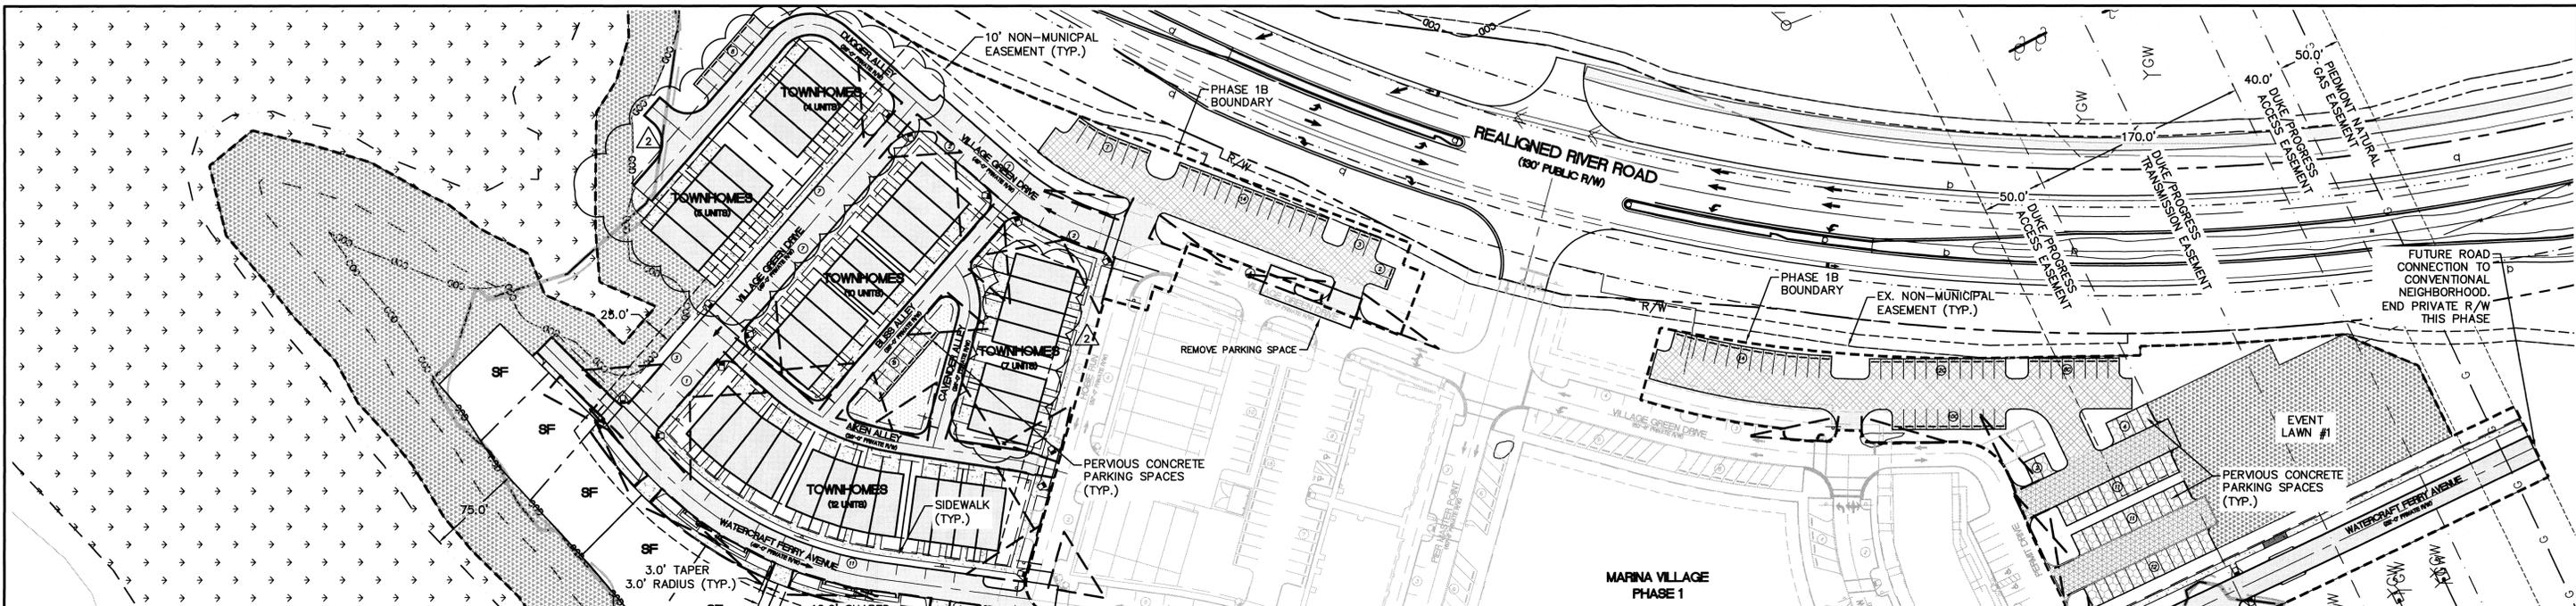

SITE DATA TABLE		MARINA VILLAGE - PHASE 1B	
PARCEL ADDRESS	4410 RIVER ROAD		
TAX PARCEL IDENTIFICATION NUMBER	R07000-006-009-000		
ZONING DISTRICT	CD-MX		
CAMA LAND USE CLASSIFICATION	TRANSITION AND CONSERVATION		
TOTAL ACREAGE WITHIN THE RIVERLIGHTS BOUNDARY	1,329.41 ACRES (57,909,100 SF)		
TOTAL ACREAGE WITHIN THE MARINA VILLAGE BOUNDARY	38.67 ACRES (1,684,343 SF)		
TOTAL ACREAGE OF COASTAL WETLANDS	14.57 ACRES (634,715 SF)		
TOTAL PROJECT AREA (STORMWATER PROJECT AREA)	24.10 ACRES (1,049,628 SF)		
TOTAL ACREAGE OF NON-COASTAL WETLANDS (ISOLATED/404)	76,797 SF (1.76 ACRES)		
TOTAL ACREAGE WITHIN THE MARINA VILLAGE - PHASE 1B	9.84 ACRES (428,668 SF)		
BUILDING SETBACKS AND SEPARATIONS (MX ZONING)	REQUIRED	PROPOSED	
FRONT	N/A	N/A	
REAR	N/A	N/A	
SIDE (INTERIOR)	N/A	N/A	
SIDE (CORNER)	N/A	N/A	
TOTAL BUILDING(S) SIZE (SQUARE FOOTAGE)	68,000 SF		
NC BUILDING CODE CONSTRUCTION TYPE	VB		
BUILDING LOT COVERAGE	16%		
NUMBER OF BUILDINGS	38 DUPLEX TOWNHOUSE		
TOTAL AMOUNT OF DISTURBED AREA	5.24 AC (228,450 SF)		
TOTAL ACRES WITHIN 100-YR FLOODPLAIN/BELOW MHW MARK	0.01 ACRES (513 SF)		
TOTAL ACRES WITHIN WETLANDS (DWQ PROJECT #07-1335)	N/A		


IMPERVIOUS AREA (EXISTING - PHASE 1)			
ROOF TOPS	52,249	SF	
ROADWAYS	92,792	SF	
PARKING	0	SF	
SIDEWALKS	35,408	SF	
OTHER	0	SF	
TOTAL PRE DEVELOPMENT/%	180,449/17.2	SF/%	

IMPERVIOUS AREA (PROPOSED)			
ROOF TOPS	71,516	SF	
ROADWAYS	51,562	SF	
PARKING	43,575	SF	
PERVIOUS PARKING	0	SF	
PERVIOUS PARKING (75% REDUCTION)	0	SF	
SIDEWALKS	22,078	SF	
PERVIOUS SIDEWALK	0	SF	
PERVIOUS SIDEWALK (75% REDUCTION)	0	SF	
FUTURE ALLOTMENT	0	SF	
OTHER	0	SF	
TOTAL S.F. (ONSITE IMPERVIOUS AREA)	188,731	SF	
PERCENTAGE (ONSITE IMPERVIOUS AREA/ONSITE AREA)	18.0	%	
PERCENTAGE (EXIST. ONSITE IMPERVIOUS AREA/ONSITE AREA)	17.2	%	
TOTAL SQUARE FOOTAGE OF IMPERVIOUS SURFACES SHOWN IN THE STREET YARD	0	SF	

PARKING CALCULATIONS	
MINIMUM NUMBER OF SPACES REQUIRED	N/A
MAXIMUM NUMBER OF SPACES ALLOWED	494
(48) TOWNHOMES (2.5 SPACES/UNIT)	120
(24) APARTMENTS (2.5 SPACES/UNIT)	60
(10) SINGLE FAMILY (2.5 SPACES/UNIT)	25
RESTAURANTS (1 SPACE / 65 SF GFA)	151
ART GALLERY (1 SPACE / 250 SF GFA)	31
RIVER HOUSE (1 SPACE / 65 SF GFA)	31
RETAIL (1 SPACE / 200 SF GFA)	20
MARINA (1 SPACE / 2 WET SLIPS)	56
PARKING SPACES PROVIDED (PHASE 1B)	172
PARKING SPACES PROVIDED (PHASE 1)	190
PARKING SPACES PROVIDED (TOTAL)	352
COMPACT CAR PARKING SPACES	30
BICYCLE PARKING SPACES REQUIRED	20
BICYCLE PARKING SPACES PROVIDED	20
HANDICAP SPACES REQUIRED	9
HANDICAP SPACES PROVIDED	9

SURFACE MATERIAL LEGEND	
	ASPHALT - STREET SECTION
	ASPHALT - DRIVE AISLE
	GRAVEL - PARKING LOT
	PERVIOUS CONCRETE
	ROOFTOP
	SIDEWALK
	COMMON SPACE
	OPEN SPACE


**PARKING NOTE:**  
 • ALL BICYCLE PARKING IS PROVIDED IN PHASE 1.

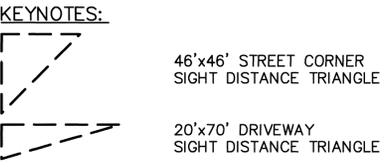

**NOTE:**  
 ALL PROPOSED VEGETATION WITHIN SIGHT TRIANGLES SHALL NOT INTERFERE WITH CLEAR VISUAL SIGHT LINES FROM 30" - 10'

WATER & SEWER DEMAND	
WATER DEMAND	17,280 GDP
SANITARY SEWER DEMAND	17,280 GDP

TOTAL ACREAGE OF MARINA VILLAGE - PHASE 1B WITHIN COD: 2.06 ACRES (89,951 SF)  
 TOTAL ACREAGE OF MARINA VILLAGE - PHASE 1B ENCROACHMENT INTO THE COD: 0 ACRES (0 SF)

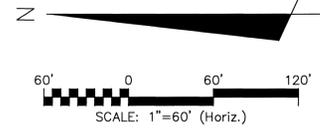


COMMON SPACE CALCULATIONS	
TOTAL COMMON SPACE REQUIRED	18.47 ACRES (804,640 SF)*
TOTAL COMMON SPACE PROPOSED	0.08 ACRES (3,634 SF)

OPEN SPACE CALCULATIONS*	
TOTAL OPEN SPACE REQUIRED	46.18 ACRES (2,011,601 SF)*
TOTAL OPEN SPACE PROPOSED	2.82 ACRES (122,991 SF)

\*PROPOSED MX-CO CLUSTER FOR ENTIRE RIVER LIGHTS DEVELOPMENT = 184.7 ACRES  
 OPEN SPACE AND COMMON SPACE ACRES REQUIRED FOR ENTIRE RIVERLIGHTS DEVELOPMENT  
 • 25% OPEN SPACE AND 10% COMMON SPACE = 46.18 AC (OPEN) AND 18.47 AC (COMMON)

REV. NO.	DESCRIPTIONS	DATE
2	SITE PLAN AND STORM DRAINAGE REVISIONS	07/19/2016
1	CFRPA COMMENTS	04/11/2016
0	ISSUED FOR CONSTRUCTION	03/17/2016

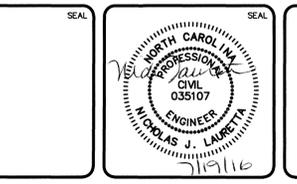

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**RIVERLIGHTS**  
 NORTH AMERICA SENIUS HOUSE, LLC

**RIVERLIGHTS MARINA VILLAGE PHASE 1B**  
 SITE PLAN


DATE: 17MAR16  
 MCE PROJ. # 2735-0124  
 DRAWN: ALM  
 DESIGNED: NUL  
 CHECKED: KCBK  
 PROJ. MGR.: NUL

SCALE: HORIZONTAL: 1"=60'  
 VERTICAL: N/A

M/C FILE NUMBER: CS-101  
 DRAWING NUMBER: 12

STATUS: FINAL DESIGN  
 ISSUED FOR CONSTRUCTION

REVISION: 2

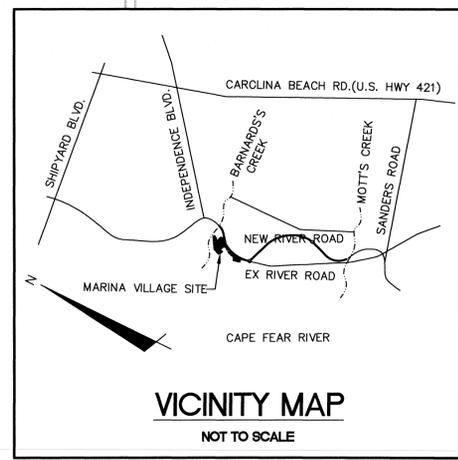

Approved Construction Plan  
 Name: \_\_\_\_\_ Date: \_\_\_\_\_

Planning: \_\_\_\_\_  
 Traffic: \_\_\_\_\_  
 Fire: \_\_\_\_\_

**CITY OF WILMINGTON**  
 NORTH CAROLINA  
 Public Services Engineering Division  
 APPROVED STORMWATER MANAGEMENT PLAN


Date: \_\_\_\_\_ Permit # \_\_\_\_\_  
 Signed: \_\_\_\_\_

**CITY OF WILMINGTON NOTES:**

- ALL PARKING STALL MARKINGS AND LANE ARROWS WITHIN THE PARKING AREAS SHALL BE WHITE.
- ALL TRAFFIC CONTROL SIGNS AND MARKINGS OFF THE RIGHT-OF-WAY ARE TO BE MAINTAINED BY THE PROPERTY OWNER IN ACCORDANCE WITH MUTCD STANDARDS.
- A UTILITY CUT PERMIT IS REQUIRED FOR EACH OPEN CUT OF A CITY STREET. CONTACT 341-5888 FOR MORE DETAILS. IN CERTAIN CASES AN ENTIRE RESURFACING OF THE AREA BEING OPEN CUT MAY BE REQUIRED.
- A LANDSCAPING PLAN INDICATING THE LOCATION OF REQUIRED STREET TREES SHALL BE SUBMITTED TO THE CITY OF WILMINGTON TRAFFIC ENGINEERING DIVISION AND PARKS AND RECREATION DEPARTMENT FOR REVIEW AND APPROVAL PRIOR TO THE RECORDING OF THE FINAL PLAT.
- ZERO LOT LINES ARE PERMITTED.
- BUILDINGS LOCATED ON THE PERIPHERY OF THE MX DISTRICT SHALL BE SET BACK A MINIMUM OF 20 (TWENTY) FEET FROM THE MX DISTRICT BOUNDARY.
- ZONING AND LAND USE OF ADJACENT PROPERTIES IS AS FOLLOWS:  
 NORTH - FUTURE MX-CD / TRANSITION  
 SOUTH - FUTURE MX-CD / TRANSITION AND CONSERVATION AREA  
 WEST - FUTURE MX-CD / TRANSITION  
 EAST - I-2 / TRANSITION AND CONSERVATION AREA
- INSTALL REFLECTORS PER CITY AND NCDOT STANDARDS. TRAFFIC ENGINEERING MUST APPROVE OF PAVEMENT MARKING LAYOUT PRIOR TO ACTUAL STRIPING.
- IT SHALL BE THE RESPONSIBILITY OF THE SUBDIVIDER TO ERECT OFFICIAL STREET NAME SIGNS AT ALL INTERSECTIONS ASSOCIATED WITH THE SUBDIVISION IN ACCORDANCE WITH THE TECHNICAL STANDARDS AND SPECIFICATION MANUAL. THE SUBDIVIDER MAY ACQUIRE AND ERECT OFFICIAL STREET NAME SIGNS OR CHOOSE TO CONTRACT WITH THE CITY TO INSTALL THE STREET SIGNS AND THE SUBDIVIDER SHALL PAY THE COSTS OF SUCH INSTALLATION. CONTACT TRAFFIC ENGINEERING AT 341-7888 TO DISCUSS INSTALLATION OF TRAFFIC AND STREET NAME SIGNS. PROPOSED STREET NAMES MUST BE APPROVED PRIOR TO INSTALLATION OF STREET NAME SIGNS.
- CONTACT TRAFFIC ENGINEERING AT 341-7888 FORTY-EIGHT HOURS PRIOR TO ANY EXCAVATION IN THE RIGHT OF WAY.
- IF THESE UNITS ARE SOLD AT ANY POINT, THE BUYER MUST RECEIVE A SUBDIVISION STREET DISCLOSURE STATEMENT.

**GENERAL NOTES:**

- FLOODPLAIN INFORMATION WAS OBTAINED FROM NC FLOODPLAIN MAPPING FLOOD RISK INFORMATION SYSTEM PROGRAM. RIVERLIGHTS IS LOCATED WITHIN FIRM MAP 3720312400K, PANEL 3124 AS REVISED JUNE 02, 2006.
- ITEMS DESIGNATED AS "PROPOSED" ARE PART OF THE RIVER ROAD REALIGNMENT PROJECT THAT IS CURRENTLY UNDER CONSTRUCTION. RIVER ROAD CONSTRUCTION TO BE COMPLETE SPRING 2016.
- WETLANDS SHOWN IN THIS PORTION OF RIVERLIGHTS WERE DESCRIBED AS BRACKISH/SALT MARSH AND POCOSIN WETLANDS AND CONSERVATION RESOURCE SETBACK LINES WERE GENERATED AS 100' AND 25', RESPECTIVELY, MINIMUM OUTSIDE OF THE RESOURCE.
- FINISHED FLOOR ELEVATIONS OFF ALL INHABITABLE STRUCTURES WILL BE MIN. 2'-FEET ABOVE BASE FLOOD ELEVATION
- RIVERLIGHTS PHASE 1 MARINA VILLAGE COMMUNITY DOES NOT CONTAIN ANY LOCAL, STATE, OR FEDERALLY RECOGNIZED HISTORIC STRUCTURES OR ARCHEOLOGICAL SITES ON SITE. RIVERLIGHTS WAS ISSUED A NOTICE OF NO FURTHER ACTION LETTER DATED JUNE 2, 2008 FOLLOWING COMPLETION OF AN EA/SEPA DOCUMENT.
- EXISTING THROUGHFARES, BIKE ROUTES, PEDESTRIAN SIDEWALKS OR TRAILS AND TRANSITS FACILITIES DO NOT EXIST ON SITE.


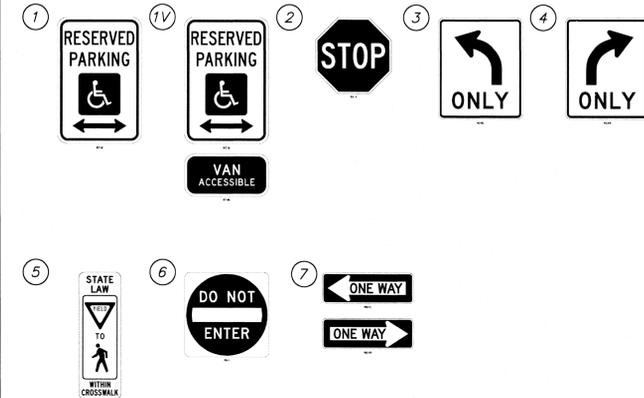


For each open utility cut of City streets, a \$325 permit shall be required from the City prior to occupancy and/or project acceptance.


1 inch

**CITY OF WILMINGTON**  
 NORTH CAROLINA  
 Public Services - Engineering Division  
**APPROVED STORMWATER MANAGEMENT PLAN**

Name: \_\_\_\_\_ Date: \_\_\_\_\_  
 Planning: \_\_\_\_\_  
 Traffic: \_\_\_\_\_ Date: \_\_\_\_\_ Permit # \_\_\_\_\_  
 Fire: \_\_\_\_\_ Signed: \_\_\_\_\_

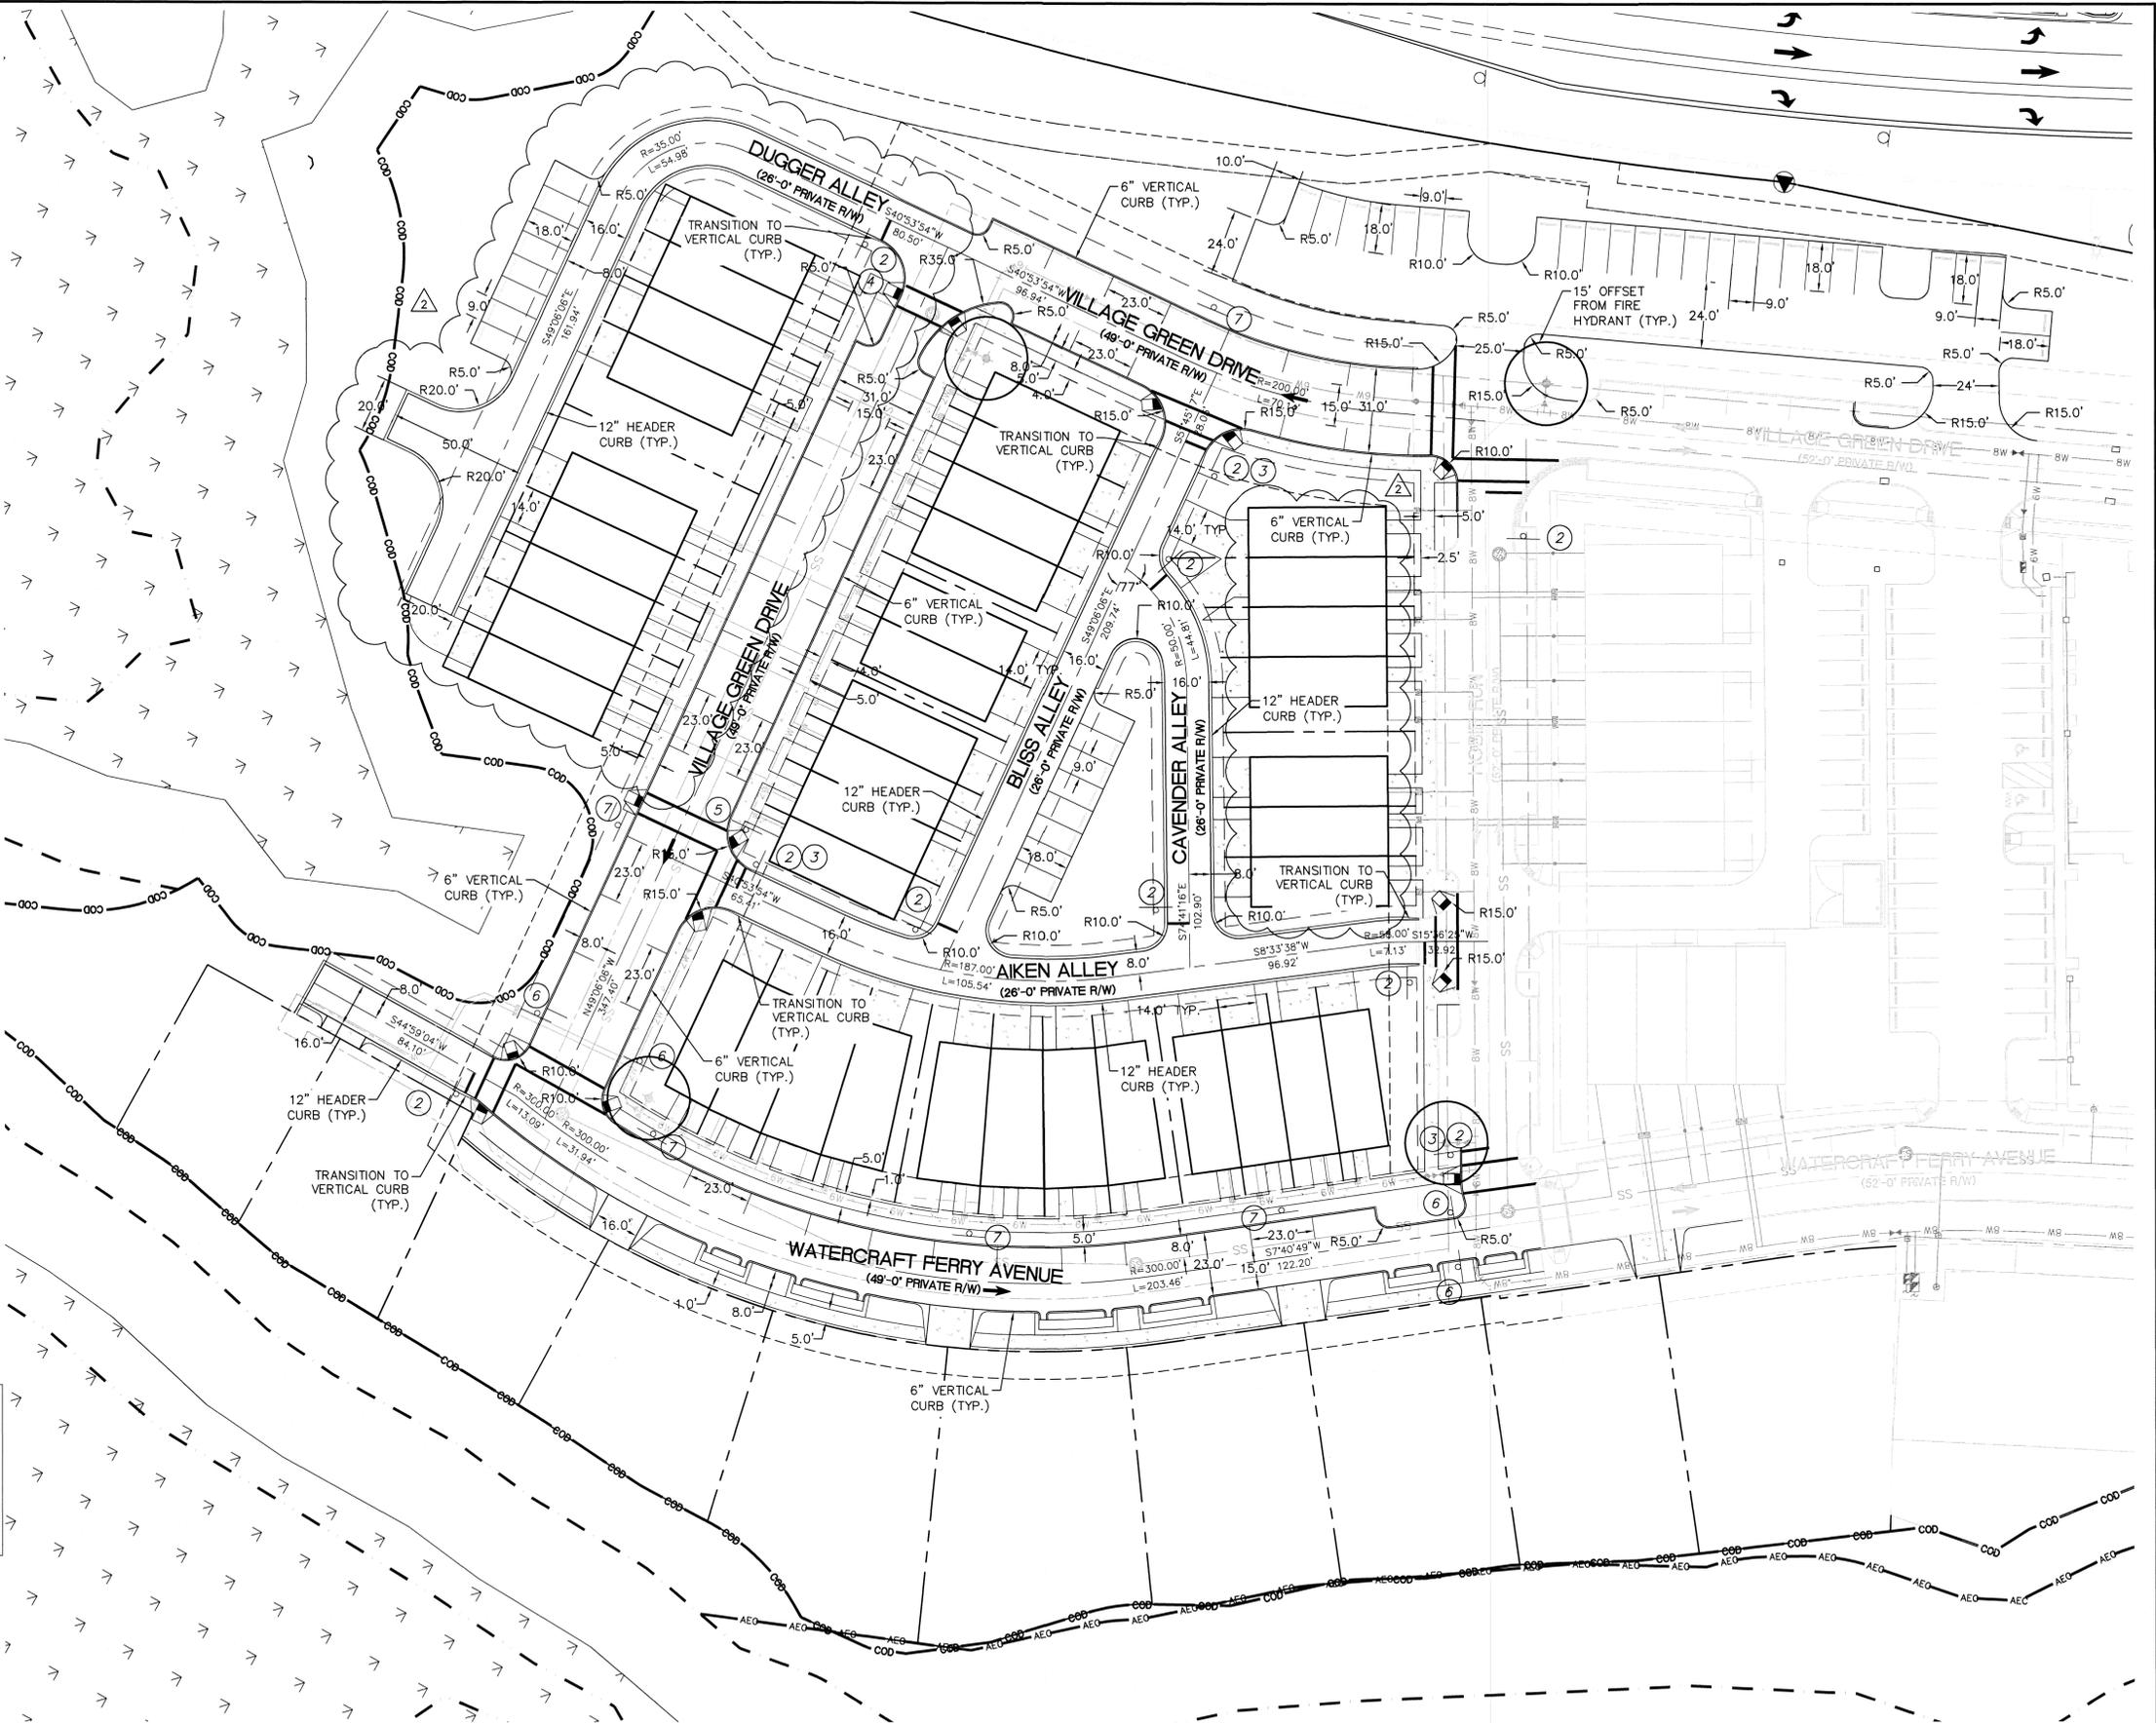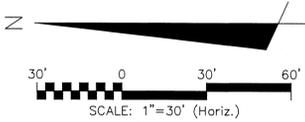

REVNO.	DESCRIPTIONS	DATE
2	SITE PLAN AND STORM DRAINAGE REVISIONS	07/19/2016
1	CFRUA COMMENTS	04/17/2016
0	ISSUED FOR CONSTRUCTION	03/17/2016

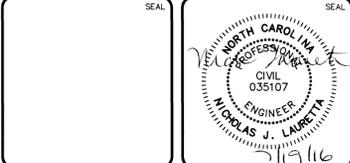

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**RIVERLIGHTS**  
 NORTH AMERICA SEXIUSI HOUSE, LLC

**RIVERLIGHTS MARINA VILLAGE PHASE 1B**  
**SITE PLAN NORTH**

DATE: 17MAR16  
 MCE PROJ. #: 2735-0124  
 DRAWN: ALM  
 DESIGNED: NJL  
 CHECKED: KCB  
 PROJ. MGR.: NJL

SCALE: HORIZONTAL: 1"=30', VERTICAL: N/A

MAC FILE NUMBER: CS-102  
 DRAWING NUMBER: 13

STATUS: FINAL DESIGN  
 ISSUED FOR CONSTRUCTION

REVISION: 2


For each open utility cut of City streets, a \$325 permit shall be required from the City prior to occupancy and/or project acceptance.

1 inch






Public Services Engineering Division  
**APPROVED STORMWATER MANAGEMENT PLAN**  
 Date: \_\_\_\_\_ Permit # \_\_\_\_\_  
 Signed: \_\_\_\_\_

**Approved Construction Plan**  
 Name: \_\_\_\_\_ Date: \_\_\_\_\_  
 Planning: \_\_\_\_\_  
 Traffic: \_\_\_\_\_  
 Fire: \_\_\_\_\_

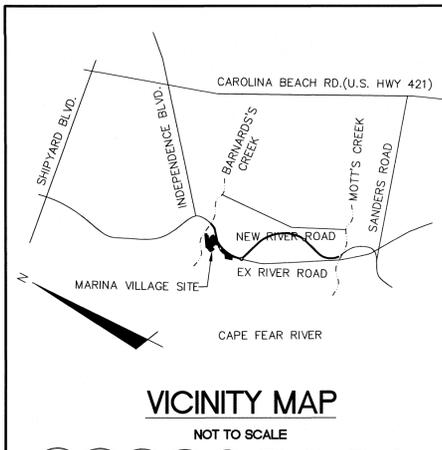


(5) SHALLOW SERVICES TRANSITION TO 401 PROTECTO LINED DIP OVER CROSSING INCLUDING TOP 45° ELBOW AND TRANSITION FITTING. TRANSITION TO SCH. 40 PVC 1 FT BEFORE COMBINATION.

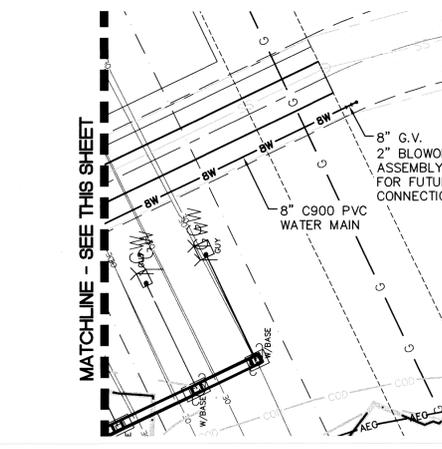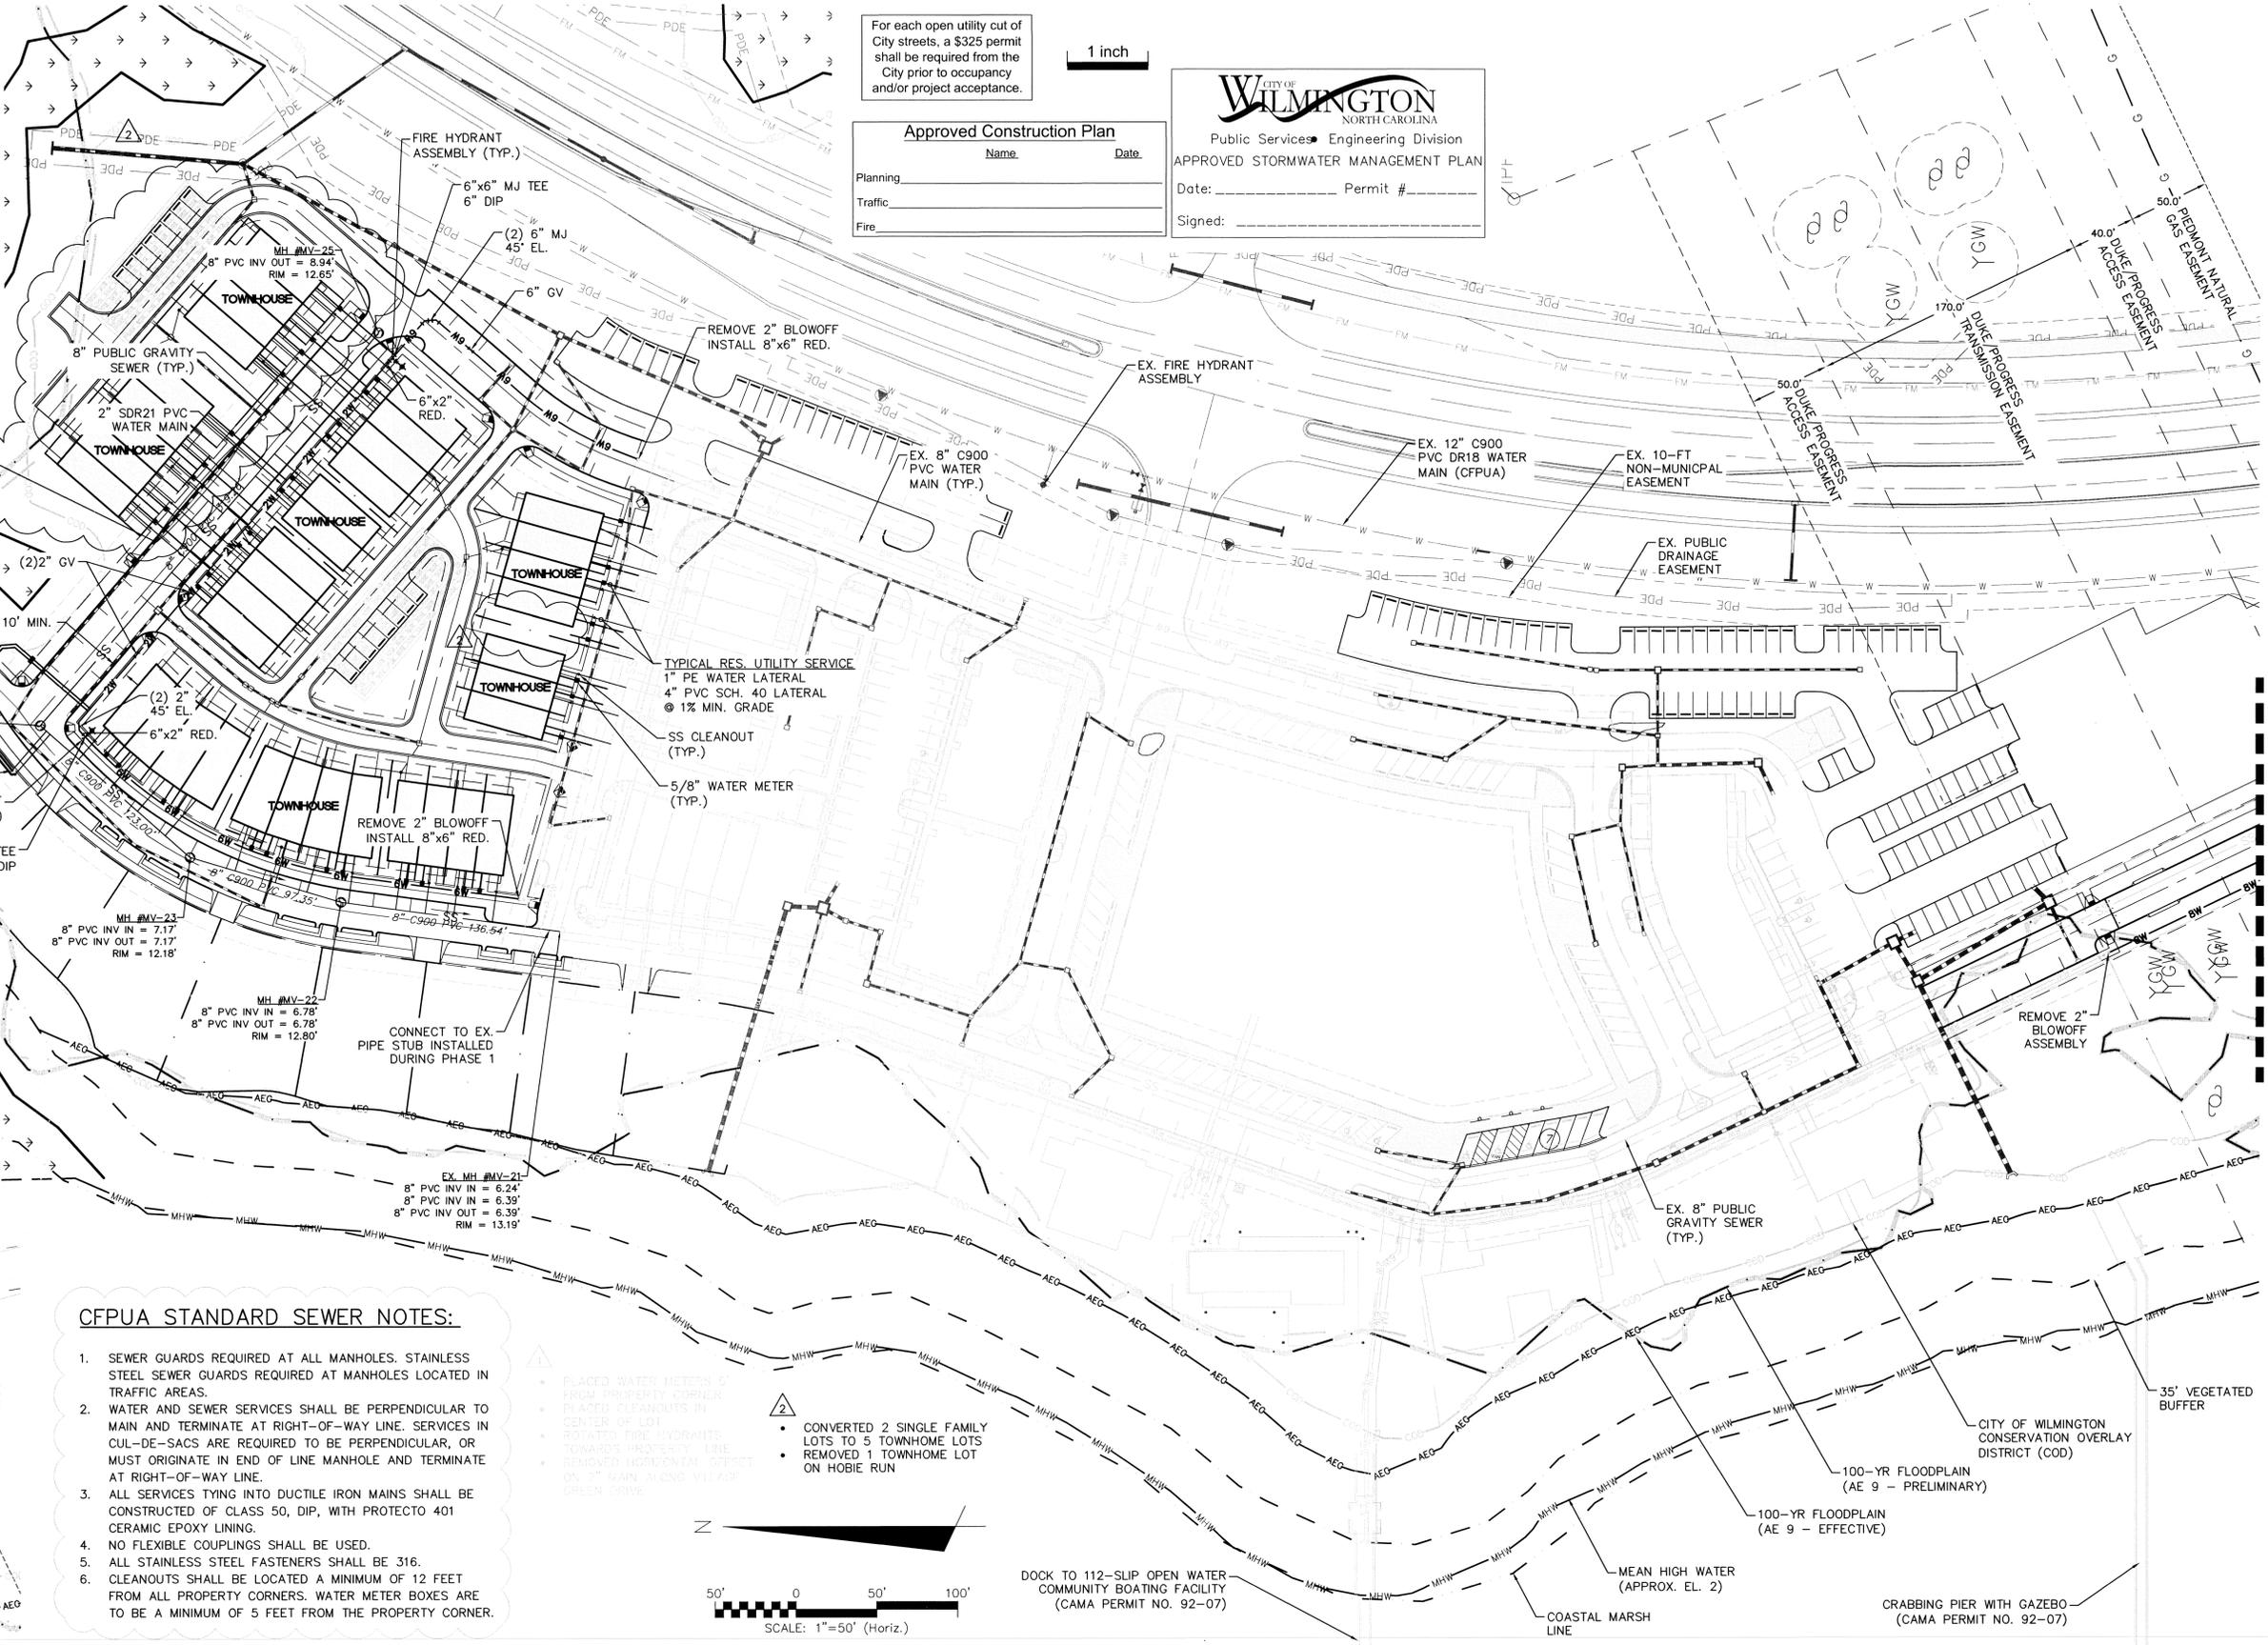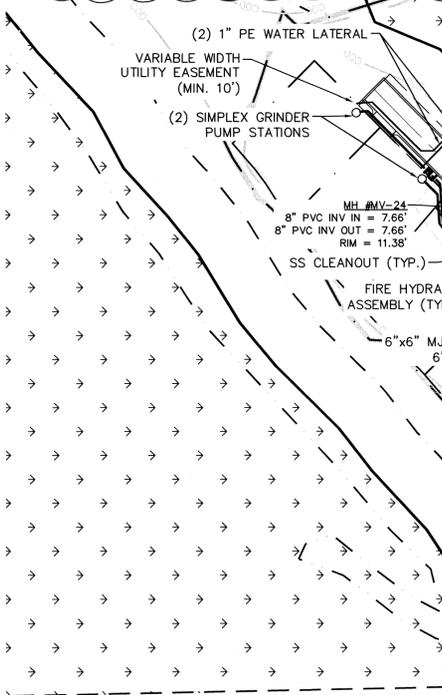

**CFPUA STANDARD SEWER NOTES:**

- SEWER GUARDS REQUIRED AT ALL MANHOLES. STAINLESS STEEL SEWER GUARDS REQUIRED AT MANHOLES LOCATED IN TRAFFIC AREAS.
- WATER AND SEWER SERVICES SHALL BE PERPENDICULAR TO MAIN AND TERMINATE AT RIGHT-OF-WAY LINE. SERVICES IN CUL-DE-SACS ARE REQUIRED TO BE PERPENDICULAR, OR MUST ORIGINATE IN END OF LINE MANHOLE AND TERMINATE AT RIGHT-OF-WAY LINE.
- ALL SERVICES TYING INTO DUCTILE IRON MAINS SHALL BE CONSTRUCTED OF CLASS 50, DIP, WITH PROTECTO 401 CERAMIC EPOXY LINING.
- NO FLEXIBLE COUPLINGS SHALL BE USED.
- ALL STAINLESS STEEL FASTENERS SHALL BE 316.
- CLEANOUTS SHALL BE LOCATED A MINIMUM OF 12 FEET FROM ALL PROPERTY CORNERS. WATER METER BOXES ARE TO BE A MINIMUM OF 5 FEET FROM THE PROPERTY CORNER.

- PLACED WATER METERS 5' FROM PROPERTY CORNER
- PLACED CLEANOUTS IN CENTER OF LOT
- REMOVED FIRE HOSE CABINETS TOWARD PROPERTY LINE
- REMOVED HOODS FROM TOP OF 3" MAIN ALONG VILLAGE GREEN DRIVE
- CONVERTED 2 SINGLE FAMILY LOTS TO 5 TOWNHOME LOTS
- REMOVED 1 TOWNHOME LOT ON HOBIE RUN

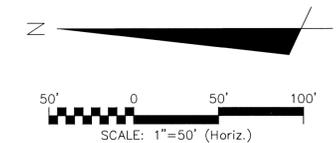

REVNO.	DESCRIPTIONS	DATE
2	SITE PLAN AND STORM DRAINAGE REVISIONS	07/19/2016
1	CFPUA COMMENTS	04/11/2016
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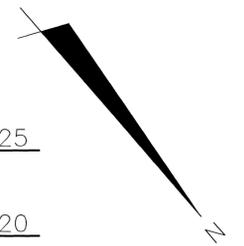
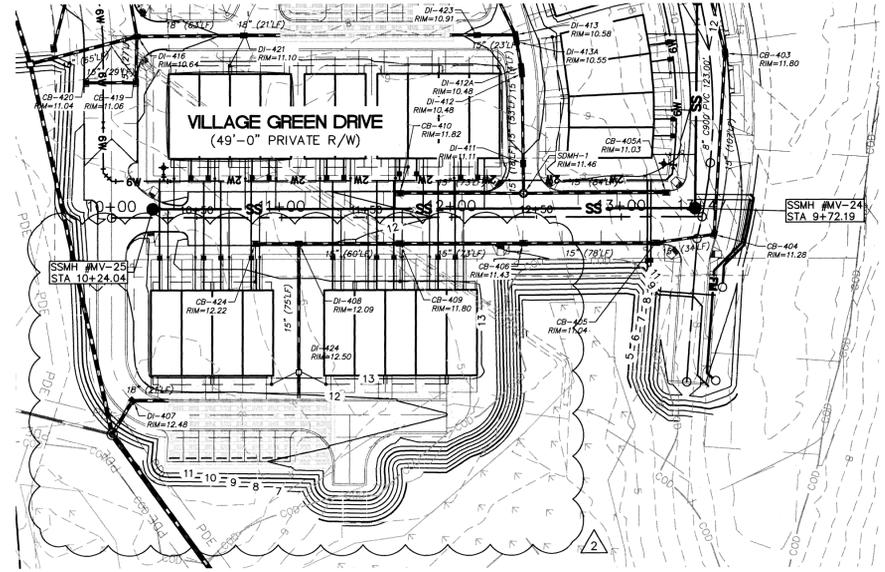
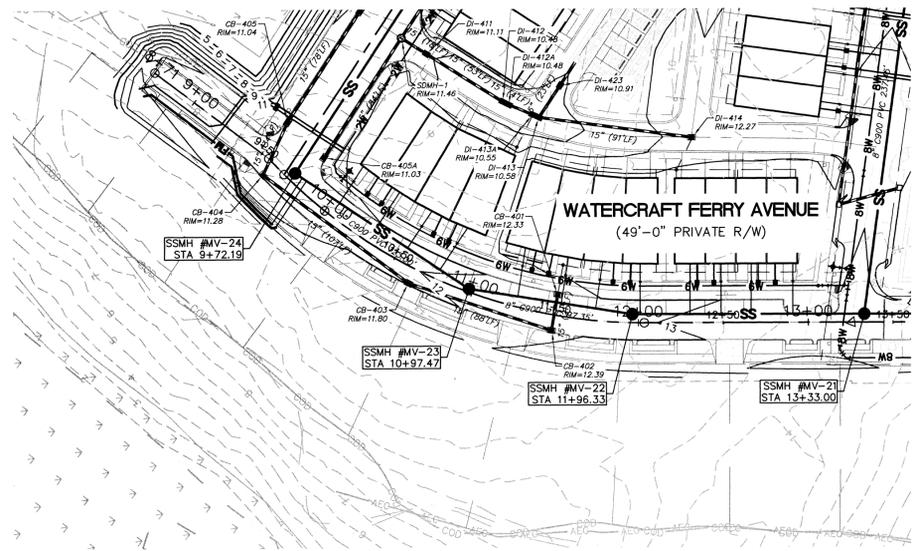
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**RIVERLIGHTS**  
 NORTH AMERICA SEKISUI HOUSE, LLC

**RIVERLIGHTS MARINA VILLAGE PHASE 1B**  
**UTILITY PLAN**


DATE: 17MAR16	SCALE: CU-101
MCE PROJ. # 2735-0124	HORIZONTAL: 1"=50'
DRAWN: ALM	VERTICAL: N/A
DESIGNED: NJL	REVISION: 2
CHECKED: KBCE	STATUS: FINAL DESIGN
PROJ. MGR: NJL	ISSUED FOR CONSTRUCTION

MATCHLINE - SEE THIS SHEET




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**WATERCRAFT FERRY AVENUE**  
SCALE: HOR. 1"=50', VERT. 1"=5'

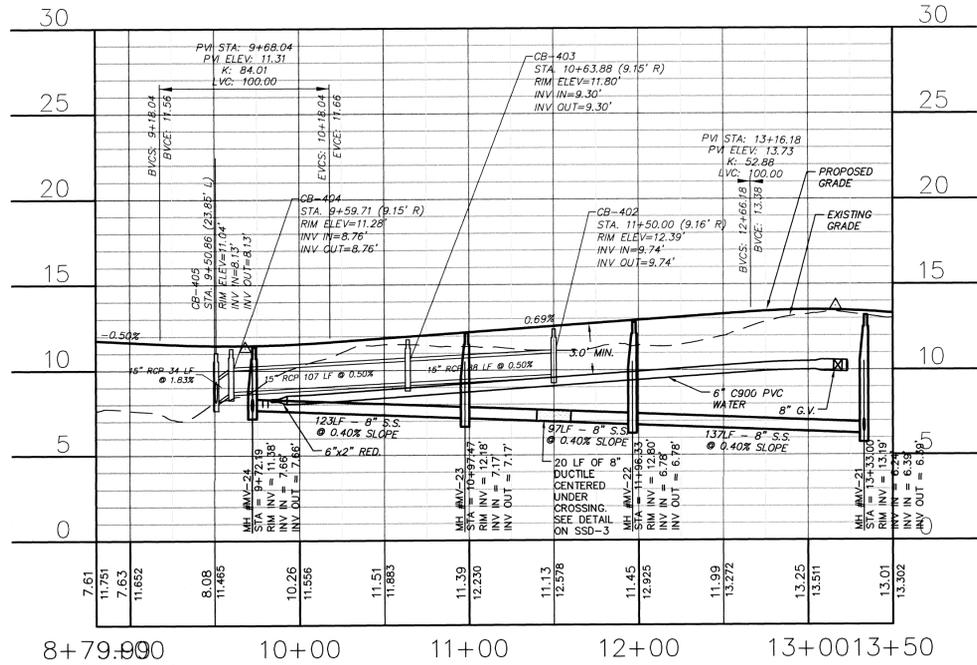

**VILLAGE GREEN DRIVE**  
SCALE: HOR. 1"=50', VERT. 1"=5'

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1 inch

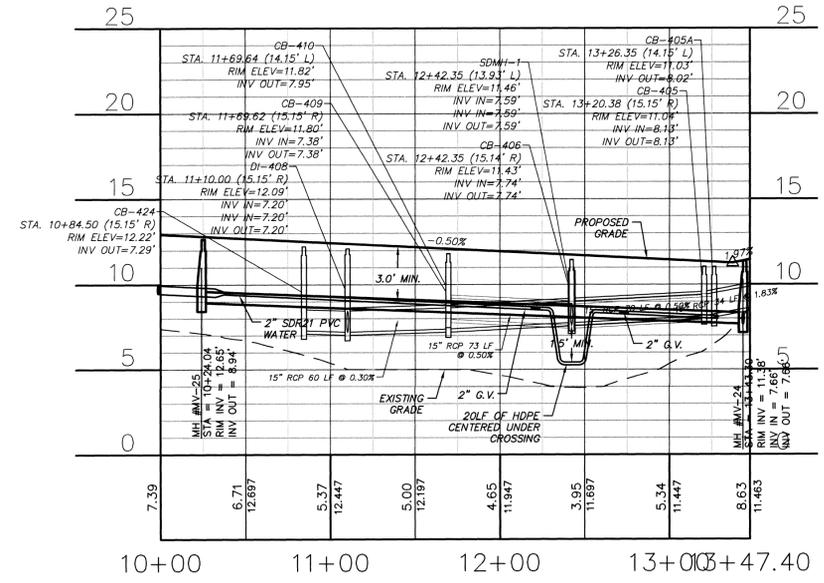**CITY OF WILMINGTON**  
NORTH CAROLINA  
Public Services Engineering Division  
APPROVED STORMWATER MANAGEMENT PLAN

Date: \_\_\_\_\_ Permit # \_\_\_\_\_  
Signed: \_\_\_\_\_

**Approved Construction Plan**

Name: \_\_\_\_\_ Date: \_\_\_\_\_  
Planning: \_\_\_\_\_  
Traffic: \_\_\_\_\_  
Fire: \_\_\_\_\_

- CONVERTED 2 SINGLE FAMILY LOTS TO 5 TOWNHOME LOTS
- REMOVED 1 TOWNHOME LOT ON HOBIE RUN

REVNO.	DESCRIPTIONS	DATE
2	SITE PLAN AND STORM DRAINAGE REVISIONS	07/19/2016
1	CRITICAL COMMENTS	04/11/2016
0	ISSUED FOR CONSTRUCTION	03/17/2016



**MCKIM & CREED**  
243 North Front Street  
Wilmington, North Carolina 28401  
Phone: (910)343-1048, Fax: (910)251-8282  
License: F-1222  
www.mckimcreed.com

**RIVERLIGHTS**  
NORTH AMERICA SEKISUI HOUSE, LLC


**RIVERLIGHTS MARINA VILLAGE PHASE 1B**  
**PLAN AND PROFILE**







DATE: 17MAR16  
MCE PROJ. # 2735-0124  
DRAWN: ALM  
DESIGNED: NJL  
CHECKED: KCB  
PROJ. MGR.: NJL

SCALE: HORIZONTAL: 1"=50'  
VERTICAL: 1"=5'

MAC FILE NUMBER: CU-701  
DRAWING NUMBER: 16  
REVISION: 2

STATUS: FINAL DESIGN  
ISSUED FOR CONSTRUCTION


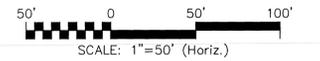


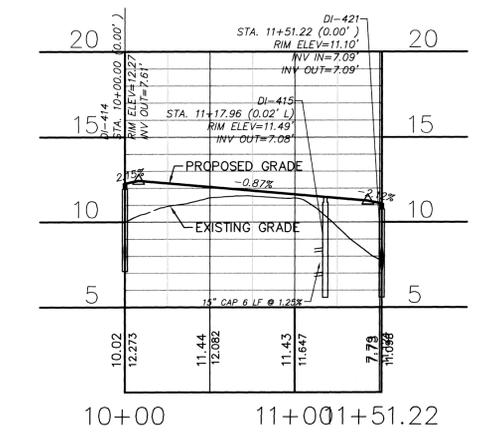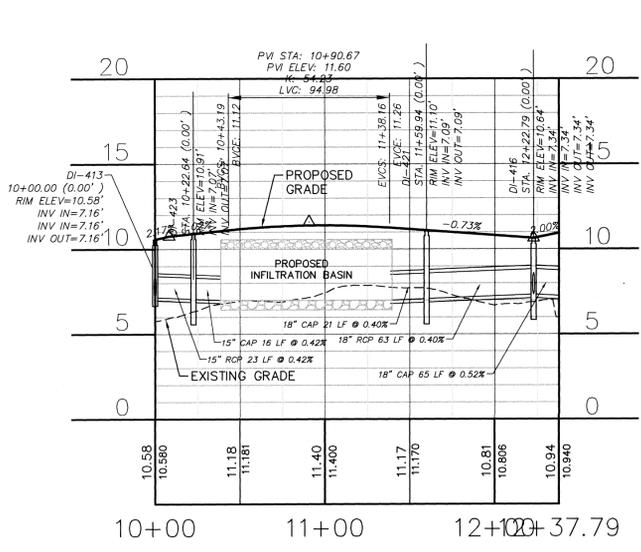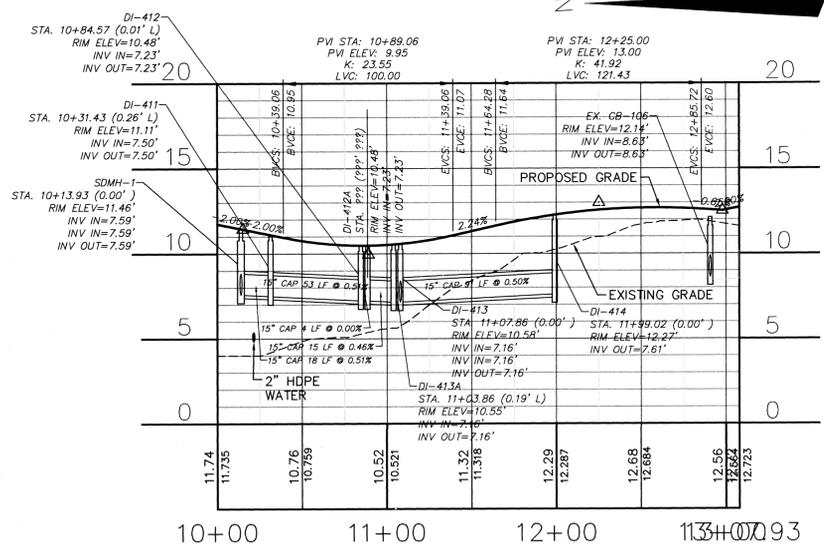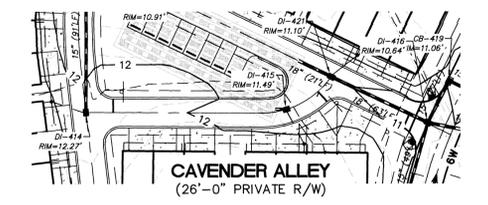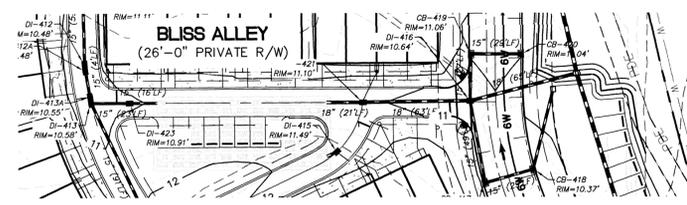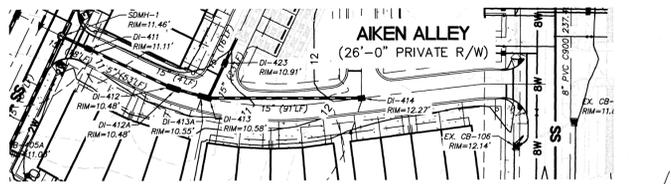


**AIKEN ALLEY**  
HOR. 1"=50', VERT. 1"=5'

**BLISS ALLEY**  
HOR. 1"=50', VERT. 1"=5'

**CAVENDER ALLEY**  
HOR. 1"=50', VERT. 1"=5'

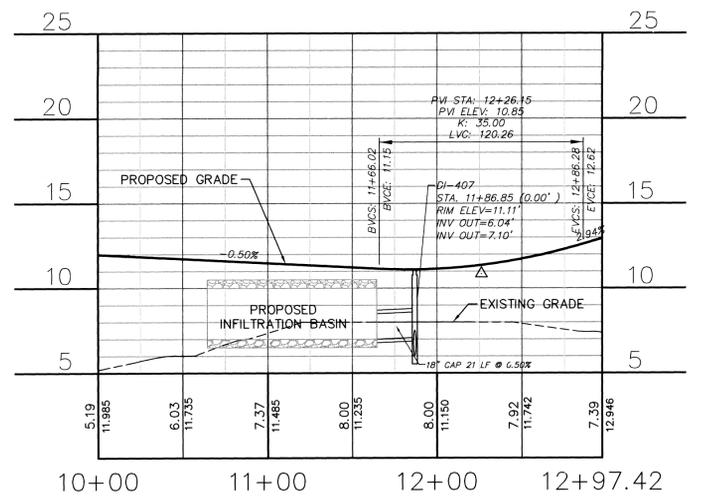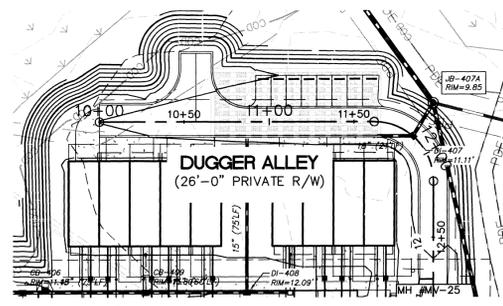

**DUGGER ALLEY**  
HOR. 1"=50', VERT. 1"=5'

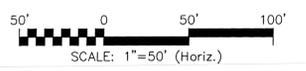

For each open utility cut of City streets, a \$325 permit shall be required from the City prior to occupancy and/or project acceptance.

1 inch

Approved Construction Plan	
Name	Date
Planning	
Traffic	
Fire	

**CITY OF WILMINGTON**  
NORTH CAROLINA  
Public Services • Engineering Division  
APPROVED STORMWATER MANAGEMENT PLAN  
Date: \_\_\_\_\_ Permit # \_\_\_\_\_  
Signed: \_\_\_\_\_

**CFPUA STANDARD SEWER NOTES:**

- SEWER GUARDS REQUIRED AT ALL MANHOLES. STAINLESS STEEL SEWER GUARDS REQUIRED AT MANHOLES LOCATED IN TRAFFIC AREAS.
- WATER AND SEWER SERVICES SHALL BE PERPENDICULAR TO MAIN AND TERMINATE AT RIGHT-OF-WAY LINE. SERVICES IN CUL-DE-SACS ARE REQUIRED TO BE PERPENDICULAR, OR MUST ORIGINATE IN END OF LINE MANHOLE AND TERMINATE AT RIGHT-OF-WAY LINE.
- ALL SERVICES TYING INTO DUCTILE IRON MAINS SHALL BE CONSTRUCTED OF CLASS 50, DIP, WITH PROTECTO 401 CERAMIC EPOXY LINING.
- NO FLEXIBLE COUPLINGS SHALL BE USED.
- ALL STAINLESS STEEL FASTENERS SHALL BE 316.
- CLEANOUTS SHALL BE LOCATED A MINIMUM OF 12 FEET FROM ALL PROPERTY CORNERS. WATER METER BOXES ARE TO BE A MINIMUM OF 5 FEET FROM THE PROPERTY CORNER.

REV. NO.	DESCRIPTIONS	DATE
2	SITE PLAN AND STORM DRAINAGE REVISIONS	07/19/2016
1	CFPUA COMMENTS	04/17/2016
0	ISSUED FOR CONSTRUCTION	03/17/2016




**MCKIM & CREED**  
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**RIVERLIGHTS**  
NORTH AMERICA SENSUS HOUSE, LLC

**RIVERLIGHTS MARINA VILLAGE PHASE 1B**  
**PLAN AND PROFILE**


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DRAWN: ALM	CHECKED: KCB	PROJ. MGR.: NJL
STATUS: FINAL DESIGN		
ISSUED FOR CONSTRUCTION		
REVISION: 2		

# INFILTRATION GALLERY 4

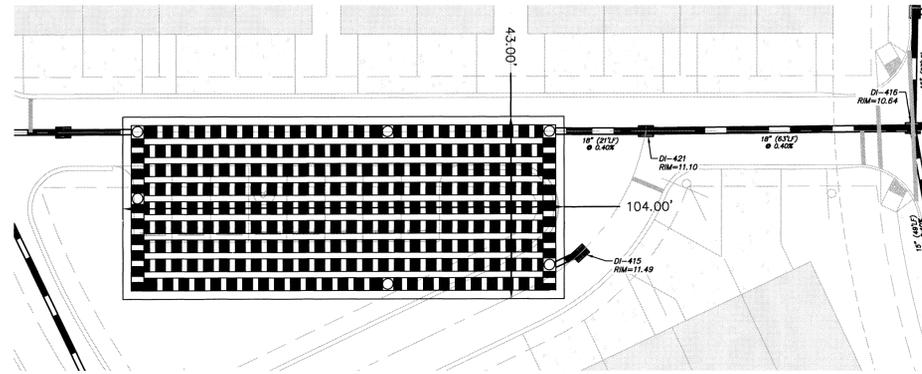


**INFILTRATION GALLERY 4**  
 DA- 188 AC  
 WQV STORAGE REQD.- 5,062 CF  
 STORAGE PROV.- 10,972 CF


PLAN VIEW  
 SCALE: 1" = 20'

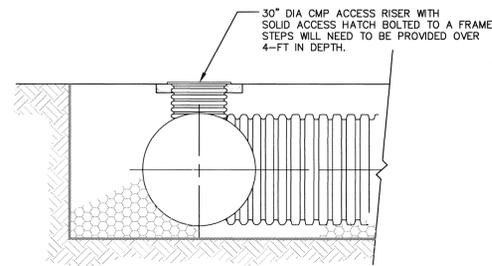


**TYP. CMP ACCESS RISER**  
 NOT TO SCALE

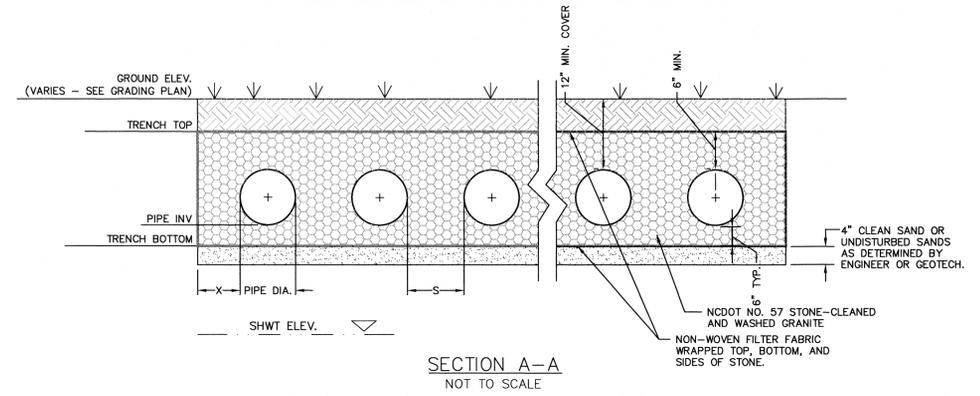

**SECTION A-A**  
 NOT TO SCALE

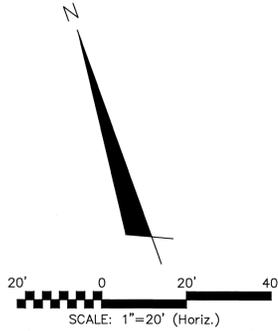

# INFILTRATION GALLERY 5

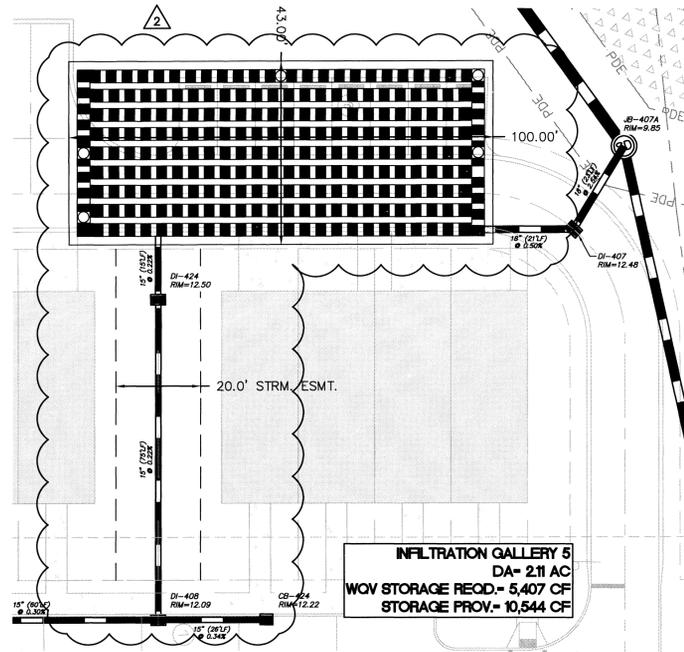


**INFILTRATION GALLERY 5**  
 DA- 2.11 AC  
 WQV STORAGE REQD.- 5,407 CF  
 STORAGE PROV.- 10,544 CF

PLAN VIEW  
 SCALE: 1" = 20'

DESIGN	DI-416	DI-407
RIM ELEVATION	10.64'	11.11'
WEIR ELEVATION	9.00'	9.25'
SUMP ELEVATION	6.34'	6.04'
OUTFALL PIPE INVERT	7.34'	7.10'

DESIGN	INFILTRATION GALLERY 4	INFILTRATION GALLERY 5
# OF RUNS	9	9
LENGTH PER RUN	100'	96'
PIPE DIAMETER (IN)	36"CAP	36"CAP
MIN. X (IN)	2'	2'
MIN. S (IN)	1/2 DIA. OF PIPE	1/2 DIA. OF PIPE
TRENCH WIDTH (FT)	43'	43'
TRENCH LENGTH (FT)	104'	100'
SHWT ELEVATION	4.50'	4.50'
TRENCH BOTTOM ELEVATION	6.50'	6.50'
PIPE TRENCH INVERT	7.00'	7.00'
TRENCH TOP ELEVATION	10.50'	10.50'
10-YR WSEL	9.25'	9.61'

- NOTES:
- SHWT AND HIGH RIVER ELEVATIONS TAKEN FROM SITE & SOILS EVALUATION REPORT BY ECS CAROLINAS, LLP DATED FEBRUARY 18, 2015 FOR NEVLAND COMMUNITIES, LLC.
  - EXISTING ELEVATIONS TAKEN FROM COMBINATION OF FIELD MEASUREMENTS AND TOPOGRAPHY SURVEY BY MCKIM & CREED, INC.

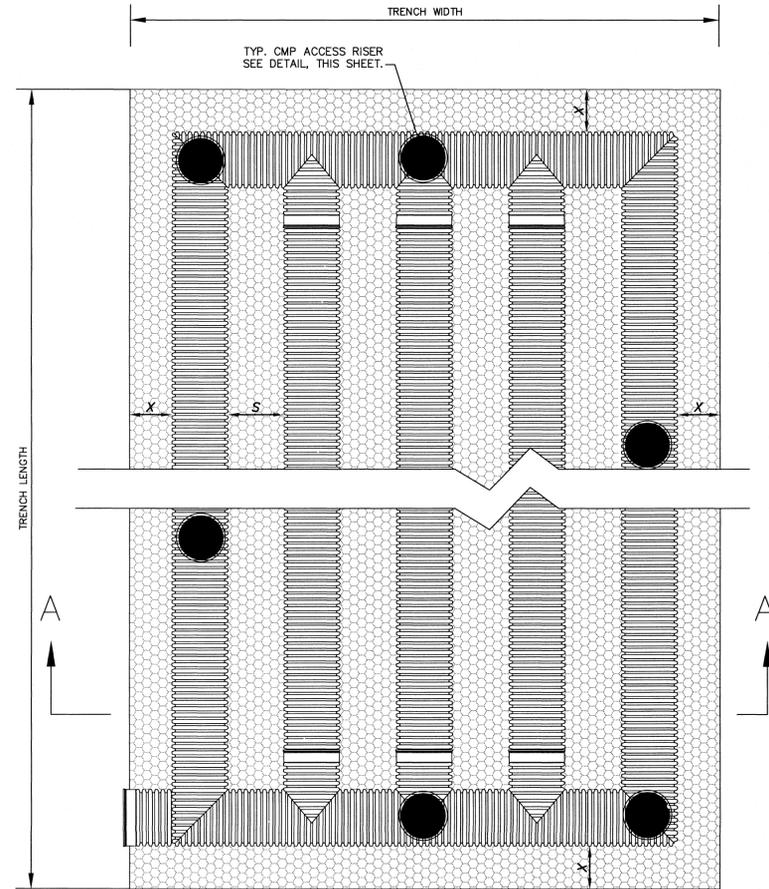


**PLAN VIEW**  
 NOT TO SCALE


NOTES:

- INFILTRATION TRENCH PIPE SHALL BE CONTECH PERFORATED ALUMINIZED OR ALUMINUM CMP PIPE MEETING AASHTO M-36, CLASS 2 PERFORATIONS (3/8" DIA); OR PERFORATED HDPE MEETING AASHTO CLASS 2, TYPE S PERFORATIONS. CONTRACTOR TO SUBMIT INFILTRATION TRENCH SPECIFICATION FOR ENGINEER APPROVAL.
- CMP OR HDPE PIPE TO BE INSTALLED PER ASTM & MANUFACTURER'S RECOMMENDATIONS. PIPE JOINTS TO BE PER MANUFACTURER'S RECOMMENDATIONS AS AN UNDERGROUND INFILTRATION SYSTEM.
- SEE TABLE FOR NUMBER OF PIPE RUNS AND DIMENSIONS.
- IT IS IMPORTANT THAT FILL MATERIAL FOR THE INFILTRATION TRENCHES SHALL BE SAME MATERIAL AS EXISTING SOILS UNDERLYING THE TRENCH. BE SURE NOT TO COMPACT THE SAND UNDER THE TRENCH SO THAT PROPER INFILTRATION RATES CAN OCCUR BELOW THE TRENCHES.

**TYP. INFILTRATION TRENCH SYSTEM**  
 NOT TO SCALE

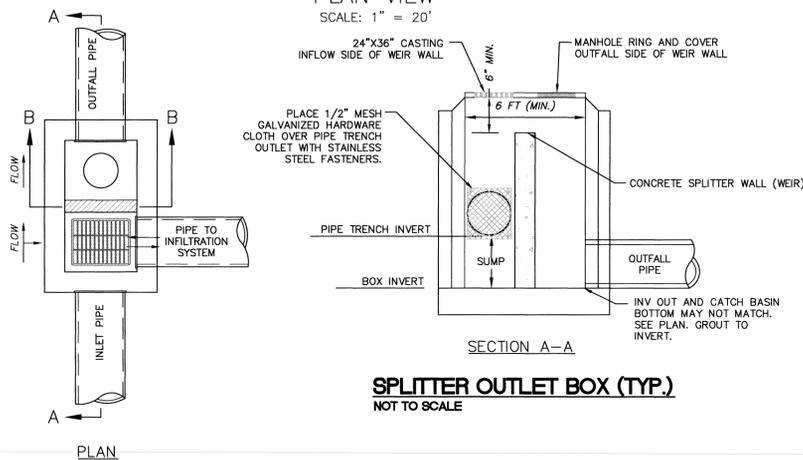

**SPLITTER OUTLET BOX (TYP.)**  
 NOT TO SCALE

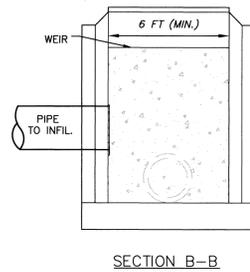

**SECTION B-B**

For each open utility cut of City streets, a \$325 permit shall be required from the City prior to occupancy and/or project acceptance.

1 inch

**Approved Construction Plan**

Name: \_\_\_\_\_ Date: \_\_\_\_\_

Planning: \_\_\_\_\_

Traffic: \_\_\_\_\_

Fire: \_\_\_\_\_

**CITY OF WILMINGTON**  
 NORTH CAROLINA



Public Services - Engineering Division

APPROVED STORMWATER MANAGEMENT PLAN

Date: \_\_\_\_\_ Permit # \_\_\_\_\_

Signed: \_\_\_\_\_

REV. NO.	DESCRIPTIONS / REVISIONS	DATE
2	SITE PLAN AND STORM DRAINAGE REVISIONS	07/19/2016
1	CPLA COMMENTS	04/11/2016
0	ISSUED FOR CONSTRUCTION	03/17/2016

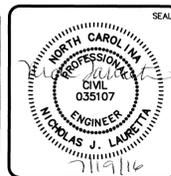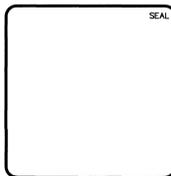

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**RIVERLIGHTS**

NORTH AMERICA SENIUS HOUSE, LLC

**RIVERLIGHTS MARINA VILLAGE**  
 PHASE 1B

**STORMWATER MANAGEMENT DETAILS**

DATE: 17MAR16  
 MCE PROJ. # 2735-0124  
 DRAWN: ALM  
 DESIGNED: NUL  
 CHECKED: KCB  
 PROJ. MGR.: NUL


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STATUS: FINAL DESIGN  
 ISSUED FOR CONSTRUCTION



REVISION: 2

S:\2735\0124 Marina Village\01-Drawings\Phase 1\BCN-501.dwg, 7/18/2016 5:05:41 PM, AMendmal, 11



**CONSTRUCTION ENTRANCE/EXIT**

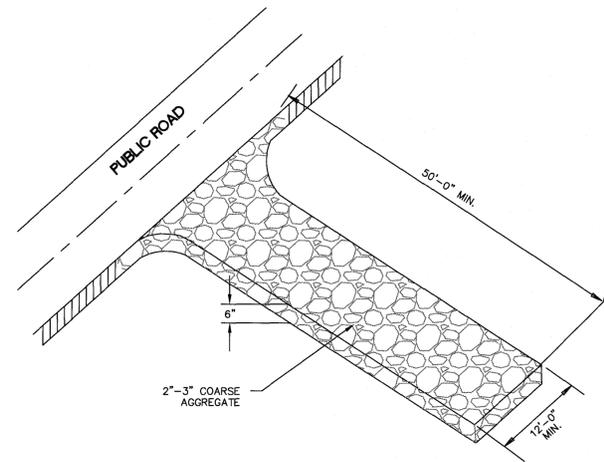SD 13-03  
NOT TO SCALE

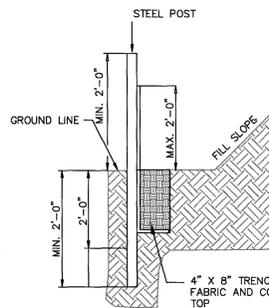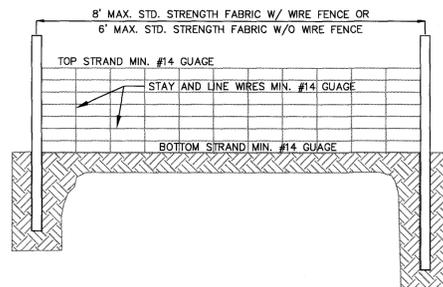


**TEMPORARY SILT FENCE**

NOT TO SCALE

**SILT FENCE CALCULATION TABLE**

SILT FENCE No.	CE-101	CE-102	Drainage Area SF	Drainage Area ac	Length ft	Acre per 100 ft	0.25 Acre per 100 ft YES/NO
SF 1	X	X	2770	0.06	137.00	0.05	YES
SF 2	X	X	3805	0.09	135.00	0.06	YES
SF 3	X	X	13813	0.32	532.00	0.06	YES
SF 4	X	X	10328	0.24	269.00	0.09	YES
SF 5	X	X	4553	0.10	141.00	0.07	YES
SF 6	X	X	1294	0.03	71.00	0.04	YES
SF 7	X	X	21990	0.50	558.00	0.09	YES
SF 8	X	X	5785	0.13	209.00	0.06	YES
SF 9	X	X	14591	0.33	263.00	0.13	YES
SF 10	X	X	1563	0.04	133.00	0.03	YES
SF 11	X	X	22675	0.52	304.00	0.17	YES
SF 13	X	X	1626	0.04	107.00	0.03	YES

NOTE: THE CRITICAL ROOT ZONE (CRZ) OF A TREE IS WHERE THE MAJORITY OF A TREE'S ROOTS LAY. 85% OF MOST TREE ROOTS ARE FOUND IN THE TOP 24" OF THE SOIL AND SUPPLY THE MAJORITY OF NUTRIENTS AND WATER. GENERALLY, ROOTS SPREAD OUT 2-3X THE HEIGHT OF THE TREE.

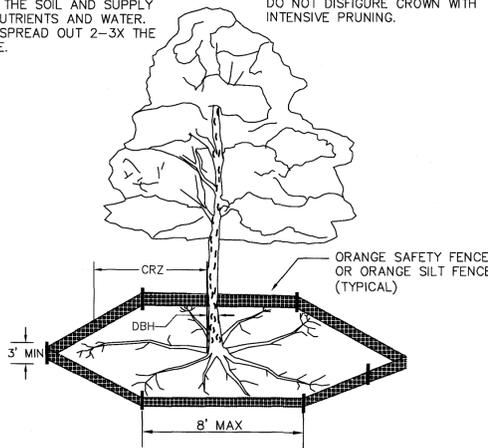

NOTE: CROWN OF THE TREE IS NEEDED FOR LEAF GROWTH TO PRODUCE OXYGEN, FILTER THE AIR, REDUCE WIND AND SOFTEN NOISE. DO NOT DISFIGURE CROWN WITH INTENSIVE PRUNING.

**NOTES:**

- PROTECT CRITICAL ROOT ZONE (CRZ) OF TREES PRIOR TO CONSTRUCTION. CLEARLY MARK THE TREES AND ERECT A PROTECTIVE BARRIER AT THE CRZ. BARRIER SHALL BE MAINTAINED UNTIL CONSTRUCTION IS COMPLETE.
- CRZ RADIUS IS 1 FT PER INCH OF TREE DIAMETER AT BREAST HEIGHT (DBH).
- IF CONSTRUCTION OCCURS WITHIN THE CRZ, AT LEAST 12" OF MULCH AND/OR LOGGING MATS SHALL BE PLACED WHERE THE MACHINERY MANEUVERS TO REDUCE SOIL COMPACTION IN THIS ZONE.
- WHERE SIDEWALKS AND PATHWAYS PASS WITHIN CRZ, EXTRA CARE SHALL BE TAKEN TO AVOID DAMAGE TO THE ROOTS. ALTERNATE CONSTRUCTION METHODS, SUCH AS A REINFORCED SIDEWALK, SHALL BE IMPLEMENTED AS NECESSARY.
- FOR ALL TREES, CUTTING OF LARGE STRUCTURAL ROOTS LOCATED NEAR THE BASE OF THE TRUNK IS PROHIBITED. DO NOT COMPACT SOIL BENEATH TREES. NO VEHICLE SHALL BE ALLOWED TO PARK UNDER TREES. NO MATERIALS OR EQUIPMENT SHALL BE STORED BENEATH TREES. DAMAGING THE BARK WITH LAWNMOWERS, CONSTRUCTION EQUIPMENT, OR ANYTHING ELSE IS PROHIBITED. CONTRACTOR SHALL REPAIR DAMAGE TO TREES.
- FAILING TO INSTALL OR MAINTAIN PROTECTION MEASURES SHALL RESULT IN A STOP WORK ORDER AND FINE OF \$500/DAY. DISTURBANCE OTHER THAN THAT ALLOWED ON THE APPROVED PLAN WILL REQUIRE OWNER TO POST A LETTER OF CREDIT FOR 3 YRS FOR TREE MITIGATION.

**METHOD OF TREE PROTECTION DURING CONSTRUCTION**

SD 15-09  
NOT TO SCALE

**SEEDBED PREPARATION:**

- CHISEL COMPACTED AREAS AND SPREAD TOPSOIL 3 INCHES DEEP OVER ADVERSE SOIL CONDITIONS, IF AVAILABLE.
- RIP THE ENTRANCE AREA TO 6 INCHES DEPTH.
- REMOVE ALL LOOSE ROCK, ROOTS, AND OTHER OBSTRUCTIONS LEAVING SURFACE REASONABLY SMOOTH AND UNIFORM.
- APPLY AGRICULTURAL LIME, FERTILIZER, AND SUPERPHOSPHATE UNIFORMLY AND MIX WITH SOIL (SEE BELOW\*).
- CONTINUE TILLAGE UNTIL A WELL - PULVERIZED, FIRM, REASONABLY UNIFORM SEEDBED IS PREPARED 4 TO 6 INCHES DEEP.
- SEED ON A FRESHLY PREPARED SEEDBED AND COVER SEED LIGHTLY WITH SEEDING EQUIPMENT OR CULTIPACK AFTER SEEDING.
- MULCH IMMEDIATELY AFTER SEEDING AND ANCHOR MULCH.
- INSPECT ALL SEEDED AREAS AND MAKE NECESSARY REPAIRS OR RESEEDINGS WITHIN THE PLANTING SEASON, IF POSSIBLE. IF STAND SHOULD BE OVER 60% DAMAGED, REESTABLISH FOLLOWING ORIGINAL LIME, FERTILIZER AND SEEDING RATES.
- CONSULT CONSERVATION INSPECTOR ON MAINTENANCE TREATMENT AND FERTILIZATION AFTER PERMANENT COVER IS ESTABLISHED.
- APPLY:  
AGRICULTURAL LIMESTONE - 2 TONS/ACRE  
FERTILIZER - 1000 LBS/ACRE (10-10-10)  
SUPERPHOSPHATE - 500 LBS/ACRE (20%)  
MULCH - 2 TONS/ACRE (SMALL GRAIN STRAW)  
ANCHOR - ASPHALT EMULSION AT 450 GAL/ACRE

**TREE PROTECTION NOTES:**




- NO LAND DISTURBANCE INCLUDING TREE REMOVAL IS TO OCCUR OUTSIDE THE LIMITS OF DISTURBANCE SHOWN ON THE PLANS. [18-457(b)]
- PROTECTIVE FENCING IS TO BE PROPERLY MAINTAINED THROUGHOUT THE DURATION OF THE PROJECT. [18-458]
- LAND CLEARING AND CONSTRUCTION CONTRACTORS SHALL RECEIVE ADEQUATE INSTRUCTION ON TREE PROTECTION REQUIREMENTS AND METHODS. [18-457(d)]
- ANY TREES AND/OR AREAS DESIGNATED TO BE PROTECTED MUST PROPERLY BARRICADED WITH FENCING AND PROTECTED THROUGHOUT CONSTRUCTION TO INSURE THAT NO CLEARING AND GRADING OR STAGING OF MATERIALS WILL OCCUR IN THOSE AREAS. [18-458]
- NO EQUIPMENT IS ALLOWED ON THE SITE UNTIL ALL TREE PROTECTION FENCING AND SILT FENCING HAS BEEN INSTALLED AND APPROVED. [18-458]
- REGULATED AND SIGNIFICANT TREES IN THE STREET YARD [18-456(c)] AND ANY TREES IN ANY REQUIRED BUFFERS [18-456(b)] ARE REQUIRED TO BE RETAINED.

**TEMPORARY SEEDING**

GRASS TYPE	AMOUNT / 1000 S.F.	TIME OF SEEDING	INITIAL
RYE GRAIN	1-2 LBS.	APRIL - JUNE	25 LBS. 10-10-10
BROWNTOP MILLET	1-2 LBS	JUNE - AUGUST	25 LBS 10-10-10


**PERMANENT SEEDING**

GRASS TYPE	AMOUNT / 1000 S.F.	TIME OF SEEDING	INITIAL
BERMUDA COMMON	1-2 LBS.	APRIL - JUNE	25 LBS. 10-10-10
FESCUE, TALL (KENTUCKY 31)	5-7 LBS	JUNE - AUGUST FEB. - OCT.	25 LBS 10-10-10
SERICEA LESPEDEZA (SLOPES)	1-2 LBS	MARCH - APRIL	25 LBS 10-10-10

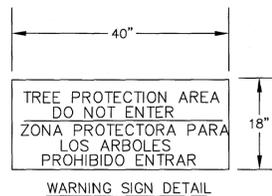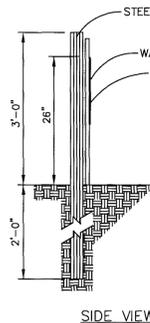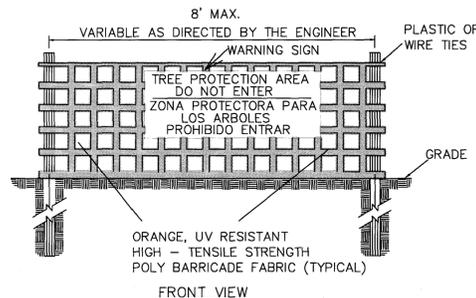

**NOTES:**

- THE TREE PROTECTION FENCING SHALL NOT BE VIOLATED FOR THE ENTIRE DURATION OF THE PROJECT WITHOUT APPROVAL FROM URBAN FORESTRY STAFF.
- WARNING SIGNS TO BE MADE OF DURABLE, WEATHERPROOF MATERIAL. LETTERS TO BE 3" HIGH, MINIMUM, CLEARLY LEGIBLE AND SPACED AS DETAILED.
- SIGNS SHALL BE PLACED AT 50' MAXIMUM INTERVALS. PLACE A SIGN AT EACH END OF LINEAR TREE PROTECTION AND 50' ON CENTER THEREAFTER. FOR TREE PROTECTION AREAS LESS THAN 100' IN PERIMETER, PROVIDE NO LESS THAN TWO SIGNS PER PROTECTION AREA.
- ATTACH SIGNS SECURELY TO FENCE POSTS AND FABRIC. MAINTAIN TREE PROTECTION FENCE AND SIGNS THROUGHOUT DURATION OF PROJECT.
- TREE PROTECTION FENCING AND SIGNAGE SHALL BE REMOVED AFTER CONSTRUCTION.
- ADDITIONAL SIGNS MAY BE REQUIRED BY CITY OF WILMINGTON, BASED ON ACTUAL FIELD CONDITIONS.

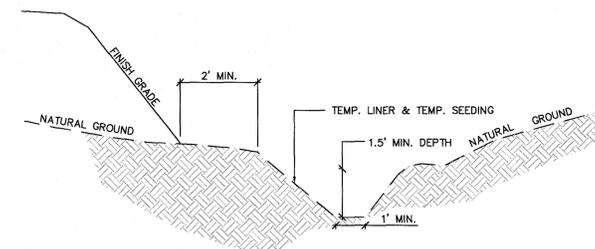

**Temporary Perimeter Dike Calculations**

Perm Dike NUMBER	LENGTH (FT)	HIGH (FT)	LOW (FT)	ELEVATION DIFF. (FT)	SLOPE (%)	VELOCITY (FPS)	LINING	Manning n	TEMPORARY ROCK CHECK DAMS		
									CHECK DAM SPACING (FT)	NUMBER REQUIRED	NUMBER PROVIDED
1	156	12.53	7.00	5.53	3.54	1.41	GRASS	0.035	56	3	3

**TEMPORARY CHANNEL LINER SPECIFICATION:**

- SEE TEMPORARY PERIMETER DIKE CHART FOR LINER TYPE AND CHECK DAM SPACING.
- MIN. SHEAR STRENGTH: STRAW WITH NET (OR APPROVED EQUAL) - 1.45 LBS/FT<sup>2</sup>

\* ALL RATINGS ABOVE ARE MINIMUM SHEAR STRENGTH REQUIREMENTS FOR THE LINER BASED ON UNVEGETATED CONDITIONS.

**CONSTRUCTION SPECIFICATION**


- GRADE THE SURFACE OF INSTALLATION AREAS SO THAT THE GROUND IS SMOOTH AND LOOSE.
- WHEN SEEDING PRIOR TO INSTALLATION, FOLLOW THE STEPS FOR SEED BED PREPARATION, SOIL AMENDMENTS, AND SEEDING AS NOTED IN "SURFACE STABILIZATION 6.1" (GENERAL NOTES) AND AS PER NCDENR STANDARDS.
- SPREAD SEED BEFORE TEMPORARY LINER IS INSTALLED.
- LINER SHALL BE INSTALLED FROM TOP OF BANK TO TOP OF BANK ALONG DIKE WITHIN DENUDED LIMITS.

**MAINTENANCE**

- ALL EROSION CONTROL LINING SHALL BE INSPECTED EVERY SEVEN (7) DAYS OR AFTER EACH RAINFALL OCCURRENCE THAT EXCEEDS ONE-HALF (0.5) INCH.

**TEMPORARY PERIMETER DIKE**

NOT TO SCALE

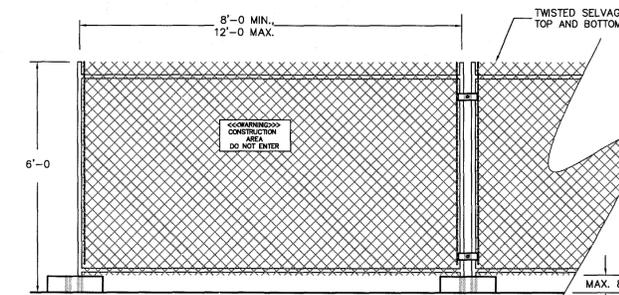

**NOTES:**

- CHAIN LINK FABRIC TO BE MIN. 11 GAUGE, GALVANIZED, NO RUSTED OR EXCESSIVELY MALFORMED FABRIC.
- FENCE BASES SHALL BE OF SUFFICIENT WEIGHT and/or SPREAD TO ADEQUATELY SUPPORT EACH PANEL.
- PANEL-TO-PANEL CONNECTIONS SHALL BE MADE AT A MIN. TWO LOCATIONS PER CONNECTION UNLESS OTHERWISE APPROVED.
- PROVIDE CONSTRUCTION WARNING SIGNAGE 50' O.C. ALONG FENCING INSTALLATION.

**TEMPORARY CONSTRUCTION FENCING**

NOT TO SCALE

For each open utility cut of City streets, a \$325 permit shall be required from the City prior to occupancy and/or project acceptance.

**Approved Construction Plan**

Name \_\_\_\_\_ Date \_\_\_\_\_

Planning \_\_\_\_\_

Traffic \_\_\_\_\_

Fire \_\_\_\_\_

1 inch

**CITY OF WILMINGTON**  
NORTH CAROLINA  
Public Services Engineering Division  
APPROVED STORMWATER MANAGEMENT PLAN  
Date: \_\_\_\_\_ Permit # \_\_\_\_\_  
Signed: \_\_\_\_\_

REV. NO.	DESCRIPTION	DATE
2	SITE PLAN AND STORM DRAINAGE REVISIONS	07/19/2016
1	OPWA COMMENTS	04/11/2016
0	ISSUED FOR CONSTRUCTION	03/17/2016

SEAL  
NORTH CAROLINA PROFESSIONAL ENGINEER  
CIVIL  
035107  
NICHOLAS J. LAURENT  
1/19/16

**MCKIM & CREED**  
243 North Front Street  
Wilmington, North Carolina 28401  
Phone: (910)343-1048, Fax: (910)251-8282  
License: F-1222  
www.mckimcreed.com

**RIVERLIGHTS**  
NORTH AMERICA SENSUS HOUSE, LLC

**RIVERLIGHTS MARINA VILLAGE PHASE 1B**  
**SEDIMENT & EROSION CONTROL DETAILS**

DATE: 17MAR16  
MCE PROJ. # 2735-0124  
DRAWN: ALM  
DESIGNED: NUL  
CHECKED: KOBE  
PROJ. MGR. NUL

SCALE: HORIZONTAL: N/A  
VERTICAL: N/A

M&E FILE NUMBER: CE-501  
DRAWING NUMBER: 25

STATUS: FINAL DESIGN  
ISSUED FOR CONSTRUCTION

REVISION: 2

For each open utility cut of City streets, a \$325 permit shall be required from the City prior to occupancy and/or project acceptance.



1 inch

**Approved Construction Plan**


Name \_\_\_\_\_ Date \_\_\_\_\_  
 Planning \_\_\_\_\_  
 Traffic \_\_\_\_\_  
 Fire \_\_\_\_\_



Public Services Engineering Division  
**APPROVED STORMWATER MANAGEMENT PLAN**  
 Date: \_\_\_\_\_ Permit # \_\_\_\_\_  
 Signed: \_\_\_\_\_

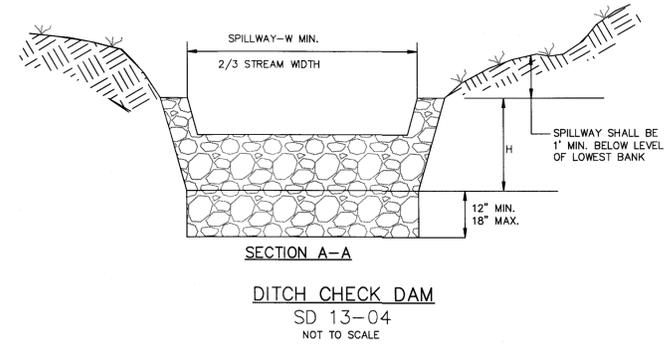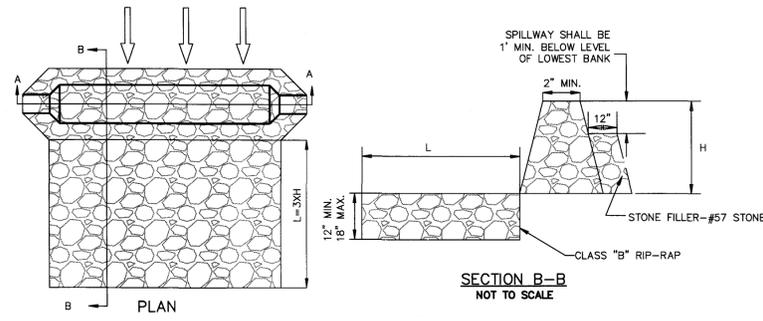

**DITCH CHECK DAM**  
SD 13-04  
NOT TO SCALE

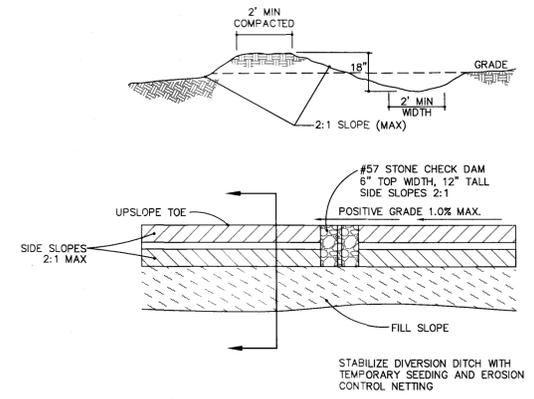


**TEMPORARY DIVERSION DITCH**  
NOT TO SCALE

TDD NUMBER	DA (AC)	Q10 (CFS)	LENGTH (FT)	HIGH (FT)	LOW (FT)	ELEVATION DIFF. (FT)	SLOPE (%)	INITIAL LINING	MANNING n	VELOCITY (FPS)	COMMENT
TDD1	0.25	0.5	158	8.00	4.00	4.00	2.53	BARE EARTH	0.020	2.73	LINING REQ
TDD2	1.25	2.7	231	5.45	4.57	0.88	0.38	BARE EARTH	0.020	2.10	LINING REQ

TDD NUMBER	SECONDARY LINING	MANNING n	VELOCITY (FPS)	COMMENT	DEPTH in	MIN. DEPTH in	CHECK DAM SPACING (FT)	NUMBER REQUIRED	NUMBER PROVIDED
TDD1	LINING REQ	0.035	1.82	EXCELSIOR OK	2.3	18	79	2	2
TDD2	LINING REQ	0.035	1.38	EXCELSIOR OK	7.9	19	525	0	0

Notes:  
 1. Q10 taken from Rational Method.  
 2. Manning n value for bare earth = 0.020 per NC ESC Manual Table 8.05f  
 3. Manning n value for excelsior (curled wood) matting = 0.035 per NC ESC Manual Table 8.05f  
 4. Tractive Force (Shear Stress) was also evaluated and found to be sufficient for the proposed lining.

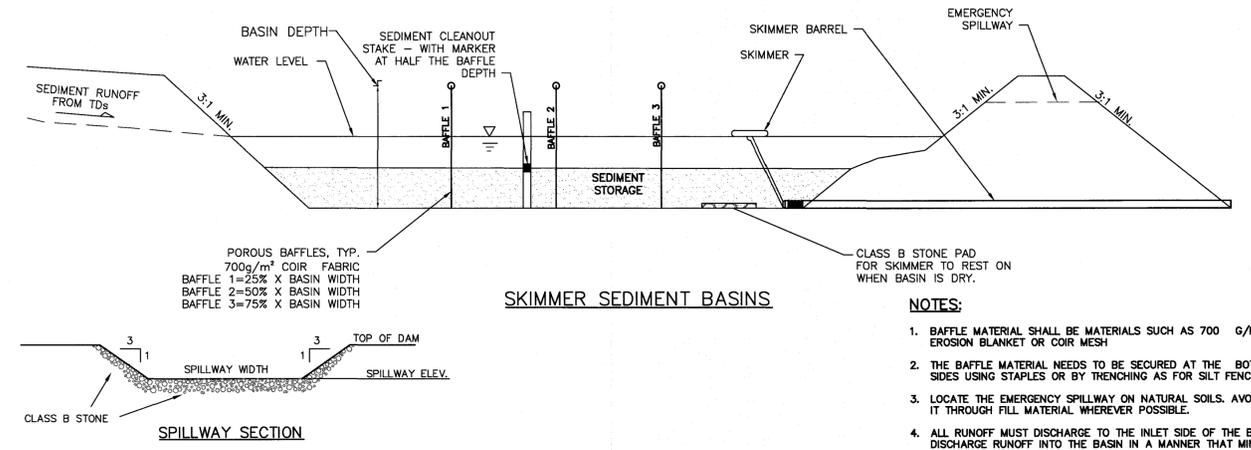

**SKIMMER SEDIMENT BASINS**

- NOTES:**
- BAFFLE MATERIAL SHALL BE MATERIALS SUCH AS 700 G/M COIR EROSION BLANKET OR COIR MESH
  - THE BAFFLE MATERIAL NEEDS TO BE SECURED AT THE BOTTOM AND SIDES USING STAPLES OR BY TRENCHING AS FOR SILT FENCE.
  - LOCATE THE EMERGENCY SPILLWAY ON NATURAL SOILS. AVOID PLACING IT THROUGH FILL MATERIAL WHEREVER POSSIBLE.
  - ALL RUNOFF MUST DISCHARGE TO THE INLET SIDE OF THE BASIN. DISCHARGE RUNOFF INTO THE BASIN IN A MANNER THAT MINIMIZES EROSION.

**SKIMMER BASIN CALCULATION TABLE (PHASE 1)**

Skimmer No.	Drainage Area ac	Rational C	I10 Intensity in/hr	Q10 Peak Flow cfs	Required SA (325 x Q10) sf	Provided SA sf	Required Vol (1800cf/ac x DA) cf	Provided Vol cf	Storage Depth ft	Storage Vol Drained cf	Weir Width ft
SB-1	3.48	0.30	7.23	7.55	2,453	2,584	6,264	6,920	3.00	6,920	8.0


**FAIRCLOTH SKIMMER SIZE CALCULATION (PHASE 1)**

Skimmer No.	Dewatering Time (days)	Skimmer Outflow cf/day	Skimmer Size in	Orifice Diameter in	Orifice Radius in	Barrel Outflow gpm	Barrel Pipe in
SB-1	3	2,307	2.0	1.6	0.8	12.0	4.0

**Faircloth Skimmer Selection Table**


Skimmer Size in	Outflow Qmax cf/day	Head ft
1.5	1,728	0.125
2	3,283	0.167
2.5	6,234	0.208
3	9,774	0.250
4	20,109	0.333
5	32,832	0.333

- NOTES:**
- Q10 Peak Flow were taken from Rational Method.
  - Required Surface Areas and Volumes were taken from NCDENR ESC Manual.
  - Faircloth Skimmer Selection Table taken from Table 4-2. NCDOT Level III-A Design of Sediment & Erosion Control Plans Manual
  - Emergency Weir Width taken from Skimmer Basin Criteria Section of NCDENR ESC Manual Table and/or Hydraulic Routing of the basin to ensure non-erosive velocity.
  - Minimum Barrel Pipe on the Skimmer is 4-inches. (On a 1% slope the capacity is 100 GPM)
  - Skimmer Orifice Diameter/Radius were obtained using the Faircloth Skimmer sizing spreadsheet (obtained from their website: <http://www.fairclothskimmer.com/skimmer-sizing>)

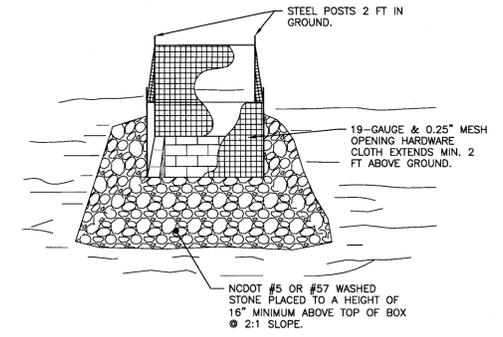

- NOTES:**
- DRIVE 5-FOOT STEEL POSTS (1.25 lb/ft steel) 2 FEET INTO THE GROUND SURROUNDING THE INLET. SPACE POSTS EVENLY AROUND THE PERIMETER OF THE INLET, A MAXIMUM OF 4 FEET APART.
  - SURROUND THE POSTS WITH AT LEAST 19-GAUGE HARDWARE CLOTH WITH A 1/4-INCH MESH OPENING. SECURE THE WIRE MESH TO THE STEEL POSTS AT THE TOP, MIDDLE, AND BOTTOM FOR A MIN. 2 FEET ABOVE THE GROUND. PLACING A 2-FOOT FLAP OF THE WIRE MESH UNDER THE GRAVEL FOR ANCHORING AND REMOVAL IS RECOMMENDED.
  - UNIFORMLY GRADE A SHALLOW DEPRESSION APPROACHING THE INLET. THE TOP ELEVATION OF THE STRUCTURE MUST BE AT LEAST 12-INCHES LOWER THAN THE SURROUNDING GROUND ELEVATION DOWNSLOPE FROM THE INLET TO ENSURE THAT STORM FLOWS GET INTO THE INTENDED INLET; UNLESS OTHER SEDIMENT-CONTROL DEVICES ARE INSTALLED TO PREVENT OFF-SITE SEDIMENT-RUNOFF.

**TEMP. STORM DRAIN INLET PROTECTION**  
NOT TO SCALE

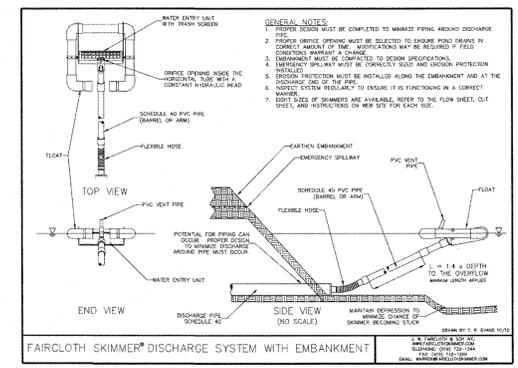

**SKIMMER DETAIL WITH EMBANKMENT**  
NOT TO SCALE

REV. NO.	DESCRIPTIONS	DATE
2	SITE PLAN AND STORM DRAINAGE REVISIONS	07/19/2016
1	CPWA COMMENTS	04/17/2016
0	ISSUED FOR CONSTRUCTION	03/17/2016



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**RIVERLIGHTS**  
 NORTH AMERICA SENSUIV HOUSE, LLC

**RIVERLIGHTS MARINA VILLAGE PHASE 1B**  
**SEDIMENT & EROSION CONTROL DETAILS**

DATE: 17MAR16  
 MCE PROJ. #: 2735-0124  
 DRAWN: ALM  
 DESIGNED: NUL  
 CHECKED: KCB  
 PROJ. MGR: NUL

SCALE: HORIZONTAL: N/A, VERTICAL: N/A

MAC FILE NUMBER: CE-502  
 DRAWING NUMBER: 26  
 REVISION: 2

STATUS: FINAL DESIGN  
 ISSUED FOR CONSTRUCTION